State of Rhode Island
Coastal Resources Management Council
Oliver H. Stedman Government Center
4808 Tower Hill Road, Suite 3
Wakefield, RI 02879
(401)783-3370

State of Rhode Island Department of Environmental Management Office of Technical and Customer Asst. 235 Promenade Street Providence, RI 02908-5767 (401)222-6822

JOINT PUBLIC NOTICE

CRMC File No.:	2023-05-109	Date:_	November 6, 2023	
RIDEM Water Qua	ılity Certification Number:	23-07	75	
These offices have under consideration the application of:				
Rholen West, LLC 99 Poppasquash Road Bristol, RI 02809				
and a State of R Maintenance Act of Island General Lav	Island Assent (in accordance with hode Island Dredge Permit (in of 1996 and the Marine Waterway ws Chapter 46-6.1) and State of Ihapter 42-35 pursuant to Chapters	accordance s and Boatin Rhode Island	with the Marina infrastructure ig Facilities Act of 2001, Rhode Water Quality Certification (in	
The project will include maintenance dredging on approximately 1,360 cubic yards of material within a slide slopes and 1-foot over depth. The dredge material is proposed for disposal at the State's Confined Aquatic Disposal (CAD) Cell in the Providence River.				
Project Location:	99 Poppasquash Road			
Street & Number:	99 Poppasquash Road			
City/Town:	Bristol			
Plat Number: 182		Lot Number:	1	
Waterway: Bri	istol Harbor	_		

Plans of the proposed work may be seen at the CRMC office in Wakefield.

In accordance with the Administrative Procedures Act (Chapter 42-35 of the Rhode Island General Laws) you may request a hearing on this matter. You are advised that if you have good reason to enter protests against the proposed work it is your privilege to do so. It is expected that objectors will review the application and plans thoroughly, visit site of proposed work if necessary, to familiarize themselves with the conditions and cite what law or laws, if any, would in their opinion be violated by the work proposed.


RICRMC/RIDEM Joint Public Notice CRMC File No. 2023-05-109 November 6, 2023 Page Two

This also serves as notice that the Rhode Island Department of Environmental Management, Office of Water Resources, Water Quality Certification Program has under consideration and review the same proposed activity as described above for compliance with the State's Water Quality Regulations (AUTHORITY: in accordance with Clean Water Act, as amended (33 U.S.C. 1251 et.seq.; Chapter 42-35 pursuant to Chapters 46-12 and 42-17.1 of the Rhode Island General Laws of 1956, as amended).

If you desire to protest, you must attend the scheduled hearing and give sworn testimony. A notice of the time and place of such hearing will be furnished you as soon as possible after receipt of your request for hearing. If you desire to request a hearing, to receive consideration, it should be in writing and be received at this office on or before

November 21, 2023

It is expected that objectors will review the application and associates plans thoroughly. Comments that pertain to this Joint Notice must be submitted in writing and must be addressed to Rhode Island Coastal Resources Management Council and Rhode Island Dept of Environmental Management at the above referenced addresses.

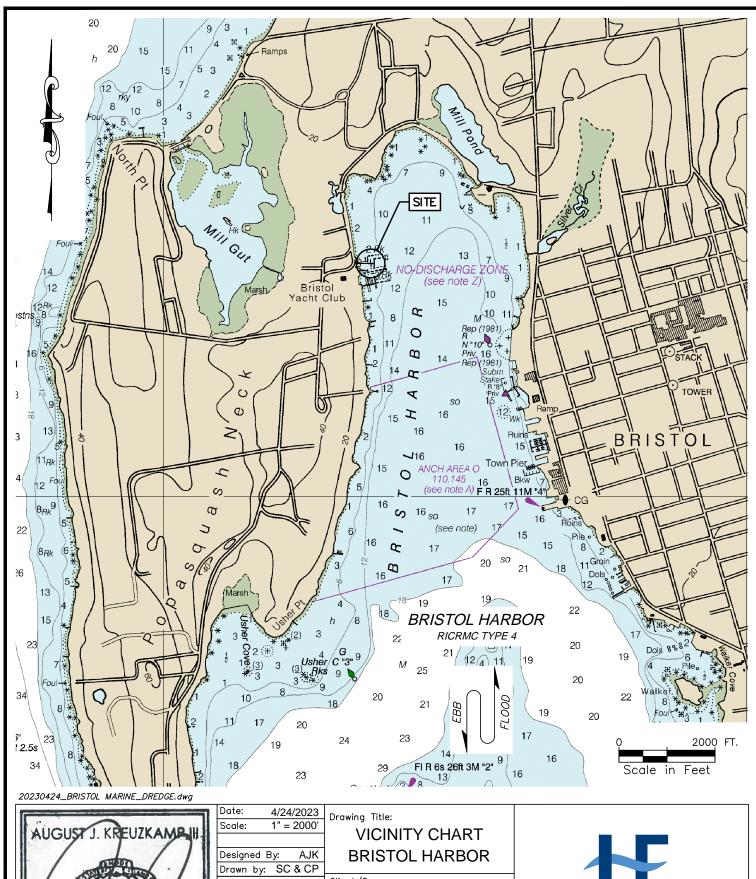



Scale: 1" = 2000'		
Designed By: AJK		
Drawn by: SC & CP		
Checked by:		
Project Number:		
2021-05		

Sheet 1 of 6

C-1

Drawing Number:

BRISTOL MARINE 99 POPPASQUASH ROAD BRISTOL, RI 02809

Issued for:

REGULATORY REVIEW PROPOSED DREDGING TRAVEL LIFT CHANNEL



HARBOR ENGINEERING, LLC

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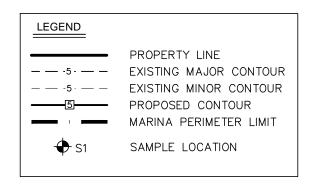
CHART & BENCHMARK REFERENCES:

- NAVIGATION CHART PRESENTED HEREIN WAS OBTAINED FROM NOAA CHART #13224 FOR THE PROVIDENCE RIVER AND THE HEAD OF NARRAGANSETT BAY. SOUNDINGS INCLUDED ON THE CHART REFER TO MEAN LOWER LOW WATER (MLLW) DATUM.
- 2. STILLWATER LEVEL (SWL) ELEVATIONS WERE OBTAINED FROM TRANSECT #14 FROM THE FLOOD INSURANCE STUDY (FIS) FOR BRISTOL COUNTY, RHODE ISLAND [STUDY #44001CV000B] PREPARED BY FEMA DATED 7/7/2014. SWL ELEVATIONS DO NOT INCLUDE WAVE ACTION AND WERE CONVERTED FROM NAVD88 TO MLLWD BY ADDING 2.3 FEET.
- 3. THE BASE FLOOD ELEVATION, WHICH INCLUDES STORM SURGE AND ASSOCIATED WAVE ACTION, WAS OBTAINED FROM THE FLOOD INSURANCE RATE MAP (FIRM) #44001C0013H FOR BRISTOL COUNTY, RHODE ISLAND PREPARED BY FEMA DATED 7/7/2014. THE ELEVATION OF THE BASE FLOOD ELEVATION WAS CONVERTED FROM NAVD88 TO MILLWD BY ADDING 2.3 FEET..
- 4. TIDAL ELEVATIONS WERE OBTAINED FROM NOAA VDATUM ONLINE TOOL USING LAT/LONG COORDINATES IN THE VICINITY OF THE PROJECT AREA.

SITE PLAN NOTES:

- 1. SITE INFORMATION, INCLUDING PROPERTY LINES, BUILDINGS, UTILITIES, AND THE AUTHORIZED MARINA PERIMETER LIMIT (MPL) ASSOCIATED WITH THE BRISTOL MARINE PROPERTY, WAS OBTAINED FROM TWO SOURCES:
- 1.1. CAD FILE PROVIDED BY BRISTOL MARINE. THE CAD FILE INCLUDED THE PLAN TITLE "EXISTING CONDITIONS" FOR THE COASTAL RESOURCES MANAGEMENT COUNCIL CATEGORY B APPLICATION ASSOCIATED WITH THE BRISTOL MARINA EXPANSION PREPARED BY NORTHEAST ENGINEERS & CONSULTANTS, INC. DATED OCTOBER 1, 2004.
- 1.2. SITE PLAN TITLED "PLAN OF LAND SHOWING EXISTING CONDITIONS AND TOPOGRAPHY" PREPARED BY SOUTH COUNTY SURVEY COMPANY DATED JULY 9, 2022 BASED ON FIELDWORK PERFORMED ON JUNE 22, 2022.
- 2. HYDROGRAPHIC CONTOURS WERE DEVELOPED AND PROVIDED BY STEELE ASSOCIATES MARINE CONSULTANTS, LLC ON MAY 11, 2015 AND JUNE 4, 2015 AND CAN ONLY REFLECT THE CONDITIONS OF THE SITE AT THAT TIME.

TIDAL DATUM TABLE (NO	T TO SCALE)	
MEAN HIGHER HIGH WATER (MHHW)	MLLW +4.4'	NAVD88 +2.1'
MEAN HIGH WATER (MHW)— NORTH AMERICAN VERTICAL DATUM+1988 (NAVD88)—	+4.2'	0.0
MEAN LOW WATER (MLW) — MEAN LOWER LOW WATER (MLLW) —	+0.2'	-2.1' -2.3'





20230424_BRISTOL MARINE_DREDGE.dwg





Date: 4/24/2023	Drawing Title:
Scale: N/A	
	NOTES
Designed By: AJK	
Drawn by: SC & CP	
Checked by:	Client/Owner:
	BRISTOL MARINE
	99 POPPASQUASH ROAD
Project Number:	BRISTOL, RI 02809
2021-05	Issued for:
Sheet 2 of 6	REGULATORY REVIEW
Drawing Number:	PROPOSED DREDGING
N-1	TRAVEL LIFT CHANNEL
•	



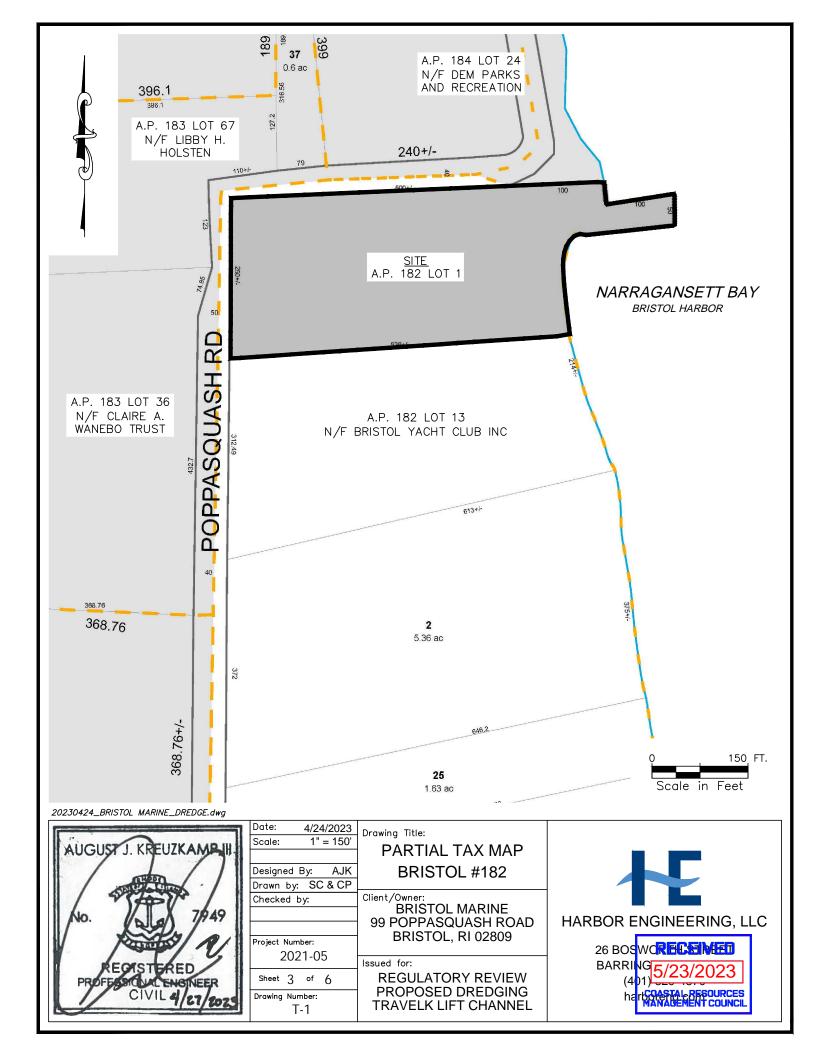


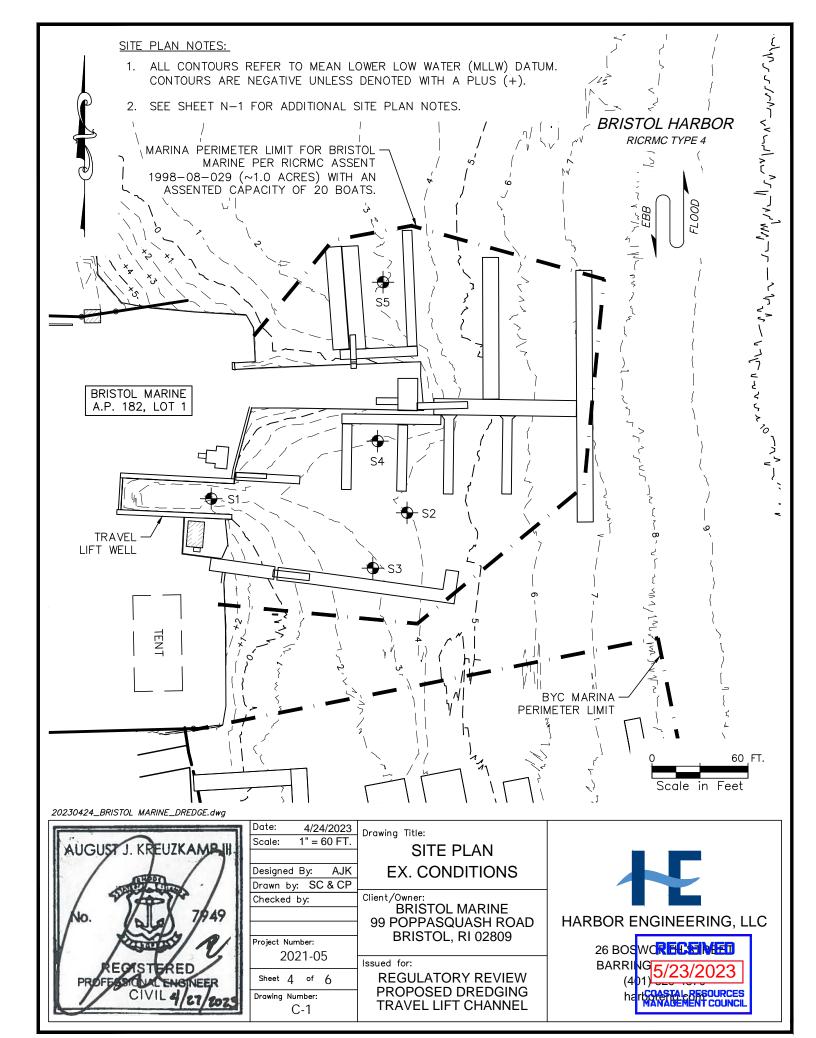

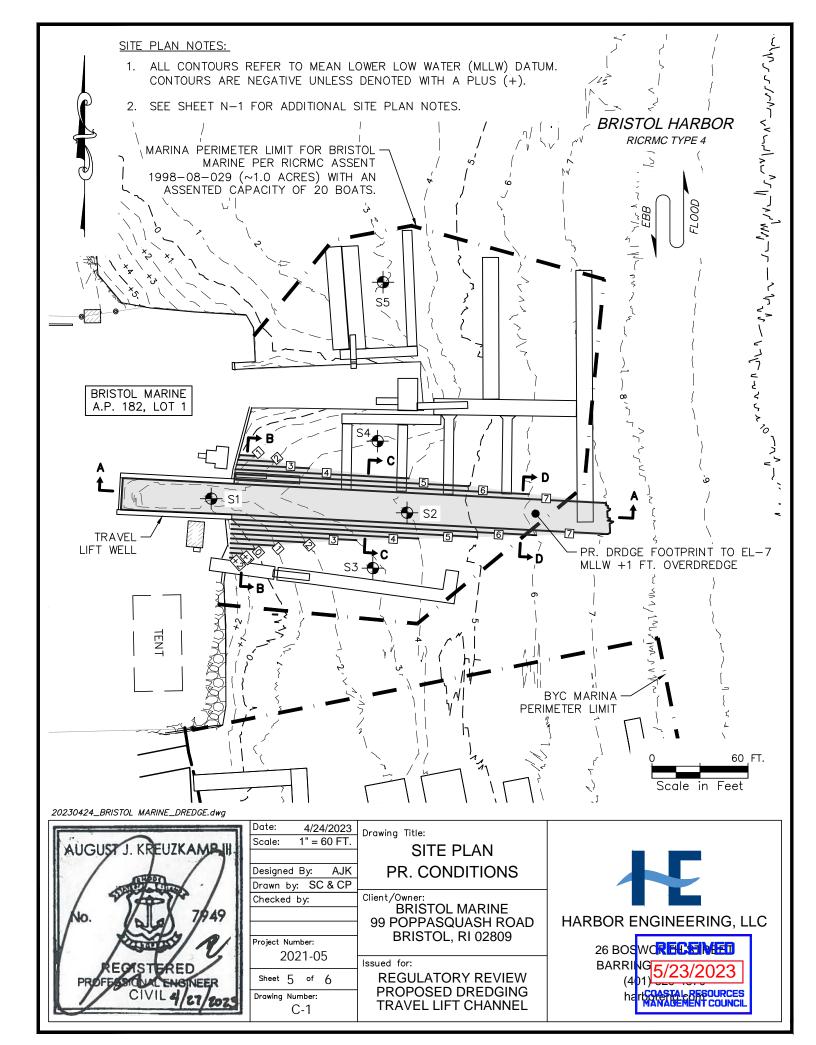


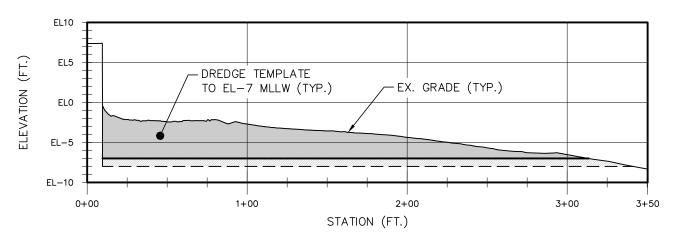

SECTION A-A PROFILE SCALE 1" = 60 FT.

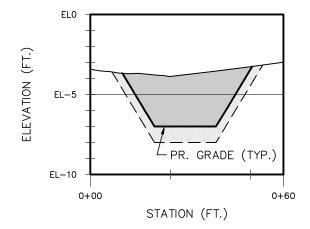


SECTION C-C PROFILE SCALE 1" = 30 FT.

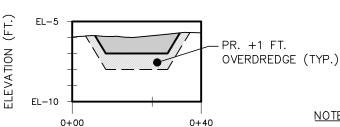

SECTION D-D PROFILE SCALE 1" = 30 FT.

STATION (FT.)

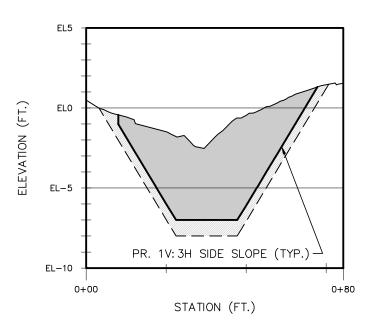

NOTES:

- ELEVATIONS REFER TO MEAN LOWER LOW WATER (MLLW) DATUM.
- VERTICAL AXIS ON PROFILE GRIDS ARE SCALED 1:5 RELATIVE TO HORIZONTAL AXIS FOR BETTER VISUALIZATION.

20230424_BRISTOL MARINE_DREDGE.dwg



Date: 4/24/2023 Scale: AS NOTED Designed By: Drawn by: SC & CP Checked by: Project Number: 2021-05 Sheet 6 of 6 Drawing Number: S-1

Drawing Title:

PR. DREDGING **CROSS SECTIONS**

BRISTOL MARINE 99 POPPASQUASH ROAD BRISTOL, RI 02809

Issued for:

REGULATORY REVIEW PROPOSED DREDGING TRAVEL LIFT CHANNEL



SECTION B-B PROFILE SCALE 1" = 30 FT.

HARBOR ENGINEERING, LLC

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