

State of Rhode Island Coastal Resources Management Council Oliver H. Stedman Government Center 4808 Tower Hill Road, Suite 3 Wakefield, RI 02879-1900

(401) 783-3370 Fax (401) 783-2069

PUBLIC NOTICE

File Number: 2024-02-046

Date: March 25, 2024

This office has under consideration the application of:

Town Of Bristol c/o Steven Contente 10 Court Street Bristol, RI 02809

for a State of Rhode Island Assent to construct and maintain: a new boat ramp and public recreational boating facility. The existing concrete boat ramp and floating dock is proposed to be removed and replaced with a new cast in place concrete ramp with rip rap slope stabilization and a new 10ft x 120ft floating dock. The facility is proposed to extend approximately 75ft beyond mean low water achieving a water depth of approximately 7.5 feet.

Project Location:	Thames Street
City/Town:	Bristol
Plat/Lot:	Plat 8, lot 12
Waterway:	Bristol Harbor

Plans of the proposed work can be requested at <u>Cstaff1@crmc.ri.gov</u>.


In accordance with the Administrative Procedures Act (Chapter 42-35 of the Rhode Island General Laws) you may request a hearing on this matter.

You are advised that if you have good reason to enter protests against the proposed work it is your privilege to do so. It is expected that objectors will review the application and plans thoroughly, visit site of proposed work if necessary, to familiarize themselves with the conditions and cite what law or laws, if any, would in their opinion be violated by the work proposed.

If you desire to protest, you must attend the scheduled hearing and give sworn testimony. A notice of the time and place of such hearing will be furnished you as soon as possible after receipt of your request for hearing. If you desire to request a hearing, to receive consideration, it should be in writing (with your correct mailing address, e-mail address and valid contact number) and be received at this office on or before _____April 25, 2024__.

Please email your comments/hearing requests to: <u>cstaff1@crmc.ri.gov</u>; or mail via USPS to: Coastal Resources Management Council; O. S. Government Center, 4808 Tower Hill Road, Rm 116; Wakefield, RI 02879.



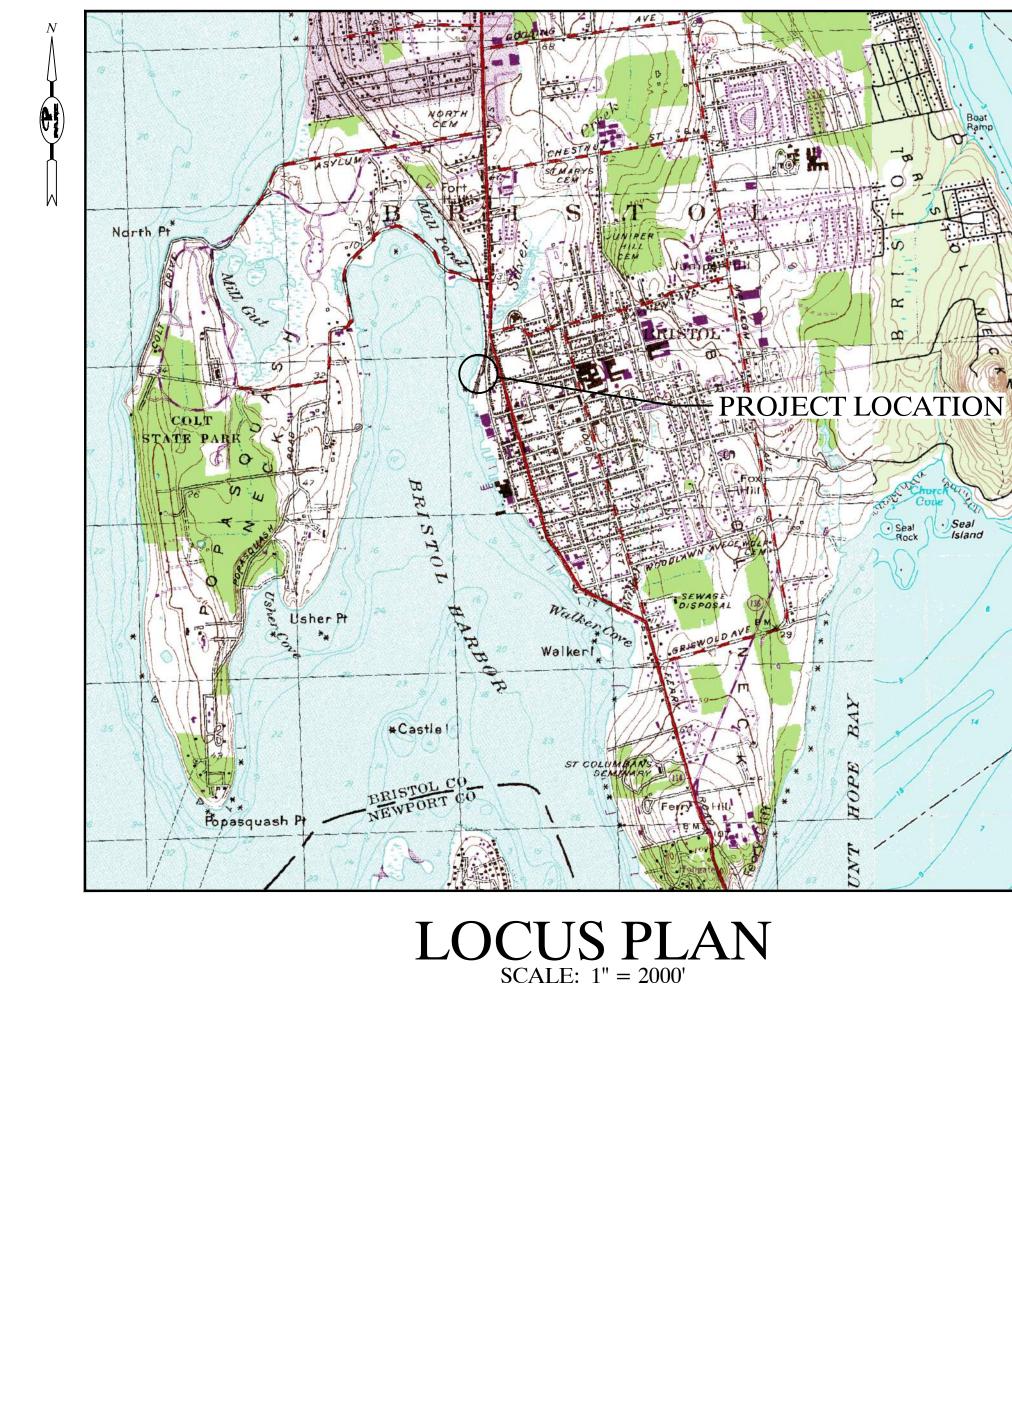

Prepared for The: TOWN OF BRISTOL, RHODE ISLAND BRISTOL INDEPENDENCE PARK **BOAT RAMP IMPROVEMENTS**


BRISTOL, RHODE ISLAND

FEBRUARY 2024

Drawing Index


- 0.0 COVER EXISTING CONDITIONS BY PRINCPE COMPANY INC. **GENERAL NOTES** 1.0 **EXISTING SITE PLAN** 2.0PROPOSED SITE PLAN 2.1 BOAT LAUNCH FLOATS AND RAMP PLAN 2.2 PRE-CAST RAMP DETAILS 2.3 CAST-IN-PLACE RAMP DETAILS 2.4 PROPOSED REVETMENT PLAN AND SECTIONS 2.5
- TIMBER FLOAT SECTIONS AND DETAILS 2.6


Prepared by: PARE CORPORATION Foxboro, Massachusetts

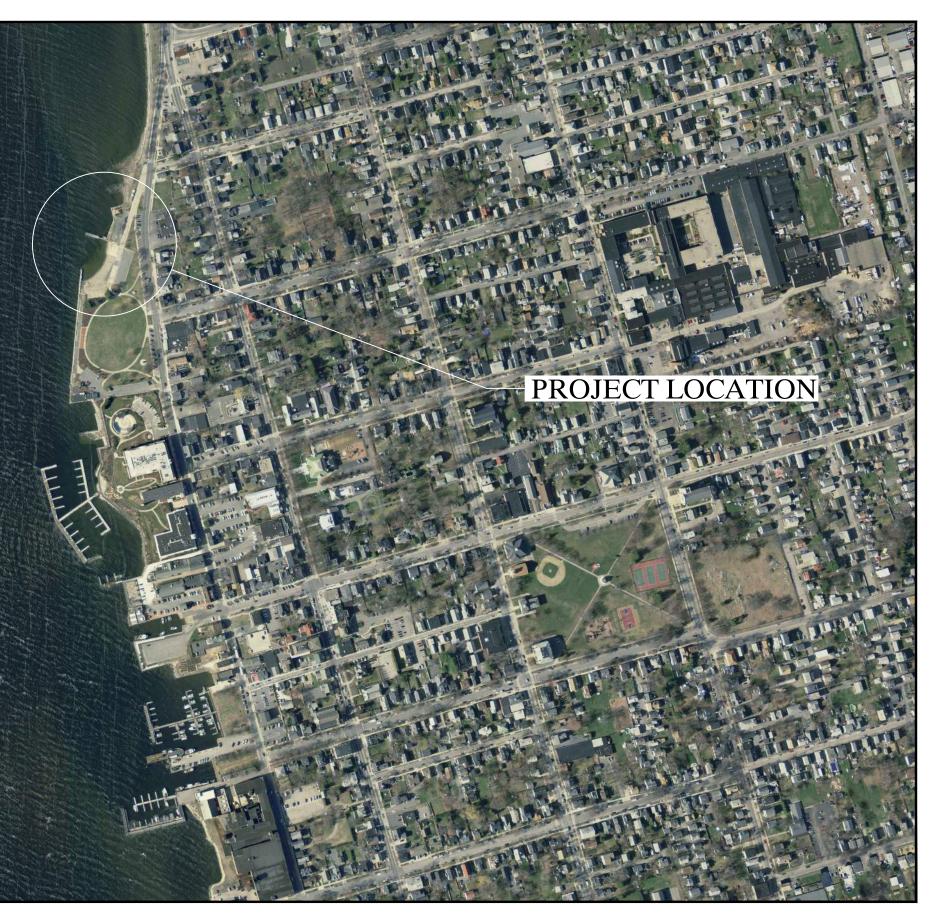





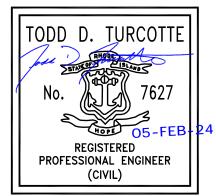

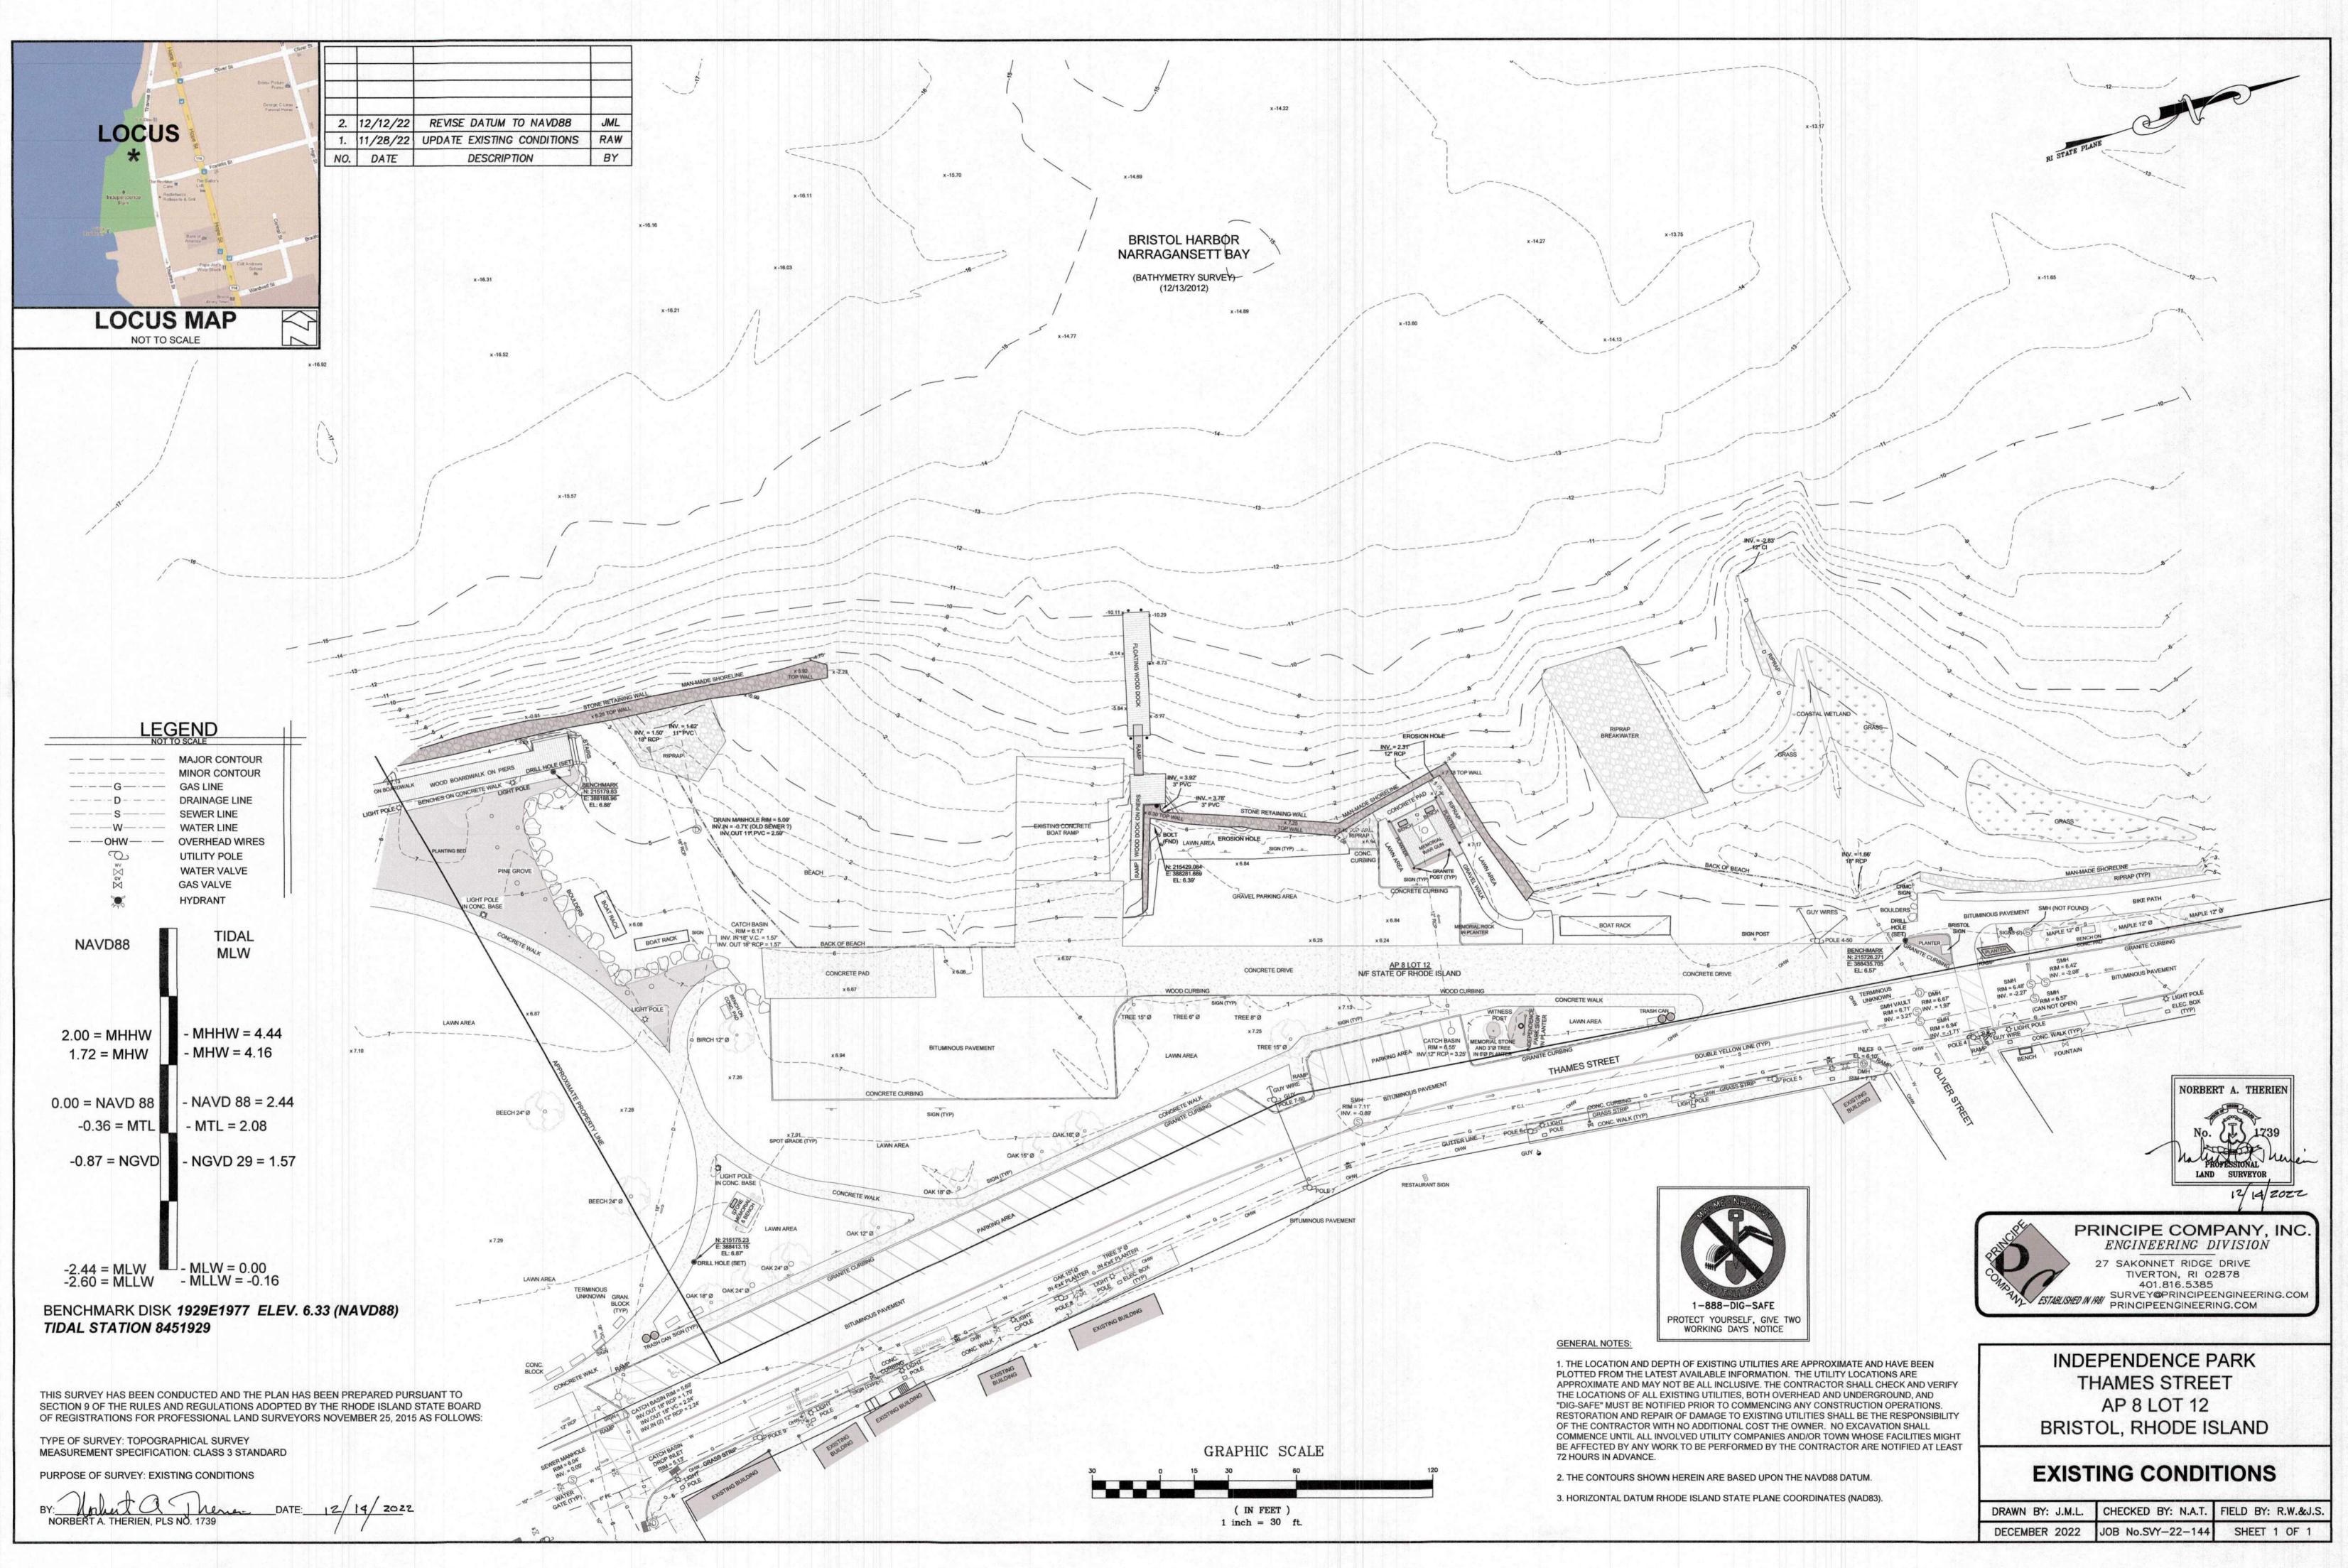

GEN	NERAL NOTES:	CON	CRETE NOTES:
1.	FOR THE PURPOSE OF THIS PROJECT	1.	CONCRETE WORK SHAL CONCRETE" AND THE R
	OWNER - TOWN OF BRISTOL 10 COURT STREET BRISTOL, RI 02809	2.	CONCRETE SHALL BE P
	ENGINEER - PARE CORPORATION 10 LINCOLN ROAD, SUITE 210 FOXBORO, MA 02035	3.	CONCRETE SHALL BE N OF 5,000 PSI. ALL CONC
	CONTACT - RYAN MCCOY	4.	ALL CONCRETE SHALL I
	ALL CONSTRUCTION INDICATED ON THESE PLANS SHALL BE PERFORMED IN ACCORDANCE WITH THE LATEST EDITION OF THE RHODE ISLAND STATE BUILDING CODE, ALL FEDERAL AND MUNICIPAL BUILDING CODES, AND THE SPECIFICATIONS INCLUDED IN THIS CONTRACT. THESE PLANS ARE INCOMPLETE UNLESS ACCOMPANIED BY THE SPECIFICATIONS INCLUDED IN THE CONTRACT DOCUMENTS.	 ALL EXPOSED EDGES WHEN CONCRETE IS P 	
	THE BASE PLAN WAS DEVELOPED BASED UPON THE SURVEY PERFORMED BY PRINCIPE COMPANY INC., IN DECEMBER 2022 AND THE SITE PLAN (SHEET 1 OF 2) OF THE PROJECT TITLED "PROPOSED IMPROVEMENTS STATE STREET PIER, TOWN OF BRISTOL, RI" BY CAPUTO AND WICK LTD., RI, DATED MAY 2011. ANY DISCREPANCIES ON THESE PLANS WITH REGARD TO DIMENSIONS OR CONDITIONS SHALL BE	AND INTENTIONALLY R 7. CONCRETE WASHOUT	
	BROUGHT TO THE ATTENTION OF THE ENGINEER BEFORE PROCEEDING WITH THE AFFECTED PORTION OF WORK. THE VERTICAL DATUM IS NAVD88; HORIZONTAL DATUM IS RHODE ISLAND STATE PLANE NAD83. CONTRACTOR SHALL ESTABLISH	CON	CRETE REINFORCING NO
	HORIZONTAL AND VERTICAL CONTROL AS REQUIRED TO ENABLE COMPLETION OF THE WORK.	1.	REINFORCING BARS SH AND THE RHODE ISLAN
	INSTALL PROPER CONSTRUCTION AND TRAFFIC SIGNAGE AT OR NEAR THE PROJECT ENTRANCES(S). COORDINATE WITH LOCAL POLICE WHEN CONSTRUCTION VEHICLE ACTIVITIES OR DELIVERIES COULD POTENTIALLY IMPEDE NORMAL DAILY TRAFFIC AND PEDESTRIAN TRAFFIC.	2.	COMPLETE SHOP DRAW SUBMITTED TO THE ENO MUST BE SHOWN ON TH
	ENSURE THAT ADEQUATE SHORING AND FALSEWORK ARE PROVIDED TO THE EXISTING STRUCTURE(S) RESULTING IN A STABLE AND SAFE	3.	REINFORCING BARS SH
	STRUCTURE AT ALL TIMES. CONTRACTOR IS ADVISED THAT THE EXISTING SEAWALL IS DETERIORATED, THEREFORE THE STRUCTURAL CAPACITY OF THE RETAINING SYSTEM IS REDUCED.	4.	ALL SUPPORTS SUCH A SHALL BE MADE OF 4,00
	CONDITIONS AS INDICATED ON THE CONTRACT DRAWINGS ARE GENERAL IN NATURE. THE AGE AND SUBSEQUENT REPAIR AND RECONSTRUCTION OF VARYING ELEMENTS COMPRISING THE SEAWALL HAVE RESULTED IN VARIOUS CONDITIONS. THE CONTRACTOR SHALL VISIT AND INSPECT THE SITE TO DETERMINE THE EXTENT AND AMOUNT OF DEMOLITION AND REPAIR WORK TO BE PERFORMED BEFORE SUBMITTING THEIR BID.	5.	UNLESS NOTED ON THE SHALL BE AS FOLLOWS
•	PLANS AND SECTIONS ARE APPROXIMATE AND ARE TO BE USED FOR GENERAL LAYOUT. THE CONTRACTOR WILL BE RESPONSIBLE FOR MAKING FIELD MEASUREMENTS TO ASSURE CONSISTENCY WITH THE PROPOSED CONSTRUCTION PLANS. THE CONTRACTOR SHALL FIELD VERIFY ACTUAL CONDITIONS, DIMENSIONS, CLEARANCES, ELEVATIONS, AND OTHER INFORMATION INDICATED IN THE DOCUMENTS PRIOR		A. FORMED CONCRIB. CONCRETE CAST
	TO ORDERING ANY MATERIALS, COMMENCING ANY FABRICATIONS, OR PERFORMING ANY WORK. THE CONTRACTOR SHALL NOTIFY THE ENGINEER OF ANY FIELD CONDITIONS WHICH MAY DIFFER FROM THAT REPRESENTED PRIOR TO COMMENCING WORK.	6.	MINIMUM REINFORCEM
).	PRIOR TO COMMENCING WORK, THE CONTRACTOR SHALL VISIT THE SITE AND SHALL NOTIFY THE ENGINEER OF ANY ADDITIONAL UTILITIES, STRUCTURES, OR ANY OTHER ELEMENTS THAT MAY IMPEDE WORK. UTILITY AND/OR STRUCTURE RELOCATIONS, IF NECESSARY, SHALL BE COORDINATED THROUGH THE OWNER'S ENGINEER AT NO ADDITIONAL COST TO THE OWNER.	7.	ALL REINFORCEMENT S
1.	THE CONTRACTOR SHALL BE RESPONSIBLE FOR VERIFYING ALL DIMENSIONS. PLANS SHALL NOT BE SCALED FOR DIMENSIONS.		DISCONTINUOUS ENDS.
•	NOTES, TYPICAL DETAILS AND SCHEDULES APPLY TO ALL WORK UNLESS OTHERWISE NOTED. FOR CONDITIONS NOT SPECIFICALLY SHOWN, PROVIDE DETAILS OF SIMILAR NATURE. VERIFY APPLICABILITY BY SUBMITTING SHOP DRAWINGS FOR REVIEW.	<u>LUM</u>	BER NOTES:
	THE CONTRACTOR SHALL BE RESPONSIBLE FOR DISPOSAL OF ALL PROJECT DEMOLITION AND EXCESS MATERIAL IN ACCORDANCE WITH LOCAL, STATE, AND FEDERAL LAWS.	1.	ALL NEW LUMBER SHAL
4.	THE CONTRACTOR SHALL PROTECT ALL ADJACENT STRUCTURES AND UTILITIES. THE CONTRACTOR SHALL BE RESPONSIBLE FOR REPAIR OF ALL DAMAGE TO ADJACENT STRUCTURES AND UTILITIES AT NO ADDITIONAL COST TO THE OWNER.	2.	NEW LUMBER SHALL BE STANDARD C18 UNLESS
5.	THE CONTRACTOR WILL BE REQUIRED TO SUBMIT A CONSTRUCTION SCHEDULE TO THE OWNER WITHIN 5 DAYS OF THE NOTICE OF AWARD.	3.	ALL FIELD CUTS AND BO
	THE CONTRACTOR SHALL UPDATE SCHEDULE AS NEEDED THROUGHOUT THE COURSE OF WORK.	4.	LUMBER DIMENSIONS P
ò.	CONTRACTOR'S STORAGE AREA: DUE TO THE SITE'S WATERFRONT LOCATION, ALL NECESSARY MEASURES SHALL BE TAKEN TO PREVENT BY ANY METHOD, OIL, CONSTRUCTION DEBRIS, STOCKPILED MATERIALS, AND OTHER MATERIALS ON THE SITE, FROM ENTERING THE WATERWAY. ANY DEBRIS FALLING INTO THE WATER SHALL BE RECOVERED AND PROPERLY DISPOSED OF. STAGING/LAYDOWN AREAS, AS APPROVED BY THE ENGINEER, SHALL BE RESTORED BY THE CONTRACTOR TO THE EXISTING CONDITION. THE CONTRACTOR SHALL REPLACE ALL DAMAGED MATERIALS AS A RESULT OF HIS OPERATIONS, TO THE SATISFACTION OF THE ENGINEER AT NO ADDITIONAL COST	5.	TIMBER BEARING PILES BUTT.
_	TO THE OWNER.	<u>SPIL</u> 2.	L PREVENTION CONTROL SPILLS AND LEAKS SHA
7.	THE CONTRACTOR SHALL TAKE ALL NECESSARY PRECAUTIONS TO PREVENT ALL CONSTRUCTION DEBRIS OR WASTE FROM FALLING INTO THE WATER. ANY DEBRIS FALLING INTO THE WATER SHALL BE RECOVERED AND PROPERLY DISPOSED OF.	۷.	SHALL BE REMEDIATED
8.	THE CONTRACTOR SHALL MAINTAIN A SECURE SITE AND PROVIDE APPROPRIATE SAFETY MEASURES TO PREVENT ACCIDENTS. THE SAFETY MEASURES SHALL INCLUDE, BUT NOT BE LIMITED TO SIGNAGE, BARRICADES, FENCES, FLASHING WARNING LIGHTS, AND POLICING IF NECESSARY.	3.	HAZARDOUS MATERIAL INSPECTED FOR LEAKY LEAKS.
9.	IN CASE OF CONTRADICTION BETWEEN THE DRAWINGS, THE SPECIFICATIONS, AND THE CODES, OR IF ANY CHANGE IS REQUIRED, THE CONTRACTOR SHALL INFORM THE ENGINEER IMMEDIATELY. NO CHANGE SHALL BE MADE WITHOUT WRITTEN APPROVAL OF THE ENGINEER.	4.	APPROPRIATE SPILL RE SHALL BE CLEARLY MAR
0.	UPON COMPLETION OF THE PROJECT, CONTRACTOR IS TO PROVIDE TWO AS-BUILT PLAN SETS TO THE OWNER DEPICTING ANY FIELD CHANGES OF DIMENSION OR DETAIL, LOCATION OF UNDERGROUND STRUCTURES AND/OR UTILITIES, CONSTRUCTION DEVIATIONS, CHANGES DUE TO FIELD OR CHANGE ORDER, AND DETAILS NOT ON THE ORIGINAL DRAWINGS.	5.	SPILL REMEDIATION SH ACCORDANCE WITH AN
1.	SHOP AND ERECTION DRAWINGS FOR ALL WORK SHALL BE SUBMITTED TO THE ENGINEER FOR REVIEW AND APPROVAL AS PER THE	6.	AT NO TIME SHALL SPIL
	SPECIFICATIONS. FABRICATION OF THESE ITEMS SHALL NOT COMMENCE WITHOUT APPROVED SHOP DRAWINGS. SHOP DRAWINGS ARE PREPARED AND USED BY THE CONTRACTOR AS INSTRUMENTS TO SEQUENCE HIS WORK AND TO FACILITATE FABRICATION AND ERECTION. REVIEW OF SHOP DRAWINGS SHALL BE FOR GENERAL DETAIL AND ARRANGEMENT ONLY. CONTRACTOR SHALL BEAR FULL RESPONSIBILITY FOR DIMENSIONS, PROPER FIT, AND DETAILED DESIGN OF CONNECTIONS. THEIR APPROVAL BY THE ENGINEER IS NOT TO	7.	EQUIPMENT/VEHICLE FU AREAS.
	BE CONSTRUED AS A WAIVER OF CONSTRUCTION CONTRACT REQUIREMENTS OR RESPONSIBILITIES, UNLESS THE CONTRACTOR HAS BEEN GRANTED A DEVIATION IN WRITING.	8. 9.	THE EQUIPMENT OPERA
ΡĒΛ	<u> IOLITION NOTES:</u>	9. 10.	IN THE CASE OF SMALL
	THE CONTRACTOR IS RESPONSIBLE FOR VERIFYING ALL EXISTING CONDITIONS IN THE FIELD PRIOR TO ANY DEMOLITION OR CONSTRUCTION. ANY DISCREPANCIES RELATING TO THE DRAWINGS SHALL BE REPORTED TO THE ENGINEER IMMEDIATELY.	10.	A LICENSED HAZARDOU
	CONTRACTOR TO BE AWARE OF SELECTIVE DEMOLITION AT ALL SECTIONS OF WORK. CONTRACTOR WILL BE RESPONSIBLE FOR REPLACEMENT IN-KIND OF ALL WORK INADVERTENTLY REMOVED AT NO ADDITIONAL COST TO THE OWNER.	11.	IN THE CASE OF A LARG APPLICABLE AGENCIES REMOVE AND DISPOSE
•	THE CONTRACTOR SHALL REMOVE ITEMS TO BE DEMOLISHED AS INDICATED ON THE DRAWINGS WITH CARE AND NOT TO DAMAGE ADJACENT STRUCTURES. THE WORK AREA WILL BE LEFT READY TO RECEIVE NEW WORK.	EROSION CONTROL NOTES:	
	THE CONTRACTOR SHALL BE RESPONSIBLE FOR OFFSITE DISPOSAL OF ALL PROJECT DEMOLITION MATERIAL, TRASH, AND DEBRIS IN ACCORDANCE WITH LOCAL AND STATE LAWS.	1.	EROSION AND SEDIMEN REGULATORY AGENCY.
	REFER TO SPECIFICATION SECTION 02100-"DEMOLITION AND REMOVAL" FOR ADDITIONAL INFORMATION AND REQUIREMENTS.	2.	CONTRACTOR SHALL M
		3.	CONTRACTOR SHALL PI

HALL CONFORM TO THE LATEST EDITION OF ACI 318 - "BUILDING CODE REQUIREMENTS FOR STRUCTURAL E RHODE ISLAND STATE BUILDING CODE.

PROPORTIONED, MIXED, AND PLACED UNDER THE SUPERVISION OF THE APPROVED TESTING AGENCY.

NORMAL WEIGHT, WITH TYPE II CEMENT, AND SHALL HAVE A MINIMUM COMPRESSIVE STRENGTH AT 28 DAYS ICRETE DESIGN MIXES SHALL BE SUBMITTED TO THE ENGINEER FOR REVIEW AND APPROVAL.

BE AIR-ENTRAINED WITH AN AIR CONTENT OF 6% +/- 1%.

SHALL BE CHAMFERED 1" UNLESS NOTED OTHERWISE.

PLACED AGAINST PREVIOUSLY HARDENED CONCRETE, THE INTERFACE SHALL BE CLEAN, FREE OF LAITANCE ROUGHENED TO FULL AMPLITUDE OF APPROXIMATELY 1/4 INCH.

T OPERATIONS TO OR WITHIN THE WATERWAY MUST NOT TAKE PLACE AT ANY TIME.

NOTES:

SHALL BE DETAILED IN ACCORDANCE WITH ACI 315 - "DETAILS AND DETAILING OF CONCRETE REINFORCEMENT" AND STATE BUILDING CODE.

AWINGS AND SCHEDULES OF ALL REINFORCING STEEL SHALL BE PREPARED BY THE CONTRACTOR AND ENGINEER FOR APPROVAL PRIOR TO COMMENCEMENT OF THAT PORTION OF THE WORK. ALL ACCESSORIES THE SHOP DRAWINGS.

HALL BE EPOXY COATED AND CONFORM TO ASTM A615 OR A706 (WELDABLE) GRADE 60.

HAS CHAIRS, BOLSTERS, SPACERS, BLOCKS AND HANGERS SHALL BE OF NON-CORROSIVE MATERIAL. BLOCKS ,000 PSI (UN-REINFORCED) CONCRETE.

HE DRAWINGS, THE MINIMUM CONCRETE PROTECTION (CLEAR COVER) FOR CAST-IN-PLACE CONCRETE COVER

CRETE EXPOSED TO EARTH OR WATER: 3"

ST AGAINST AND PERMANENTLY EXPOSED TO EARTH: 3"

EMENT DEVELOPMENT LENGTH SHALL BE IN ACCORDANCE WITH ACI 318 UNLESS NOTED ON THE DRAWINGS. SHALL BE IN ACCORDANCE WITH ACI 318 FOR CLASS B LAPS UNLESS NOTED OTHERWISE.

T SHALL BE CONTINUOUS THROUGH CONSTRUCTION JOINTS. UNLESS NOTED OTHERWISE, BARS SHALL BE HALL RUN CONTINUOUSLY AROUND CORNERS AND LAPPED AT NECESSARY SPLICES OR HOOKED AT

IALL BE SOUTHERN YELLOW PINE NO. 1 OR BETTER (I/b=1,200 PSI).

BE PRESSURE TREATED TO A MINIMUM NET RETENTION OF 0.6 PCF OF CCA IN ACCORDANCE WITH AWPA SS OTHERWISE NOTED.

BOLT HOLES SHALL BE PROTECTED IN ACCORDANCE WITH AWPA STANDARD M4.

PROVIDED IN THE PLANS ARE DRESSED SIZES UNLESS SPECIFIED OTHERWISE.

ES ARE TO BE CLASS B GREENHEART TIMBER PILES WITH A MINIMUM DIAMETER OF 14 INCHES 3 FT FROM THE

NOTES:

HALL BE AVOIDED THROUGH FREQUENT INSPECTION OF EQUIPMENT AND MATERIAL STORAGE AREAS, AND ED AND REPAIRED AS NECESSARY.

L STORAGE TO BE PLACED ONLY IN DESIGNATED AREAS. MATERIAL STORAGE AREAS SHALL BE ROUTINELY (Y CONTAINERS, OPEN CONTAINERS, OR IMPROPER STORAGE TECHNIQUES THAT MAY LEAD TO SPILLS OR

REMEDIATION PROCEDURES AND SUPPLIES SHALL BE READILY AVAILABLE ON-SITE. TOOLS AND SUPPLIES IARKED SO THAT ALL PERSONNEL CAN LOCATE AND ACCESS THESE SUPPLIES.

SHALL BE PERFORMED IMMEDIATELY. CONTRACTOR SHALL FOLLOW PROPER RESPONSE PROCEDURES IN ANY APPLICABLE REGULATORY REQUIREMENTS.

PILLS BE DIVERTED TOWARD STORM DRAINS OR TO THE WATERWAY.

FUELING AND REPAIR/MAINTENANCE OPERATIONS SHALL TAKE PLACE ONLY WITHIN DESIGNATED STAGING

ERATOR SHALL FULLY MONITOR FUELING OPERATIONS TO EQUIPMENT AND VEHICLES AT ALL TIMES.

BE IMMEDIATELY CLEANED WITH SPILL KITS KEPT ON SITE.

L AMOUNTS OF SOIL CONTAMINATION, SUCH SOIL SHALL BE PLACED IN 55 GALLON DRUMS FOR DISPOSAL BY OUS WASTE HAULER AT NO ADDITIONAL COST TO THE OWNER.

RGE AMOUNT OF SOIL CONTAMINATION OR DISCHARGE TO THE WATERWAY, RHODE ISLAND DEM AND ES SHALL BE NOTIFIED AS REQUIRED. A HAZARDOUS WASTE REMEDIATION FIRM SHALL BE CONTRACTED TO E OF THE CONTAMINATED MATERIAL OR CONTAIN THE SPILL AT NO ADDITIONAL COST TO THE OWNER.

IENT CONTROLS TO BE INSTALLED AS REQUIRED FOR AND AS DETERMINED BY THE ENGINEER, OWNER, OR

MAINTAIN ALL EROSION CONTROL DEVICES FOR THE DURATION OF THE PROJECT.

3. CONTRACTOR SHALL PREVENT SEDIMENT FROM ENTERING THE WATERWAY VIA DISCHARGES THROUGH ANY DRAINAGE STRUCTURES OR RUNOFF FROM WITHIN THE LIMITS OF WORK.

4. CONTRACTOR SHALL BE RESPONSIBLE FOR REMOVING, RESTORING AND REPAIRING ALL DAMAGE AS A RESULT OF UNAUTHORIZED WORK OR DISCHARGES AT NO ADDITIONAL COST TO THE OWNER.

5. THE CONTRACTOR SHALL INSTALL AND MAINTAIN TURBIDITY BARRIERS AS INDICATED IN THE CONTRACT DOCUMENTS. TURBIDITY BARRIERS SHALL BE ANCHORED SECURELY AS TO ENSURE COLLECTION OF SEDIMENT AND ENABLE THE WORK TO BE PERFORMED.


6. SOIL STOCKPILES SHALL BE A MINIMUM OF 2-FEET FROM THE EDGE OF THE WALL TO LIMIT RUNOFF INTO THE HARBOR.

7. THE LIMITS OF EROSION CONTROL BARRIERS SHALL BE ADJUSTED OR EXPANDED AS FIELD CONDITIONS WARRANT.


8. ALL EROSION CONTROL BARRIERS SHALL BE INSPECTED AT LEAST ONCE PER WEEK. ANY DAMAGED AREAS OF THE EROSION CONTROL BARRIER SHALL BE REPAIRED WITHIN 24 HOURS OF DISCOVERY.

9. DISCHARGE OF TURBID WATER TO THE WATERWAY IS PROHIBITED.


10. THE TURBIDITY BARRIER SHALL BE INSTALLED PRIOR TO COMMENCEMENT OF WORK AND SHALL REMAIN IN PLACE UNTIL ALL PILES AND FORMWORK ARE REMOVED.

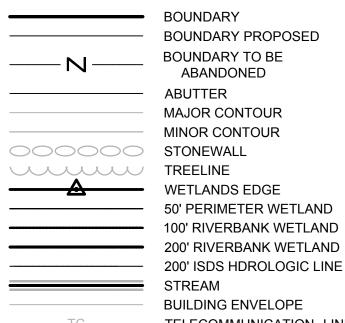


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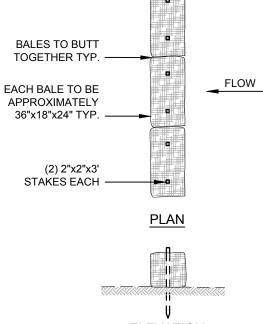

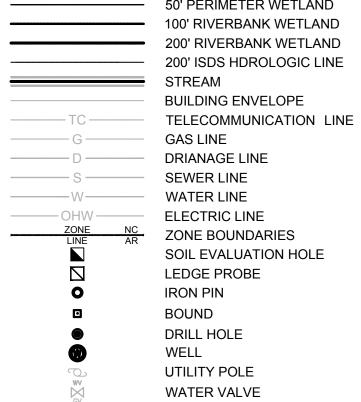
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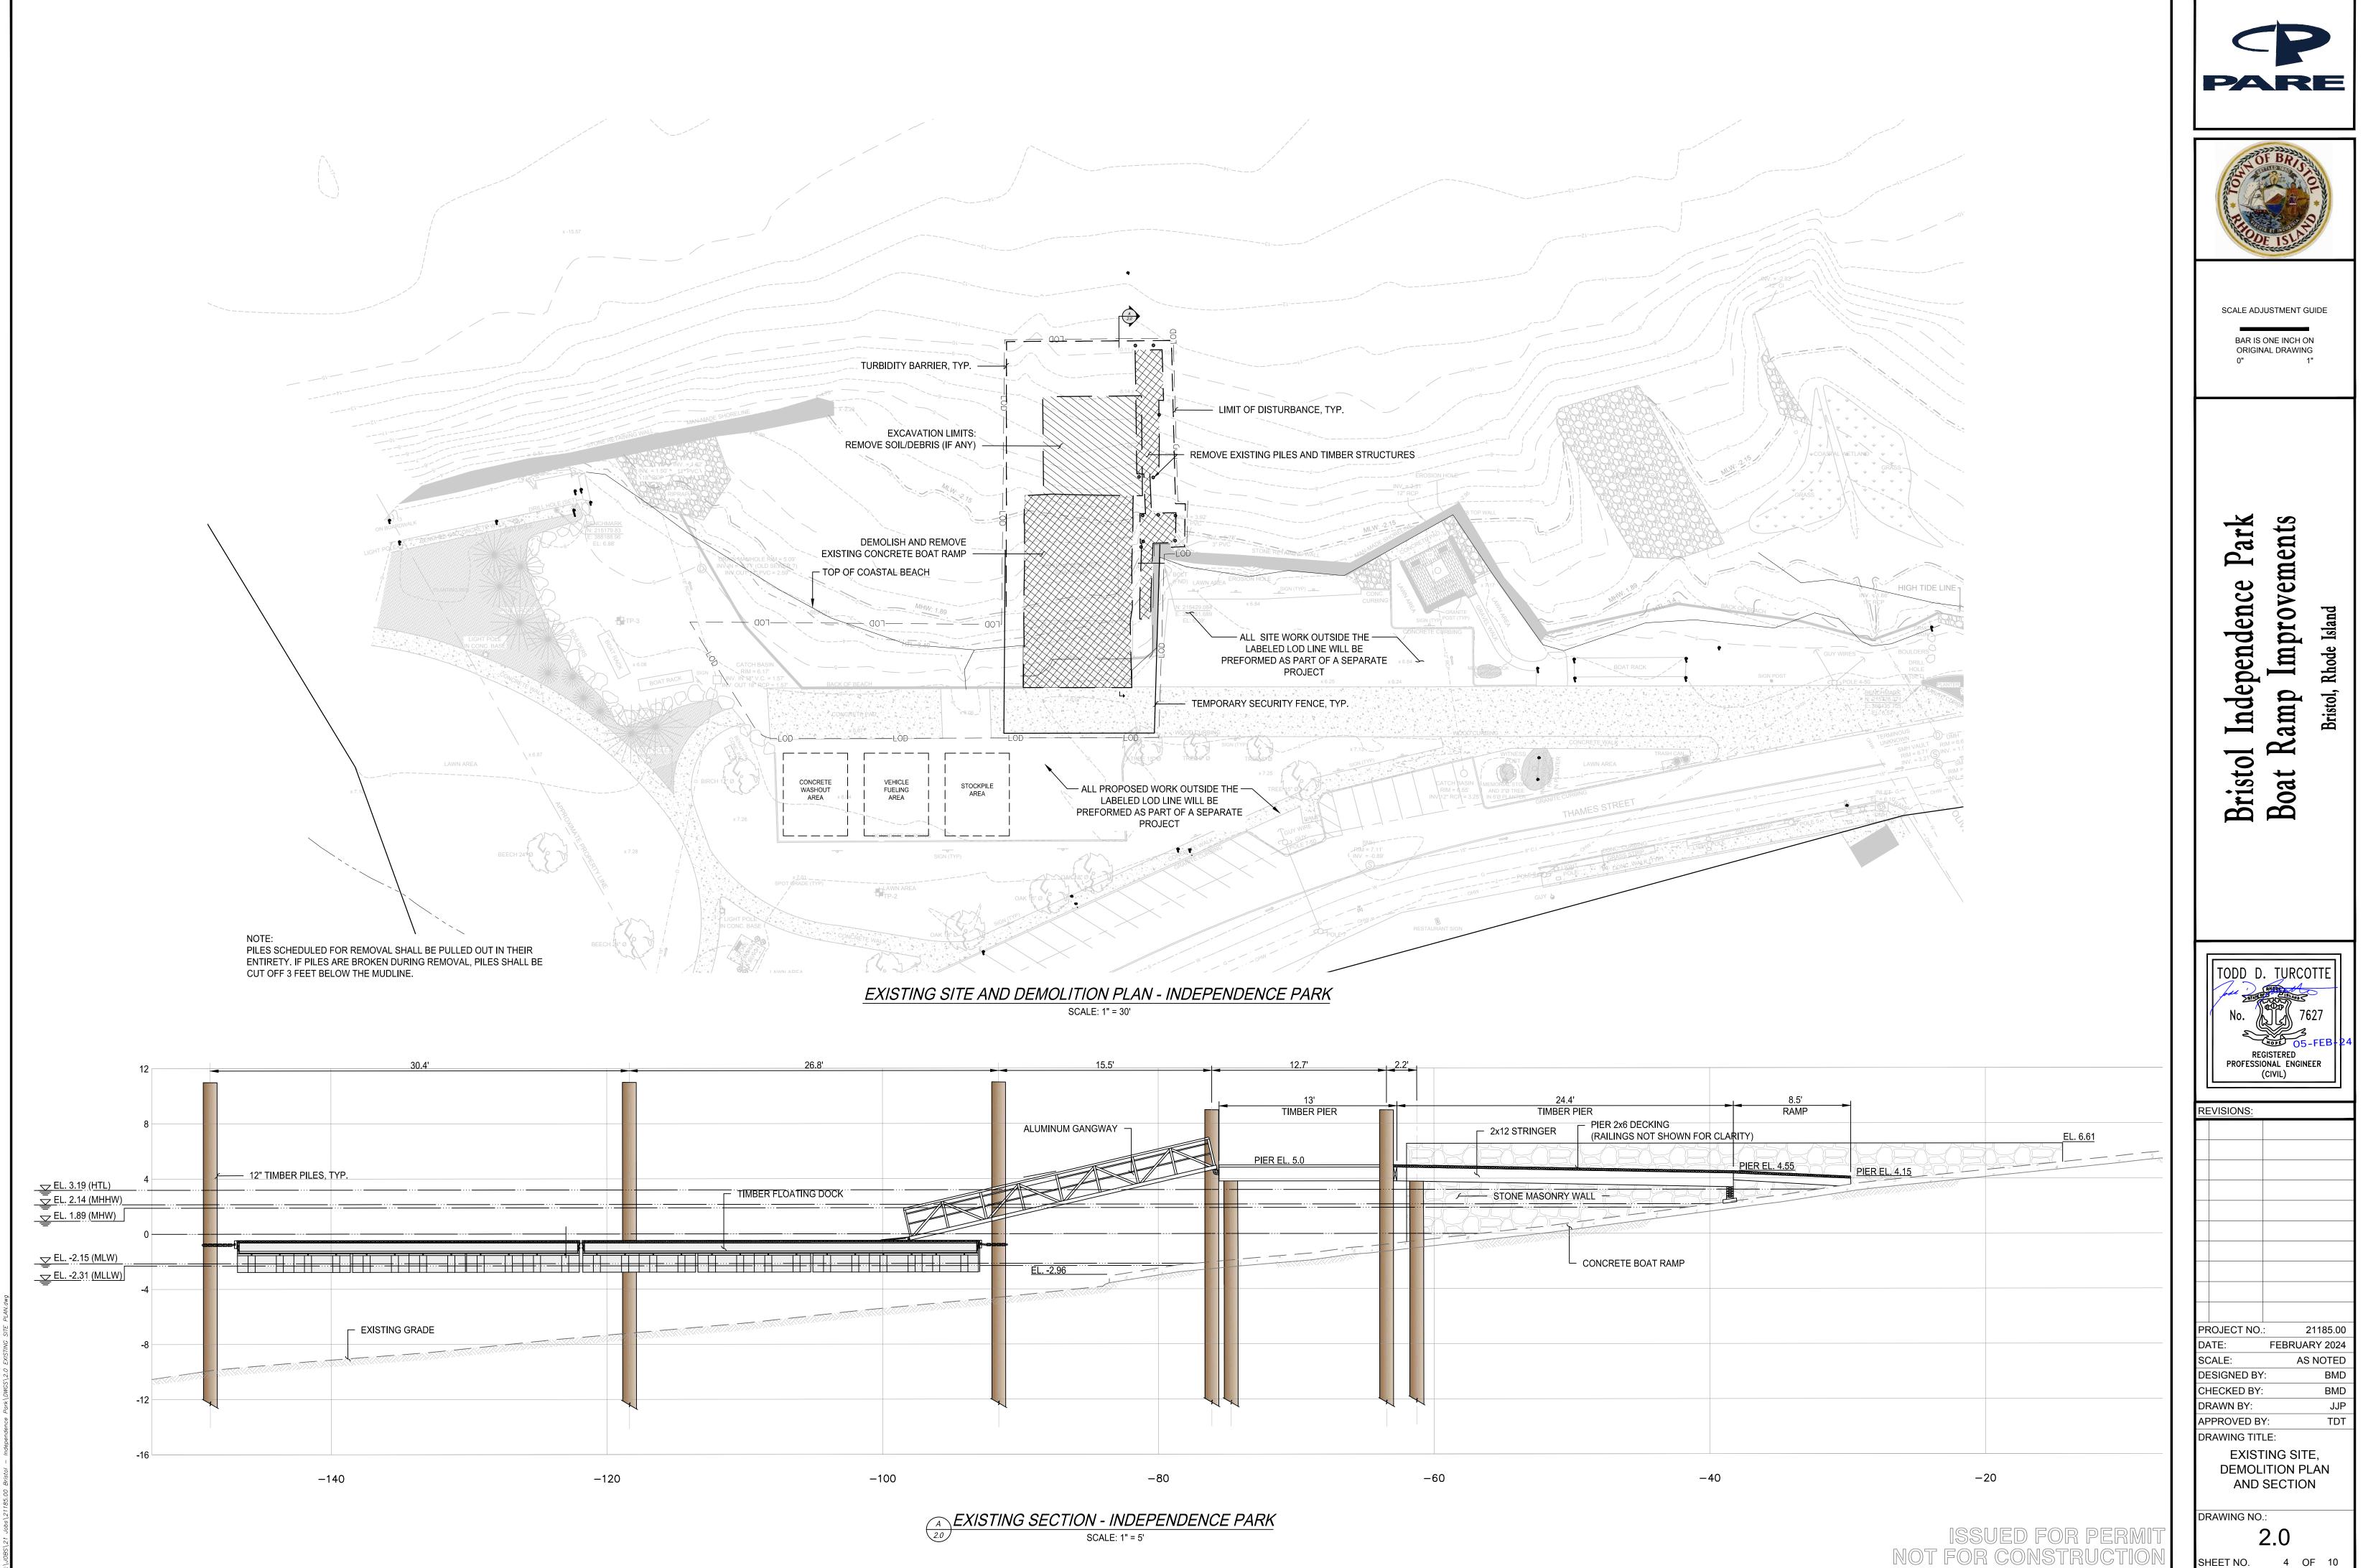
LEGEND NOT TO SCALE




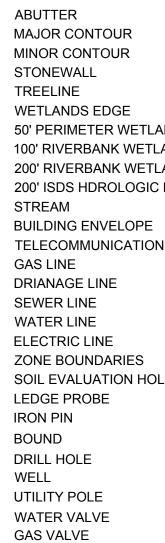


ELEVATION TYPE 1 EROSION CONTROL NOT TO SCALE

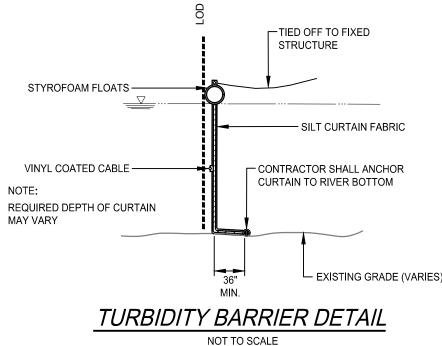
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5)	15 FEMA 2014 = 15.00	Bristol Independence Park Boat Ramp Improvements Bristol, Rhode Island
	$ \begin{array}{cccccccccccccccccccccccccccccccccccc$	TODD D. TURCOTTE No. 7627 No. 7627 PROFESSIONAL ENGINEER CIVIL)
	-2 -2 MLW = -2.15 MLW = -2.31 DATUM ELEVATION INFORMATION VALUES BASED ON INTERPOLATION BETWEEN NOAA STATIONS: QUONSET 8454049 AND CONIMICUT LIGHT 8452944	PROJECT NO.: 21185.00 DATE: FEBRUARY 2024 SCALE: AS NOTED DESIGNED BY: BMD CHECKED BY: BMD DRAWN BY: JJP APPROVED BY: TDT DRAWING TITLE: GENERAL NOTES
	ISSUED FOR PERMIT NOT FOR CONSTRUCTION	DRAWING NO.: 1.0 SHEET NO. <u>3</u> OF <u>10</u>




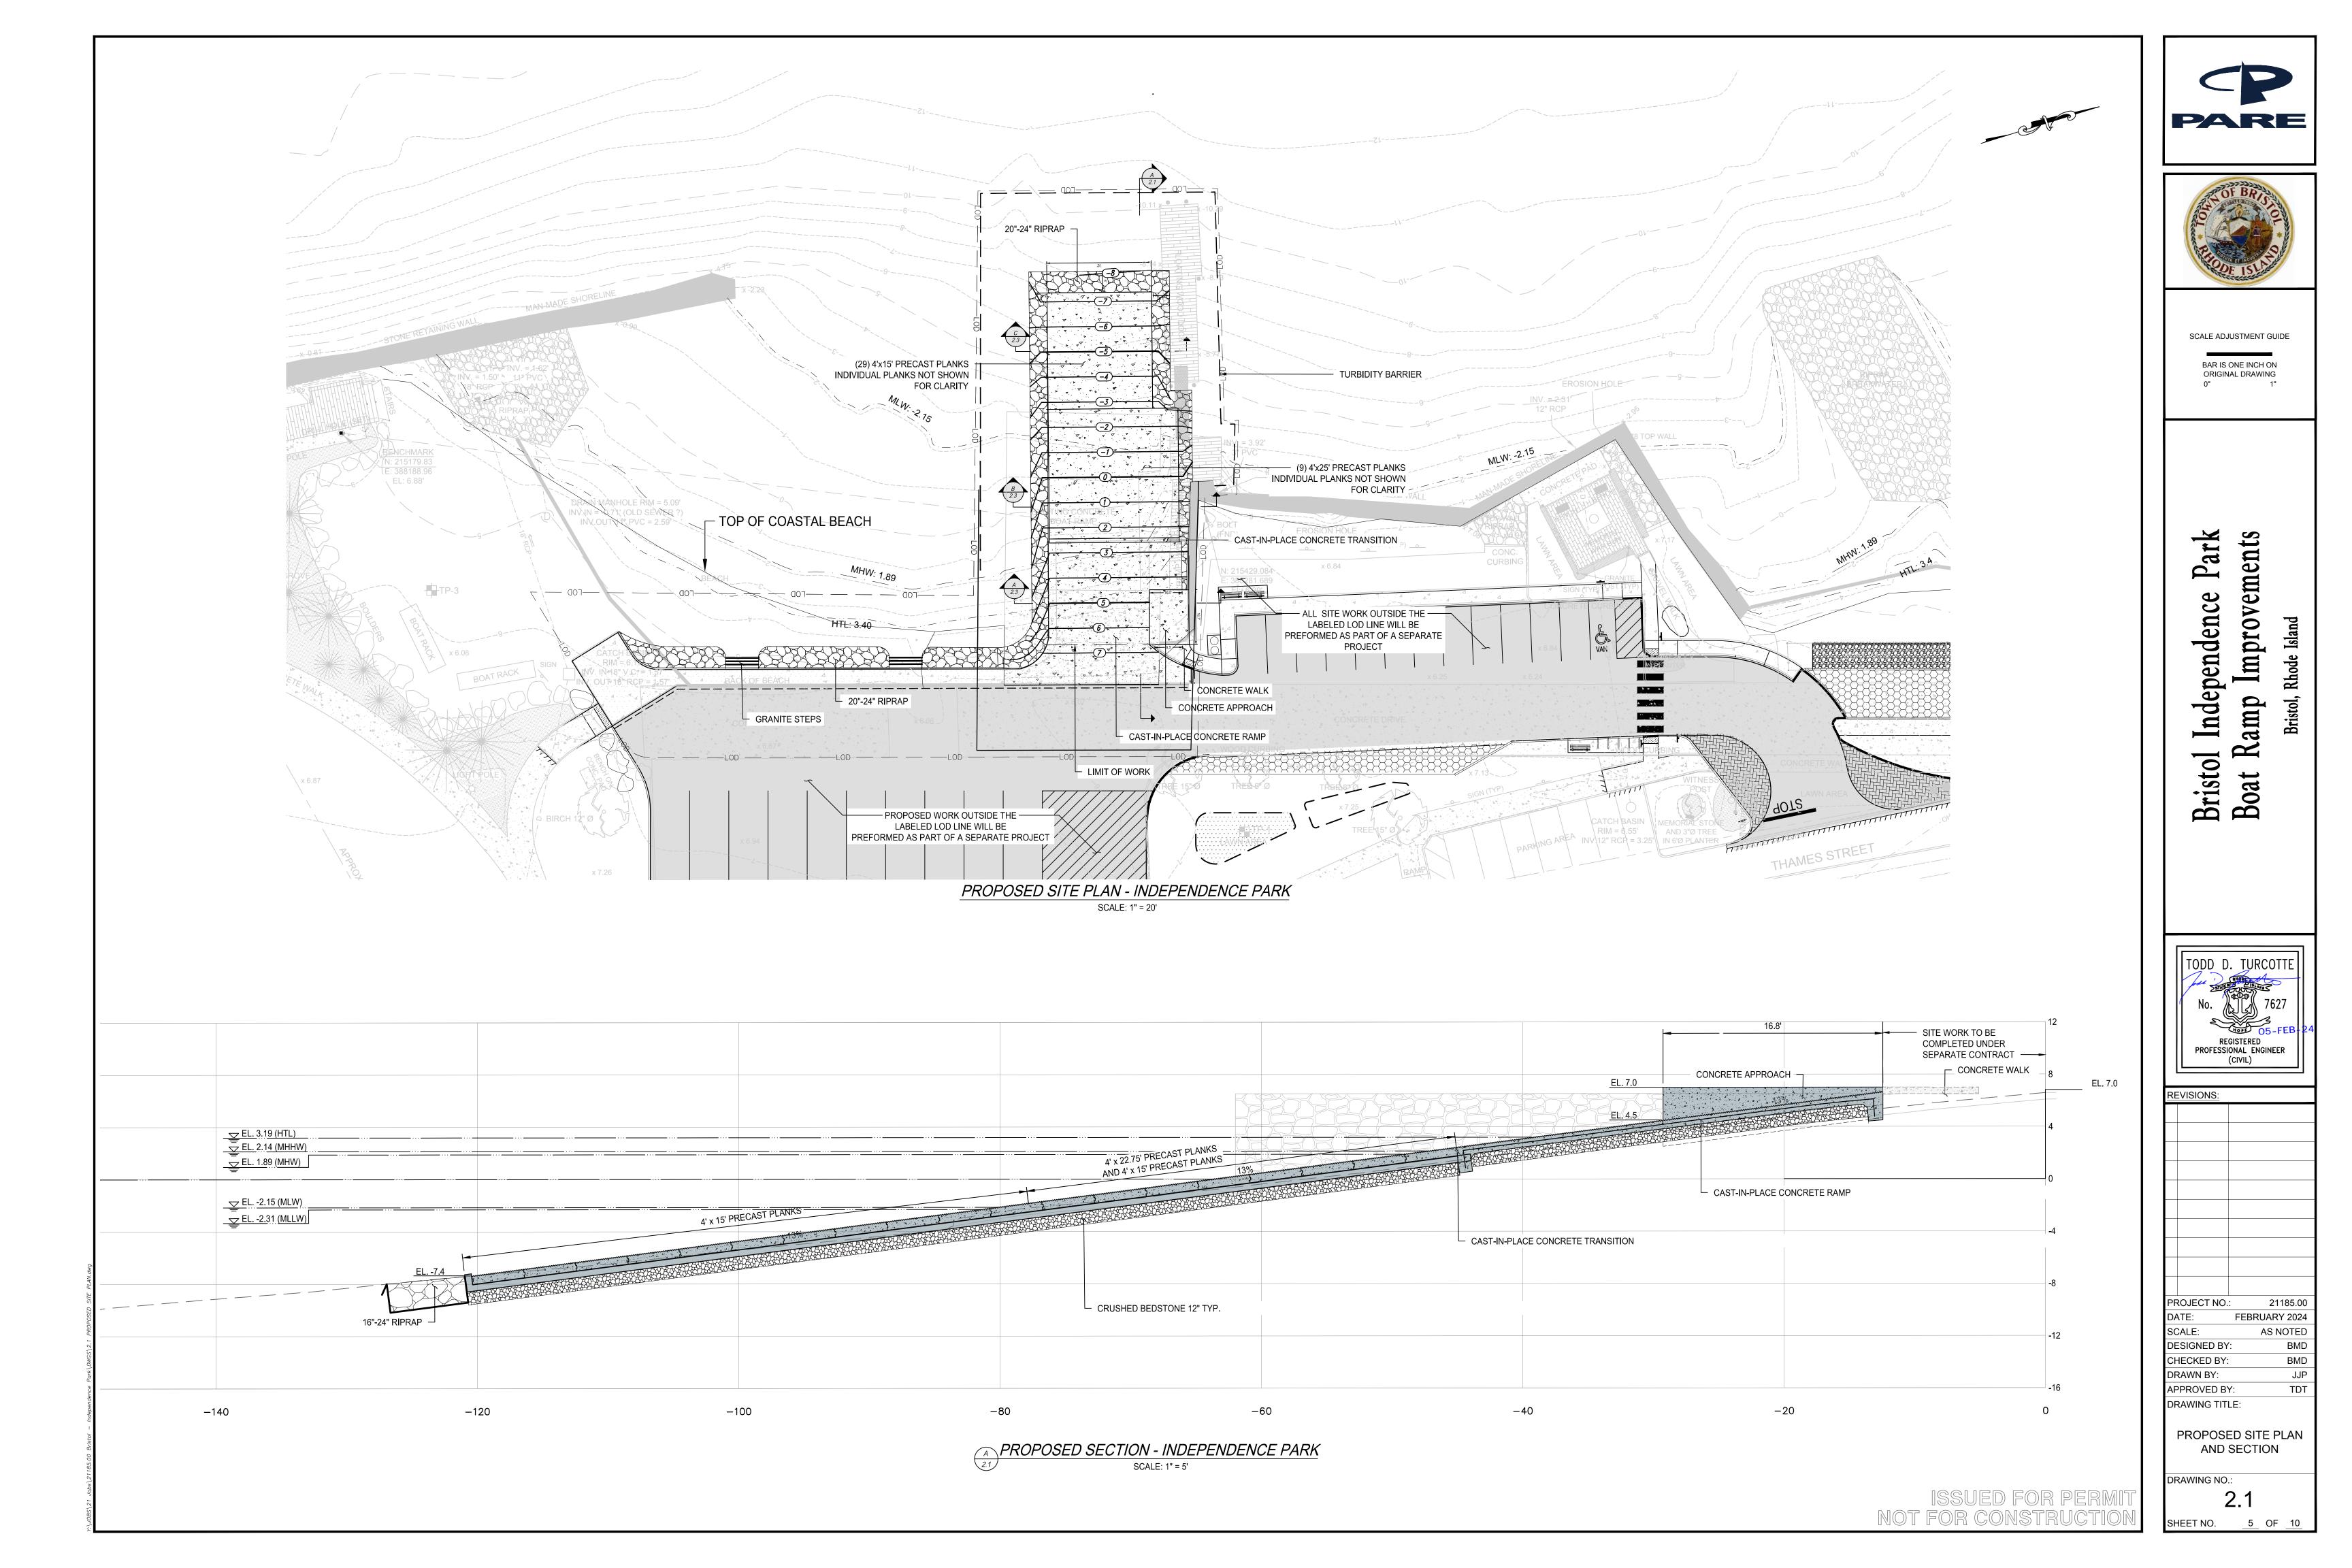


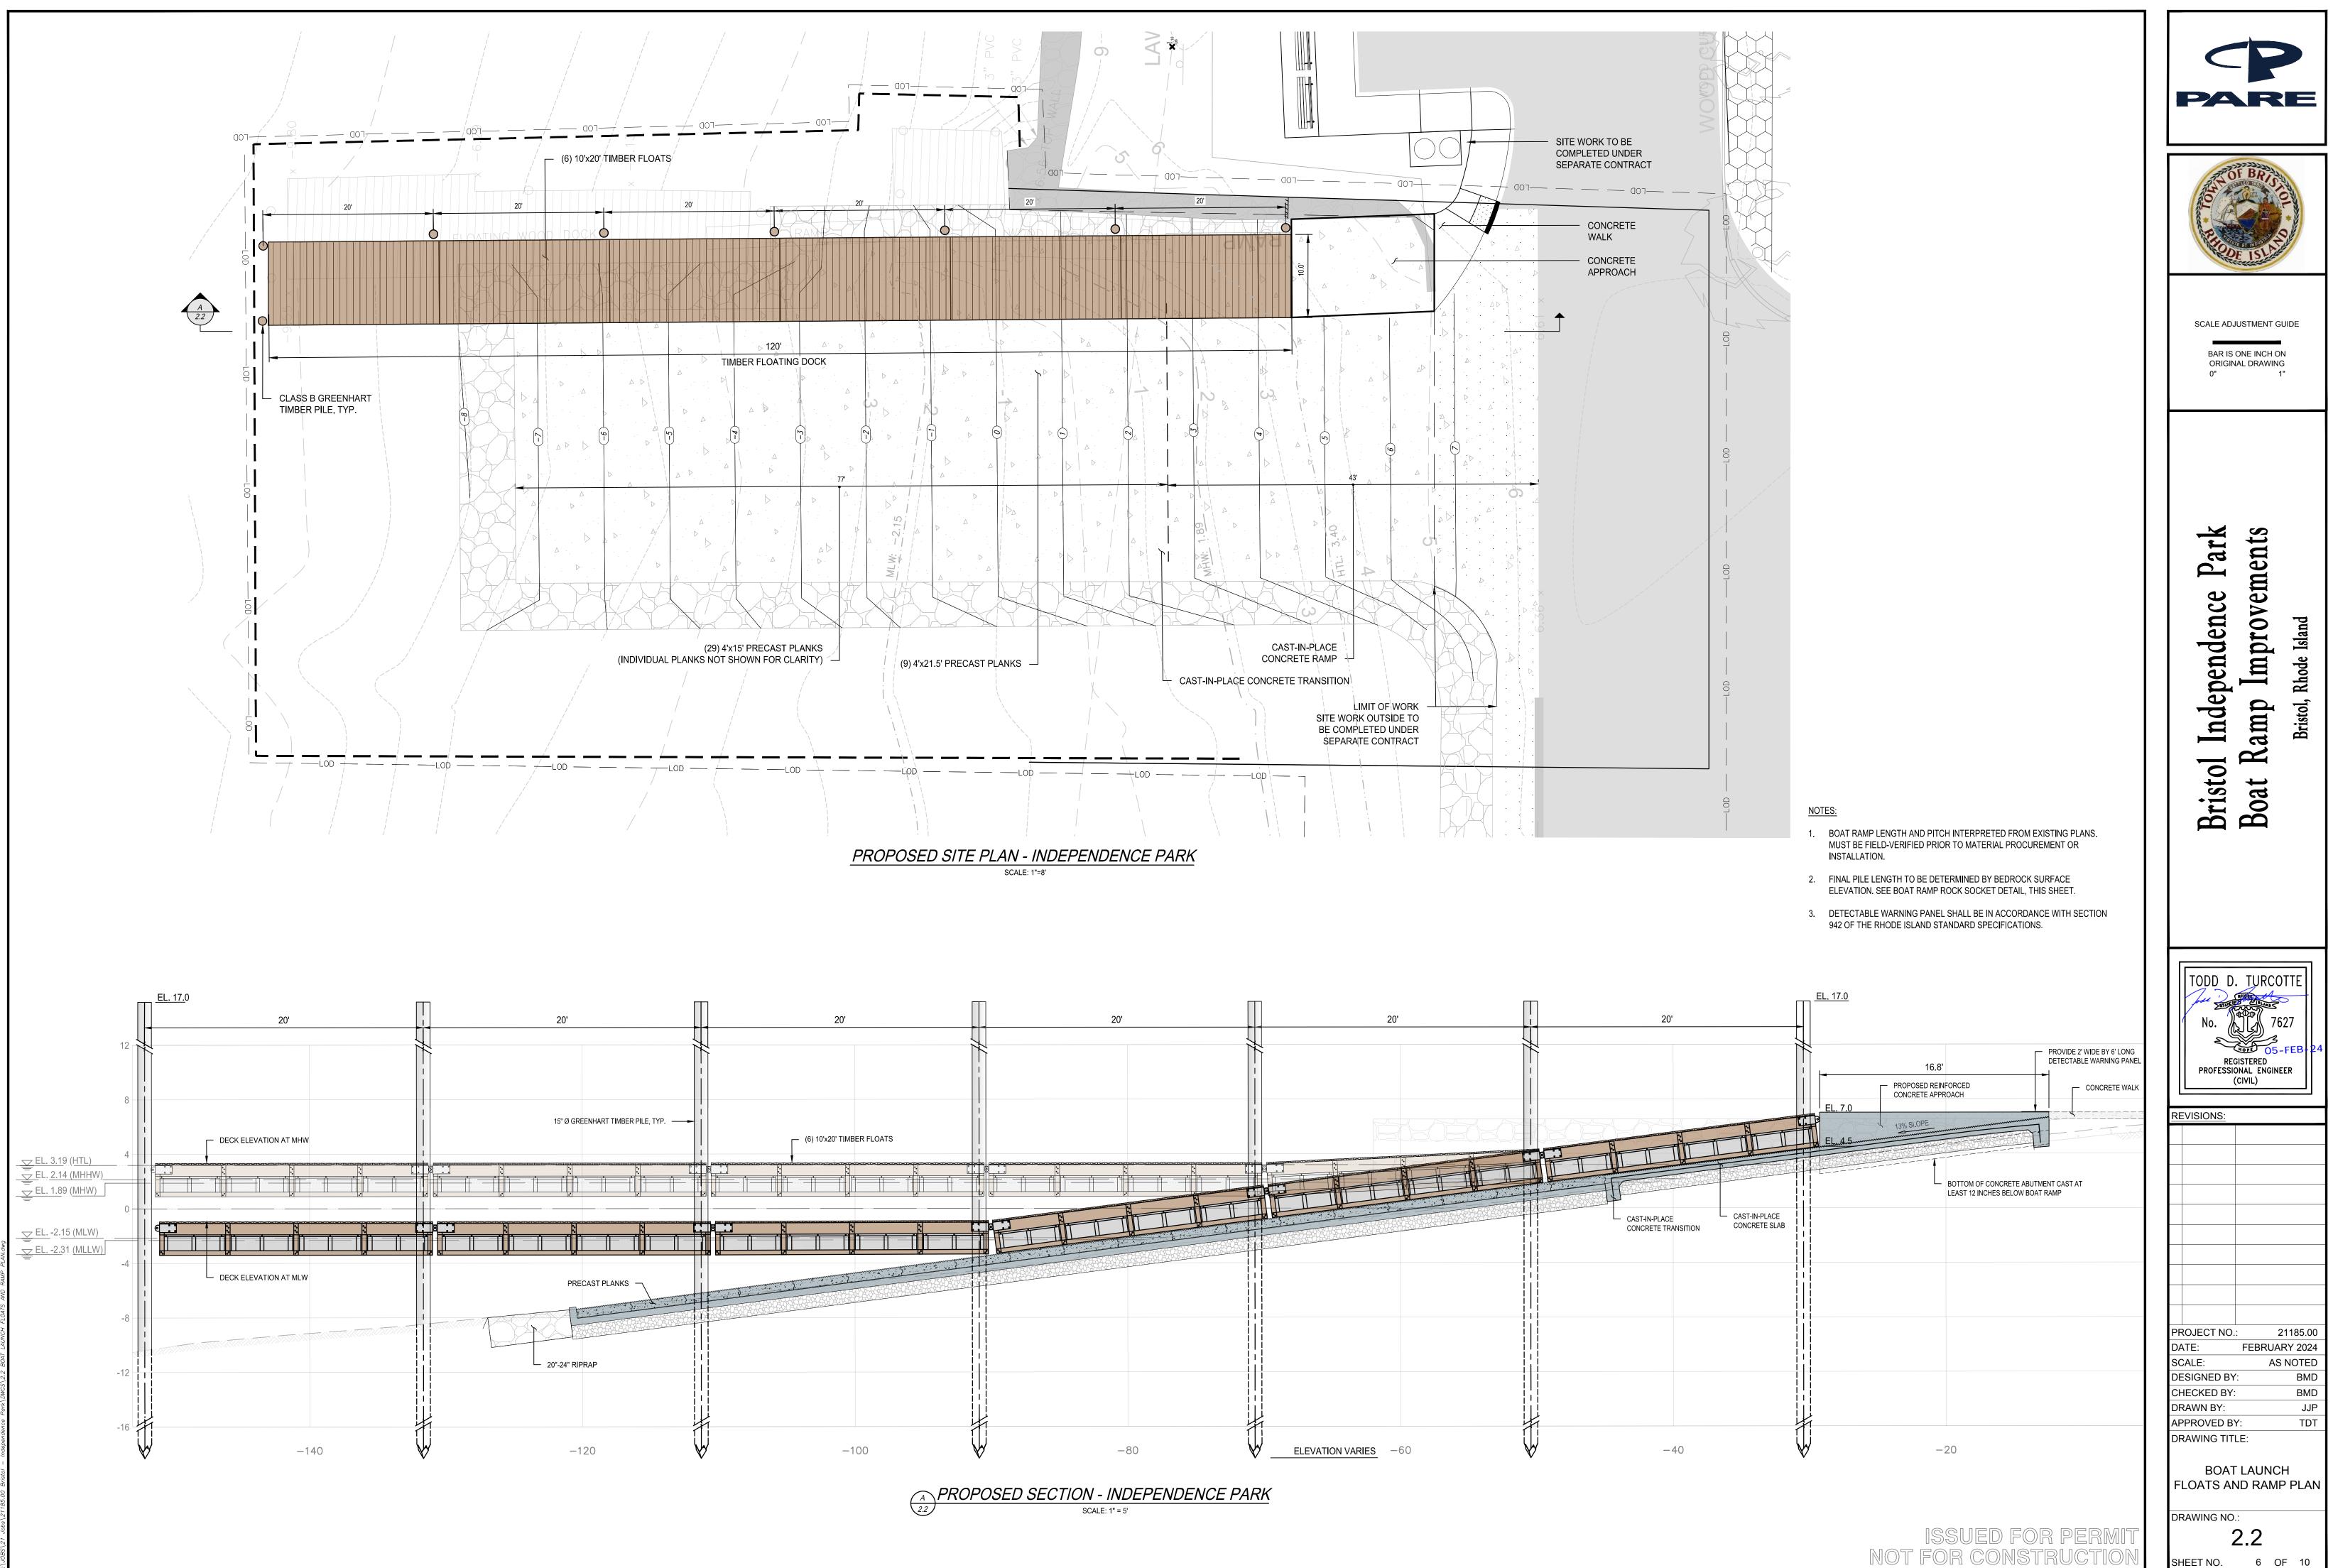

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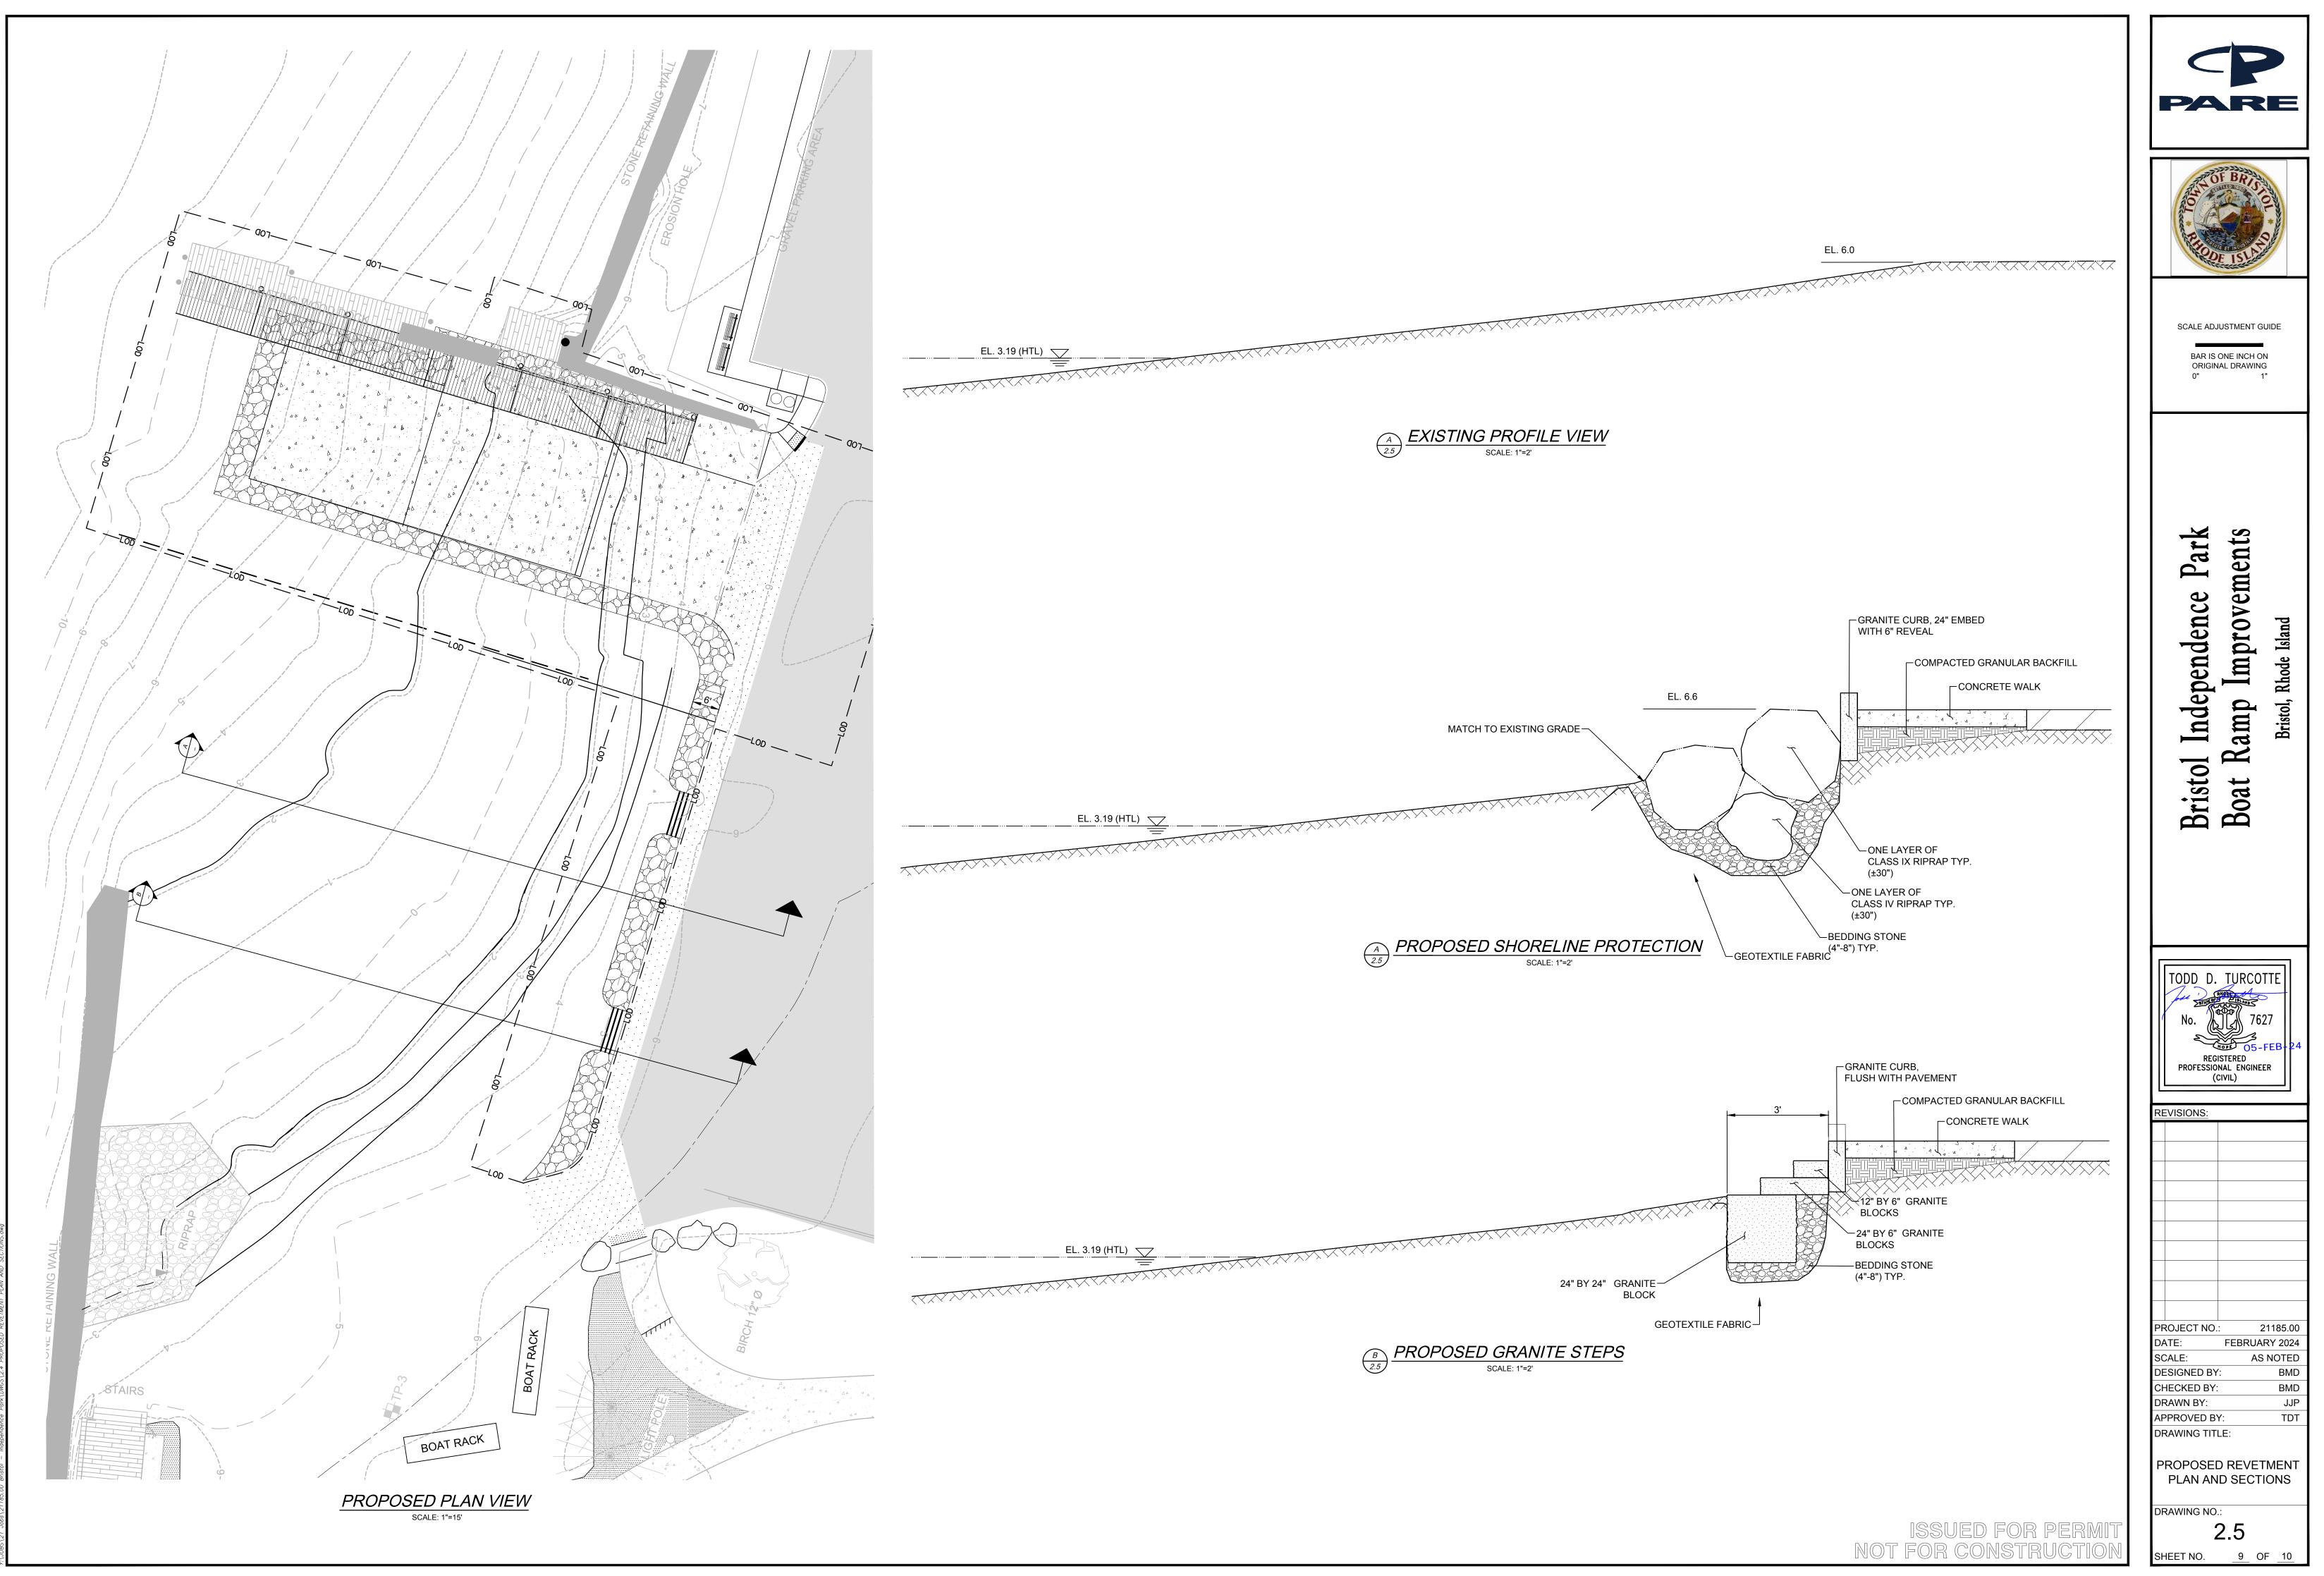


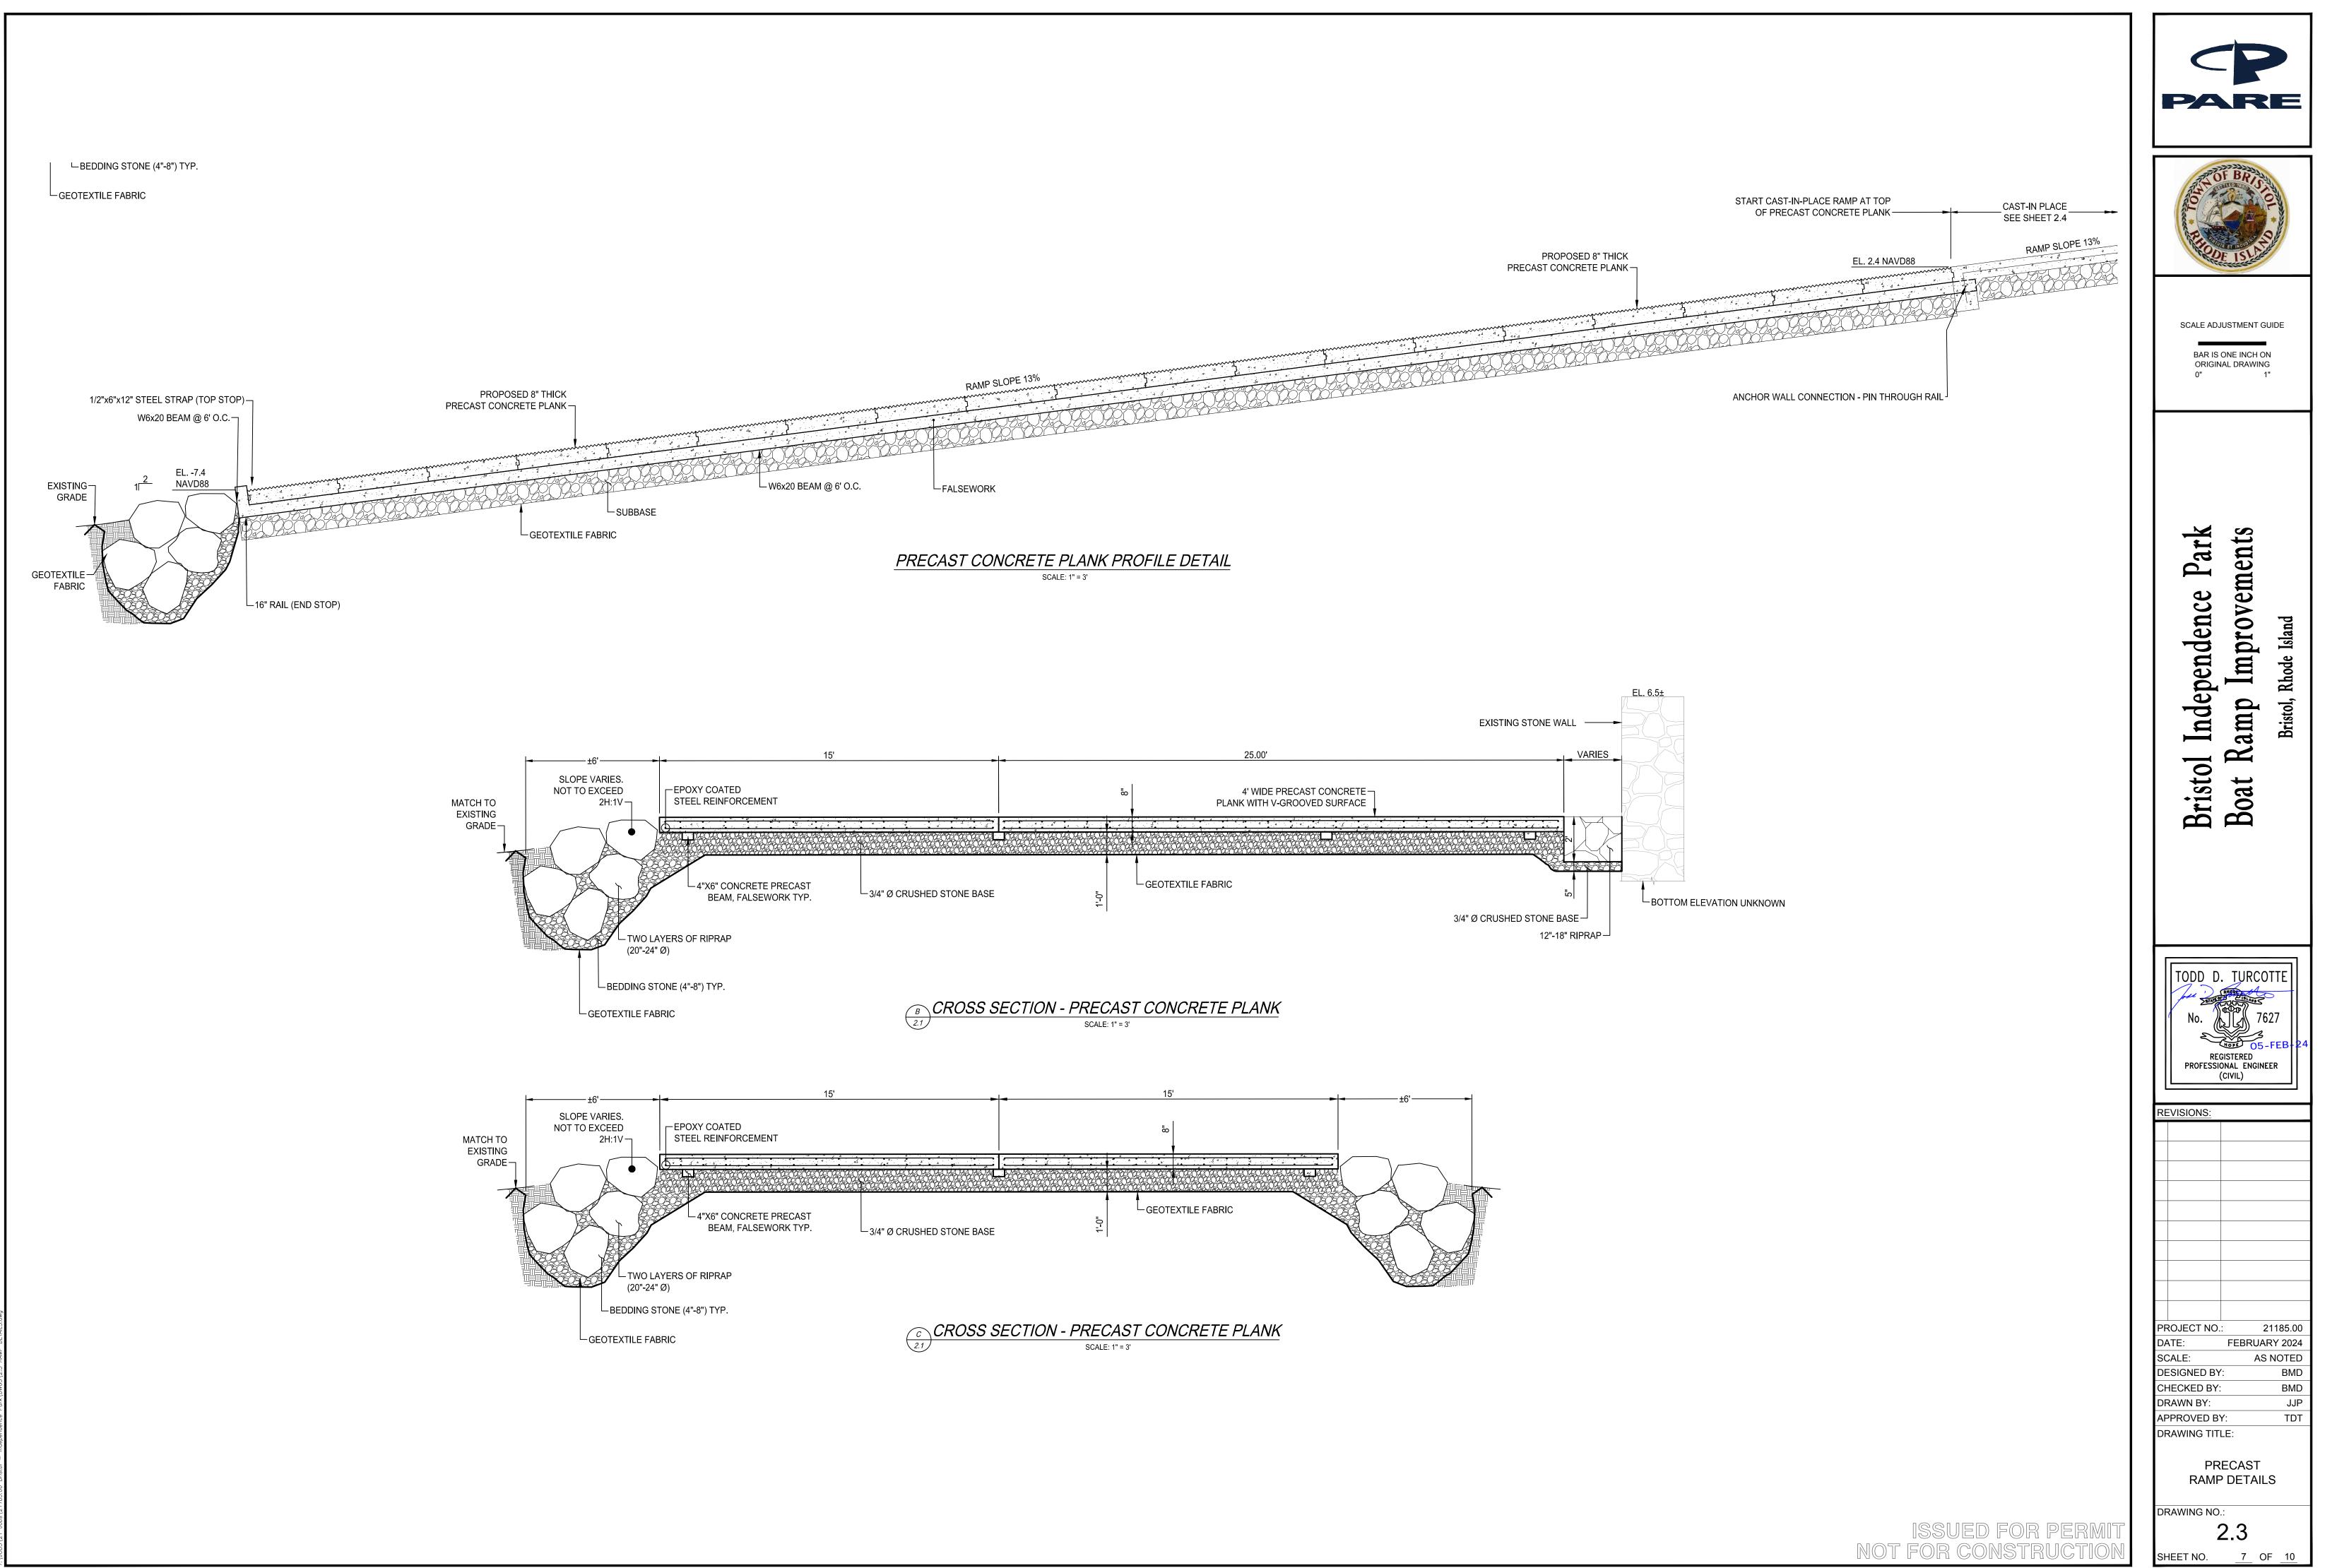
PARE
OF BRIS
SCALE ADJUSTMENT GUIDE BAR IS ONE INCH ON ORIGINAL DRAWING 0" 1"
Bristol Independence Park Boat Ramp Improvements Bristol, Rhode Island
TODD D. TURCOTTE No. No. TOTE O5-FEB REGISTERED PROFESSIONAL ENGINEER (CIVIL) REVISIONS:
PROJECT NO.: 21185.00 DATE: FEBRUARY 2024 SCALE: AS NOTED DESIGNED BY: BMD CHECKED BY: BMD DRAWN BY: JJP APPROVED BY: TDT DRAWING TITLE:
CAST-IN-PLACE RAMP DETAILS DRAWING NO.: 2.4 SHEET NO. <u>8</u> OF <u>10</u>

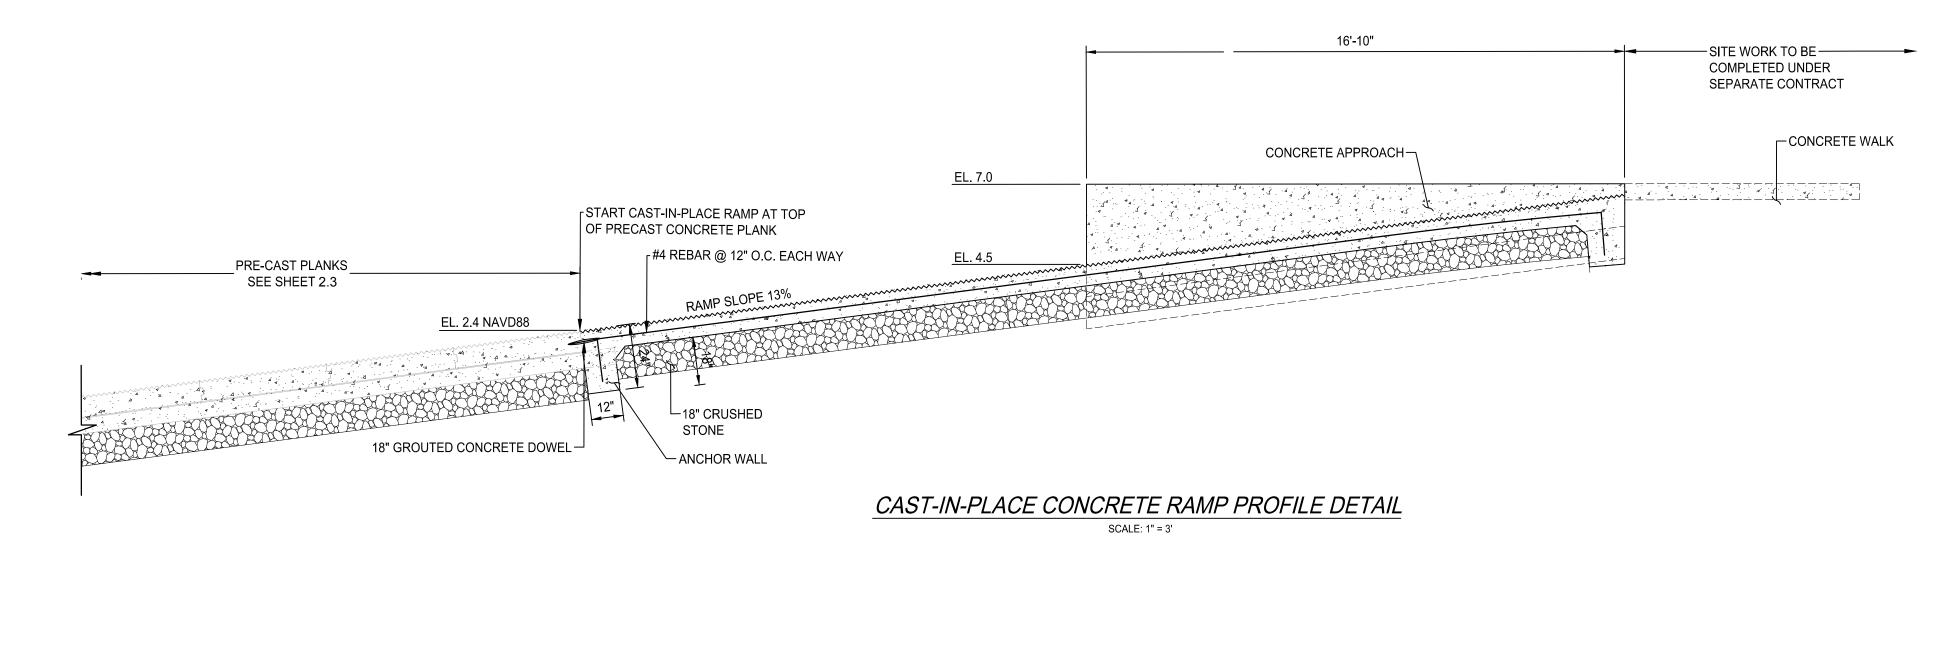ISSUED FOR PERMIT NOT FOR CONSTRUCTION

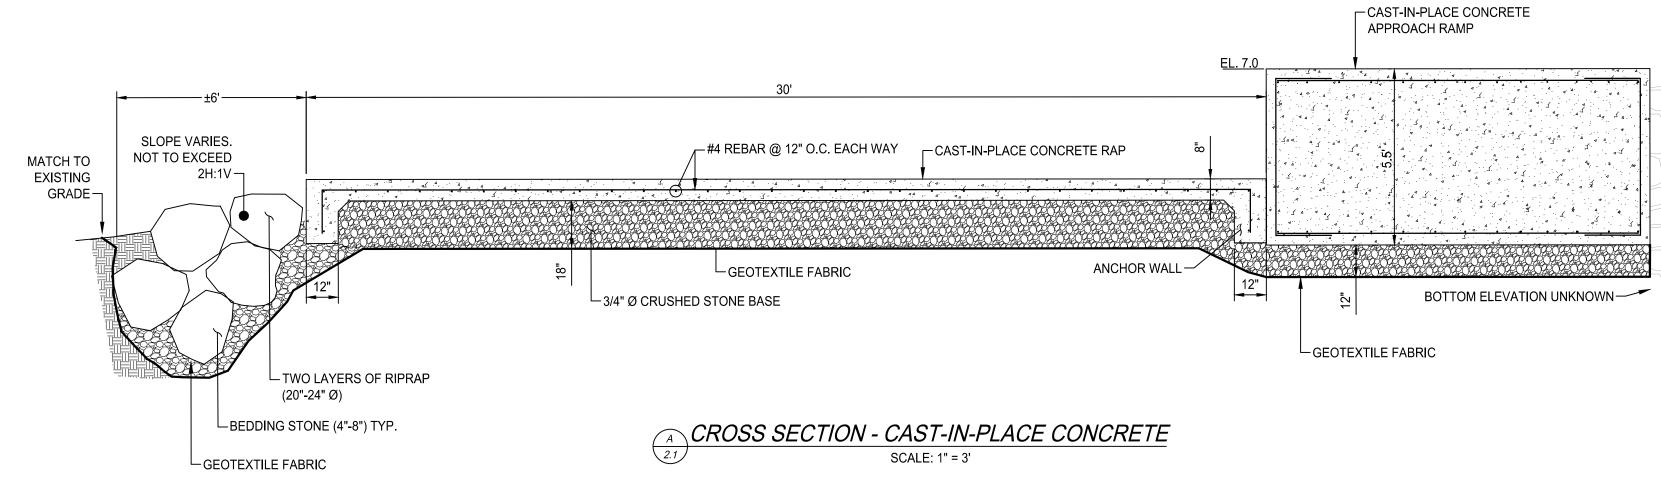
EXISTING STONE WALL





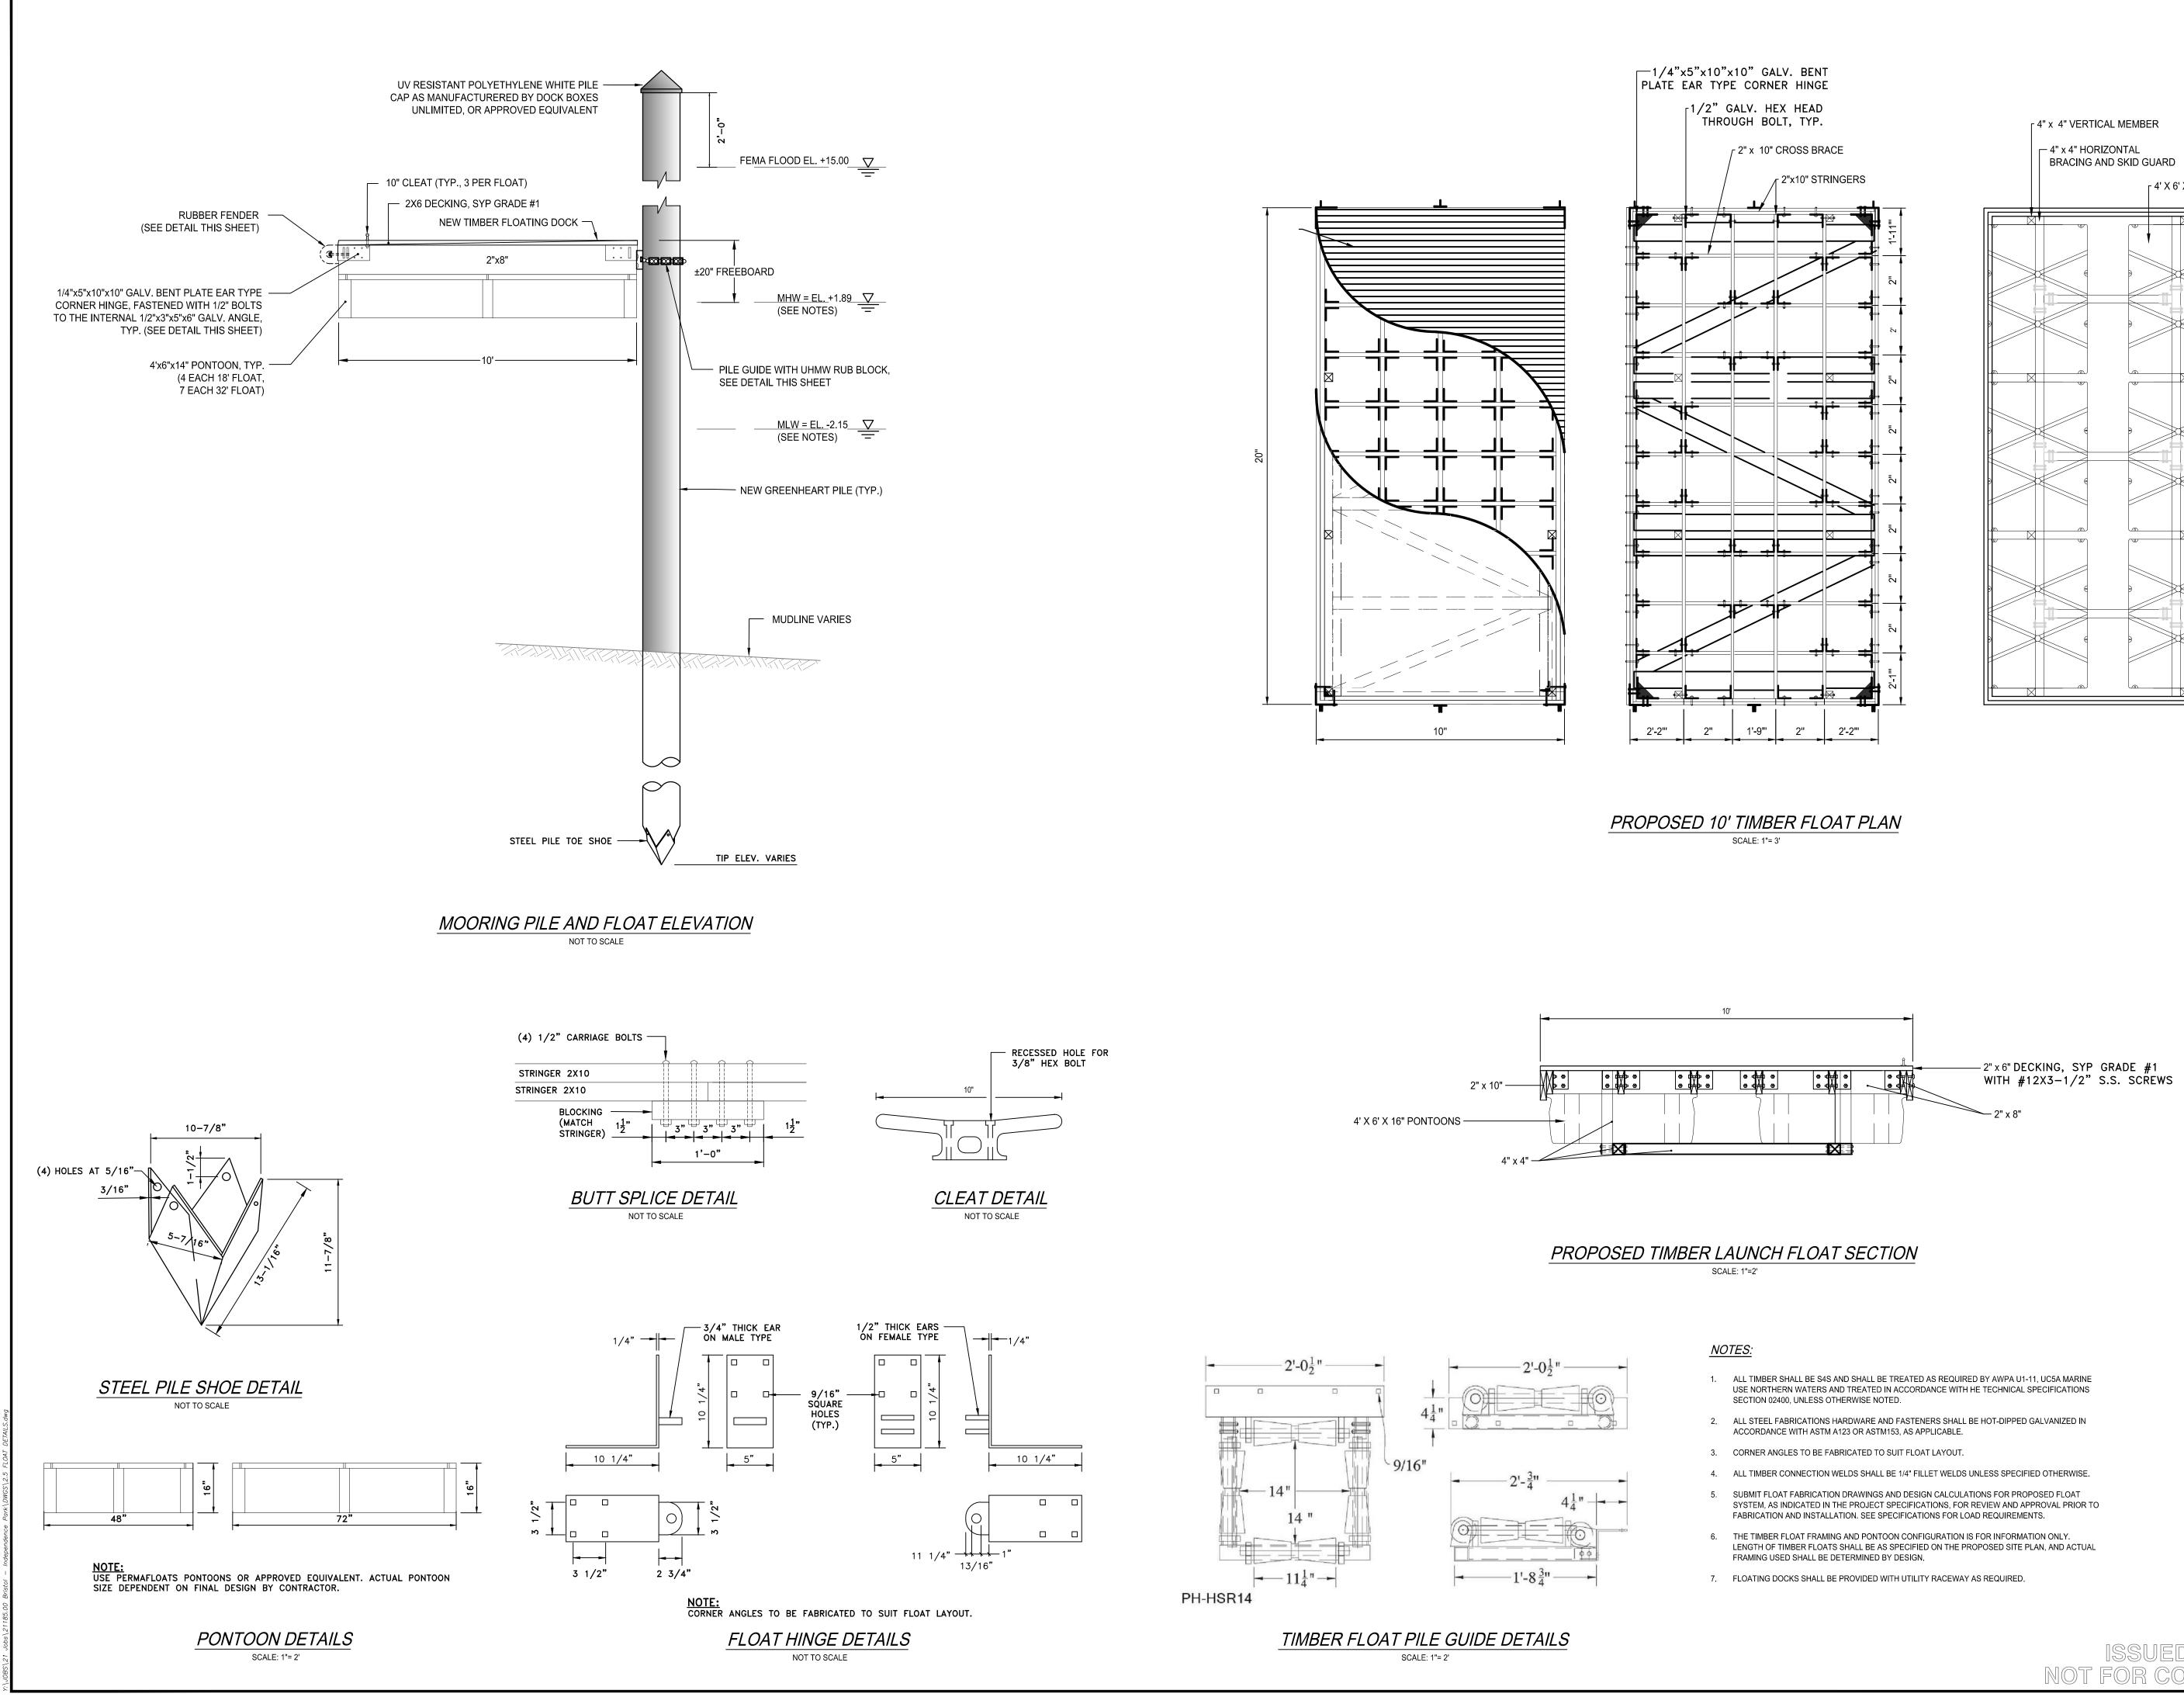

4" x 4" VERTICAL MEMBER					
4" x 4" HORIZONTAL BRACING AND SKID GUARD					
	4' X 6' X 16" PONTOONS				

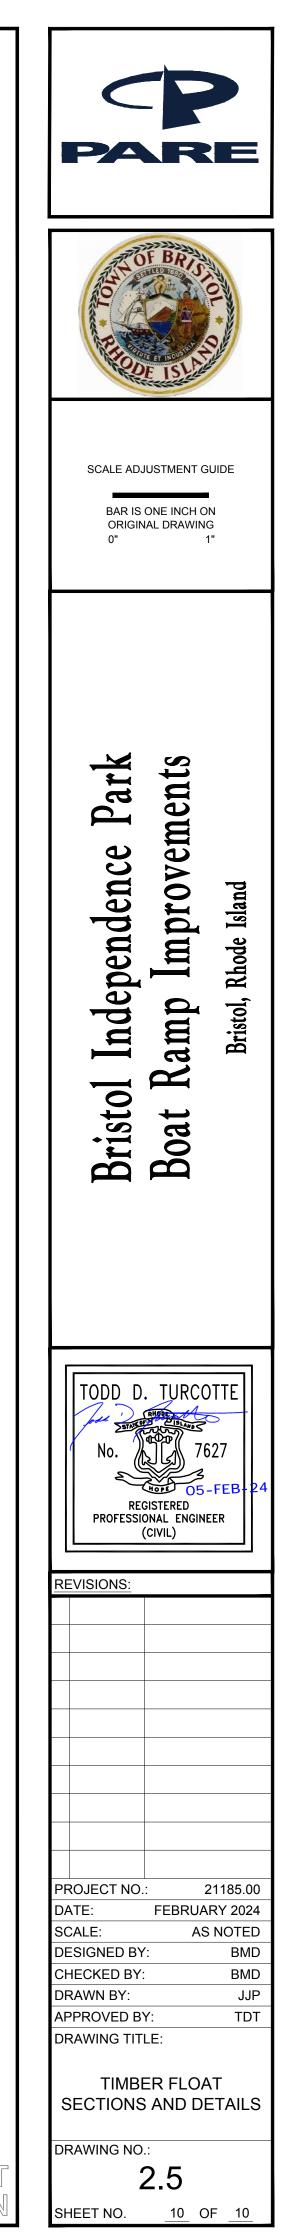

ISSUED FOR PERM NOT FOR CONSTRUCT