(401) 783-3370 Fax (401) 783-2069

PUBLIC NOTICE

File Number:	2024-02-113	Date:	April 30, 2024	
This office has	under consideration the application of:			

Solari RI Commercial Prop. LLC P.O. Box 255 Hockessin, DE 19707

for a State of Rhode Island Assent to construct and maintain:

Expansion of an existing commercial development with the Salt Pond Region SAMP watershed. The project includes five (5) new buildings with associated parking, grading and utilities (including a new public well, approved by DOH, and new OWTS, approved by RIDEM. Stormwater treatment includes bioretention areas and permeable pavement.

Project Location:	3769 Old Post Road
City/Town:	Charlestown
Plat/Lot:	Plat 13, lot 30
Waterway:	Salt Pond Watershed

Plans of the proposed work can be requested at Cstaffl@crmc.ri.gov.

In accordance with the Administrative Procedures Act (Chapter 42-35 of the Rhode Island General Laws) you may request a hearing on this matter.

You are advised that if you have good reason to enter protests against the proposed work it is your privilege to do so. It is expected that objectors will review the application and plans thoroughly, visit site of proposed work if necessary, to familiarize themselves with the conditions and cite what law or laws, if any, would in their opinion be violated by the work proposed.

If you desire to protest, you must attend the scheduled hearing and give sworn testimony. A notice of the time and place of such hearing will be furnished you as soon as possible after receipt of your request for hearing. If you desire to request a hearing, to receive consideration, it should be in writing (with your correct mailing address, e-mail address and valid contact number) and be received at this office on or before May 30, 2024.

Please email your comments/hearing requests to: cstaffl@crmc.ri.gov; or mail via USPS to: Coastal Resources Management Council; O. S. Government Center, 4808 Tower Hill Road, Rm 116; Wakefield, RI 02879.

PRELIMINARY PLAN SUBMISSION

FOR A

MAJOR LAND DEVELOPMENT

"SHORELINE PLAZA" 3769 OLD POST ROAD A.P. 13 LOT 30

CHARLESTOWN, RHODE ISLAND

SOLARIA RI, LLC COMMERCIAL PROPERTIES PO BOX 225 HOCKESSIN, DE 19707

APPLICANT: JOHN SULLIVAN PO BOX 225 HOCKESSIN, DE 19707

PROFESSIONAL ENGINEER

20,000 SQ. FT.

120'

20'

35'



PREPARED BY:

PRINCIPE COMPANY, INC.

ENGINEERING DIVISION

27 SAKONNET RIDGE DRIVE TIVERTON, RHODE ISLAND 02878 401.816.5385

FEBRUARY 15, 2024

PROJECT DATA:

PLAT: 13 LOT: 30 LOT AREA: 396,941 SF, 9.12 ACRES EXISTING:

EXISTING SIX-UNIT COMMERCIAL BUILDING (ONE STORY): 8,600 SF EXISTING PARKING AND SIDEWALK SURFACÈ: 37,410 SF 2.2% EXISTING BUILDING COVERAGE: 11.6% TOTAL EXISTING IMPERVIOUS COVERAGE:

PROPOSED: EXISTING SIX-UNIT COMMERCIAL BUILDING (ONE STORY): 8,600 SF PROPOSED COMMERCIAL BUILDINGS (6) ARÈA: PROPOSED SIDEWALK AREA:

PROPOSED PARKING/DRIVEWAY AREA: PROPOSED BUILDING COVERAGE: TOTAL PROPOSED IMPERVIOUS COVERAGE:

TOTAL AREA OF DISTURBANCE (EX.+PROP.): TOTAL AREA OF UNDISTURBED WOODED AREA:

24,738 SF FLOOR AREA 14,817 SF 61,848 SF 34,293 SF, 8.6% 110,003 SF, 27.7%

208,667 SF 188,274 SF, 47.4% OF PARCEL

ZONING DESIGNATION:

ZONING DISTRICT: TVD MINIMUM LOT AREA MINIMUM LOT FRONTAGE FRONT YARD SETBACK MINIMUM SIDE YARD SETBACK MINIMUM REAR YARD SETBACK MAXIMUM BUILDING COVERAGE MAXIMUM BUILDING HEIGHT

STREET INDEX

POST ROAD (RI ROUTE 1) (PUBLIC- STATE HIGHWAY)

OLD POST ROAD (PUBLIC- TOWN)

LIST OF DRAWINGS

- 1) TITLE SHEET
- 2) AERIAL OVERLAY RADIUS MAP
- 3) EXISTING CONDITIONS PLAN
- 4) PROPOSED DEVELOPMENT PLAN
- 5) RIDOT PAP PLAN
- 6) SESC PLAN
- 7) LANDSCAPE PLAN
- 8) DETAILS-1
- 9) DETAILS-2
- 10) DETAILS-3
- 11) DETAILS-4
- 12) DETAILS-5
- 13) DETAILS-6

*TOWN MASTER PLAN APPROVAL WAS RECEIVED ON OCTOBER 26, 2022

- REQUIRED TOWN/STATE APPROVALS:
- * TOWN MAJOR LAND DEVELOPMENT (PLANNING)
- * SITE PLAN REVIEW (PLANNING) FOR GWP
- * RIDEM OWTS
- * RIDEM RIPDES
- * RIDOH (PUBLIC WELL)
- * RIDOT PAP
- * CRMC ASSENT (SALT POND WATERSHED)



	SCALE: 1"=100' EXISTING	<u>PLAN SET LEGEND</u>	PROPOSED
PERIMETER LINE			
ABUTTER LINE			
FENCE	XXXX		XXX
CONTOUR	122		122
SURVEY BOUND			
JTILITY POLE			
OVERHEAD WIRE			
DRAINLINE	DD		D
WATERLINE	W W		W
WATER GATE VALVE			wv ⋈
SEWER MANHOLE	S		S
SEWERLINE			s
GAS LINE	G G _		
GAS VALVE	GV		
EROSION CONTROL		_	· · · · · · · · · · · · · · · · · · ·
STONEWALL		DODO:	
SIDEWALK	makkisa		
TREE			
TREE TO BE REMOVED			
LIMIT OF DISTURBANC			——————————————————————————————————————
TEST PIT	₽		
BENCHMARK	\triangle		
WELL			®
SOILS LINE	<u>UD</u>		
EDGE OF PAVEMENT			
LIGHT POLE			ф




GRAPHIC SCALE

(IN FEET) 1 inch = 100 ft.




200 FOOT RADIUS LOCUS MAP SCALE: 1"=100'

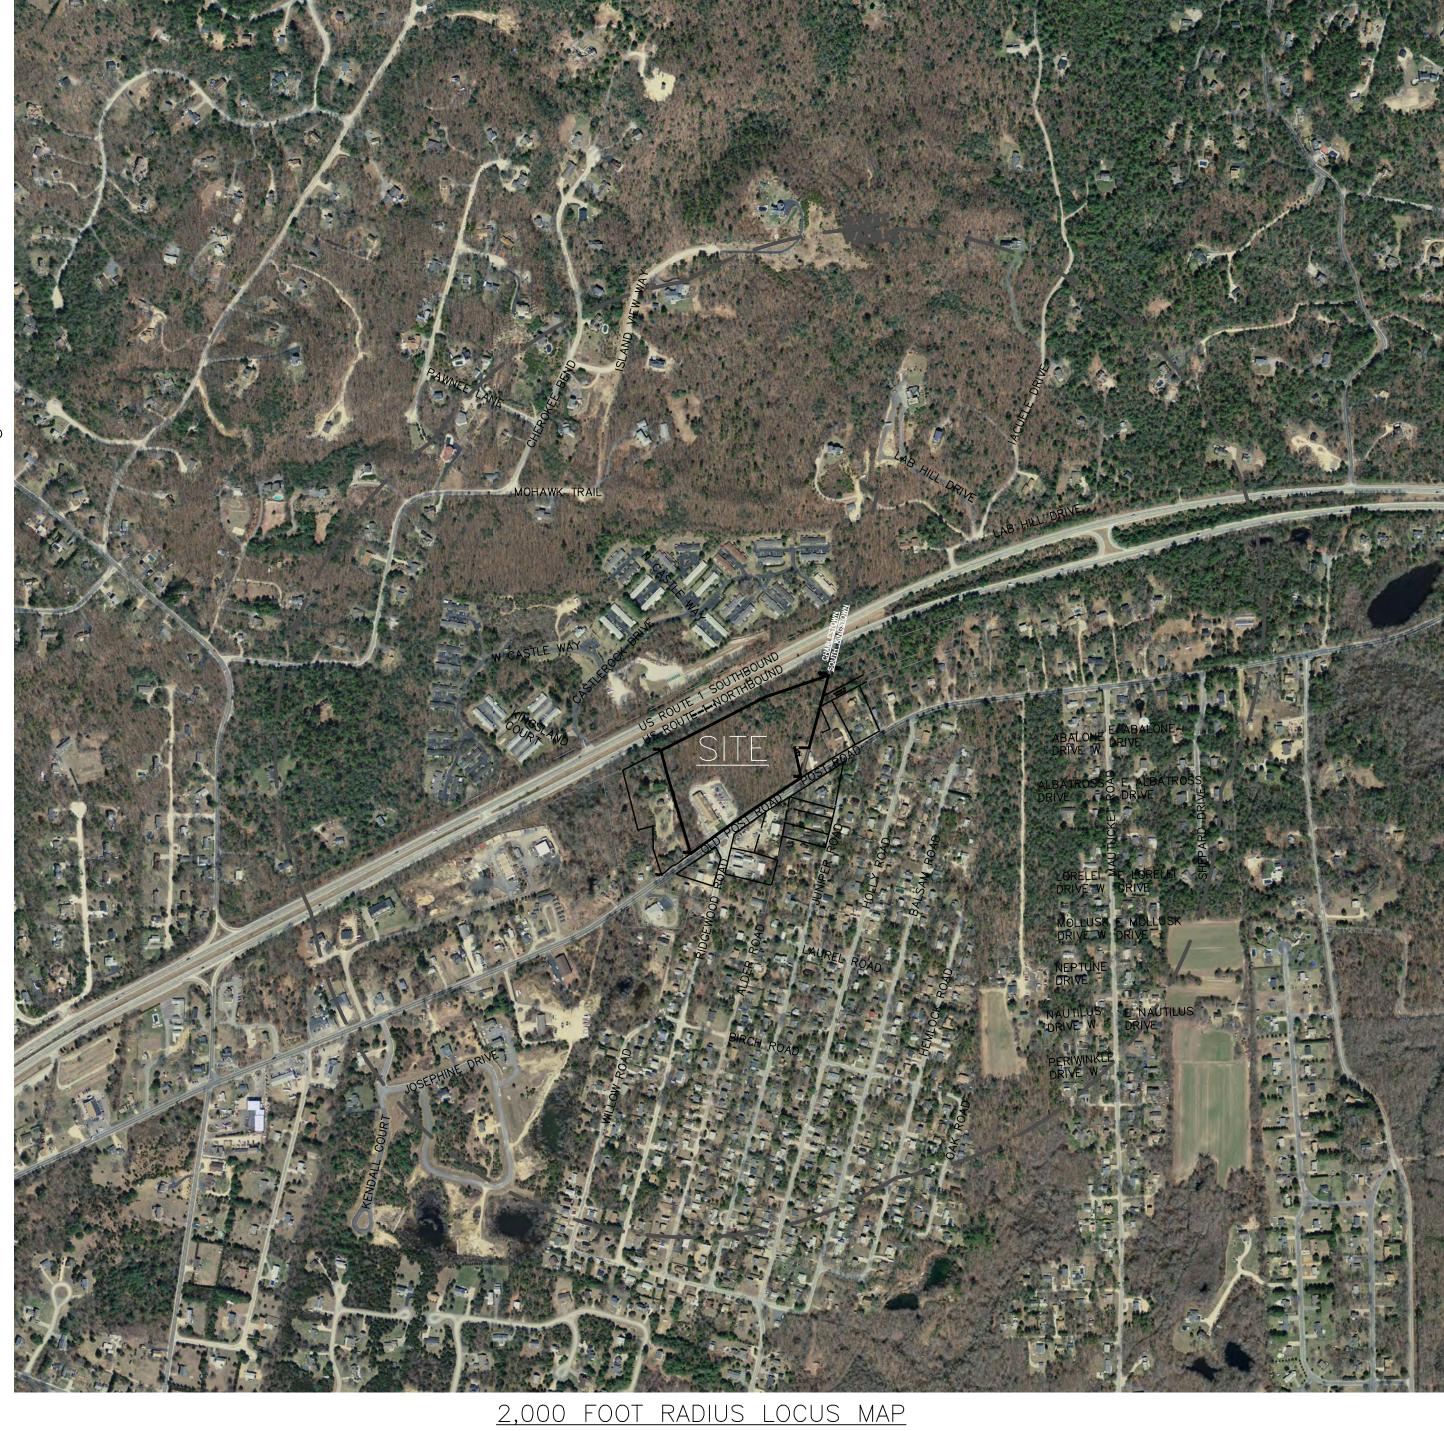

SCALE: 1"=500' GRAPHIC SCALE

(IN FEET) 1 inch = 500 ft.

AERIAL OVERLAY RADIUS MAP

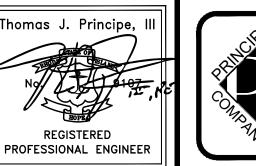

PRINCIPE COMPANY, INC. ENGINEERING DIVISION

27 SAKONNET RIDGE DRIVE TIVERTON, RI 02878 401.816.5385

ESTABLISHED IN 1981 www.PrincipeEngineering.com

PRELIMINARY PLAN SUBMISSION REVISIONS No. DATE DRWN CHKD

"SHORELINE PLAZA" a

MAJOR LAND DEVELOPMENT

#3769 OLD POST ROAD

AP 13, LOT 30

CHARLESTOWN, RHODE ISLAND

SHEET NO: 2 OF 13 DESIGN BY: JAR CHECKED BY: TJP DRAWN BY: KAB PROJECT NO.: 21051.00 DATE: 02/15/2024

COMMERCIAL PROPERTIES
PO BOX 225
HOCKESSIN, DE 19707

<u>APPLICANT:</u> JOHN SULLIVAN PO BOX 225 HOCKESSIN, DE 19707

EX. ±11'X38'

COMMERCIAL SHED

2. THIS PROPERTY FALLS WITHIN AN AREA OF MINIMAL FLOOD HAZARD - ZONE X AS MAPPED BY FIRM #44009C0188J DATED 10/16/2013. 3. SOILS ON SITE ARE CLASSIFIED AS CANTON AND CHARLTON FINE SANDY LOAMS, O TO 8 PERCENT SLOPES, VERY STONY (ChB) AND UDORTHENTS-URBAN LAND COMPLEX (UD) AS IDENTIFIED BY THE USDA RI SOIL SURVEY. THERE ARE NO AREAS OF PRIME AGRICULTURAL SOIL AND/OR FARMLAND SOILS ON THE PROPERTY. 4. THERE ARE NO AREAS OF EXISTING, ACTIVE AGRICULTURAL USE ON

5. THERE ARE NO WETLANDS ON OR IN THE VICINITY OF THE

6. THERE ARE NO HISTORIC CEMETERIES PRESENT ON THE SUBJECT PARCEL. IT IS NOT LOCATED WITHIN A NATURAL HERITAGE AREA AS DEFINED BY THE TOWN OF CHARLESTOWN COMPREHENSIVE PLAN. 7. THE SUBJECT PARCEL IS LOCATED WITHIN A SPECIAL AREA MANAGEMENT PLAN OF THE RI CRMC AND DEFINED AS LAND USE CODE "DEVELOPED BEYOND CARRYING CAPACITY." 8. THERE ARE NO PUBLIC FACILITIES WITHIN 2,000 FEET OF THE

9. THE SUBJECT PARCEL IS LOCATED WITHIN AN OWTS CRITICAL RESOURCE AREA AS DEFINED BY RIDEM. 10. THE SUBJECT PARCEL IS NOT LOCATED WITHIN A DRINKING WATER

11. THE DEVELOPMENT PARCEL IS NOT LISTED ON THE NATIONAL

THE SUBJECT PROPERTY IS SUBJECT TO ANY EASEMENTS, RIGHTS-OF-WAY, RESTRICTIONS, RESERVATIONS OR OTHER LIMITATIONS WHICH MAY BE REVEALED BY A FULL EXAMINATION OF THE TITLE. 13. THE SUBJECT PARCEL IS LOCATED WITHIN A TOWN OF CHARLESTOWN GROUNDWATER PROTECTION OVERLAY DISTRICT 14. THERE ARE NO COASTAL FEATURES WITHIN 200 FEET OF THE

15. THE LOCATION AND DEPTH OF EXISTING UTILITIES ARE APPROXIMATE AND HAVE BEEN PLOTTED FROM THE LATEST AVAILABLE INFORMATION. THE UTILITY LOCATIONS ARE APPROXIMATE AND MAY NOT BE ALL INCLUSIVE. THE CONTRACTOR SHALL CHECK AND VERIFY THE LOCATIONS OF ALL EXISTING UTILITIES, BOTH OVERHEAD AND UNDERGROUND, AND "DIG-SAFE" MUST BE NOTIFIED PRIOR TO COMMENCING ANY CONSTRUCTION OPERATIONS. RESTORATION AND REPAIR OF DAMAGE TO EXISTING UTILITIES SHALL BE THE RESPONSIBILITY OF THE CONTRACTOR WITH NO ADDITIONAL COST THE OWNER. NO EXCAVATION SHALL COMMENCE UNTIL ALL INVOLVED UTILITY COMPANIES AND/OR TOWN WHOSE FACILITIES MIGHT BE AFFECTED BY ANY WORK TO BE PERFORMED BY THE CONTRACTOR

ENGINEER HAVE WALKED THE SITE OF THE PROPOSED PROJECT. 17. THE APPLICANT AND/OR THEIR REPRESENTATIVE AND THEIR ENGINEER HAVE HEAD AND UNDERSTAND SECTION 4.3 CONSTRAINTS

> THIS SURVEY HAS BEEN CONDUCTED AND THE PLAN HAS BEEN PREPARED PURSUANT TO 435-RICR-00-00-1.9 OF THE RULES AND REGULATIONS ADOPTED BY THE RHODE ISLAND STATE BOARD OF REGISTRATIONS FOR PROFESSIONAL LAND SURVEYORS NOVEMBER 25, 2015 AS FOLLOWS:

TYPE OF SURVEY: LIMITED CONTENT BOUNDARY SURVEY MEASUREMENT SPECIFICATION: CLASS 1 STANDARD/CLASS 3 TOPO

PURPOSE OF SURVEY: EXISTING CONDITIONS

JOHN SULLIVAN

HOCKESSIN, DE 19707

PO BOX 225

EXISTING CONDITIONS PLAN

PRINCIPE COMPANY, INC. ENGINEERING DIVISION

27 SAKONNET RIDGE DRIVE TIVERTON, RI 02878 401.816.5385

www.PrincipeEngineering.com

PRELIMINARY PLAN SUBMISSION "SHORELINE PLAZA" a MAJOR LAND DEVELOPMENT #3769 OLD POST ROAD AP 13, LOT 30


CHARLESTOWN, RHODE ISLAND

SHEET NO: 3 OF 13 SCALE: 1"=50' CHECKED BY: TJP DRAWN BY: KAB DESIGN BY: ---PROJECT NO.: 21051.00 DATE: 02/15/2024

EX. ±11'X38'





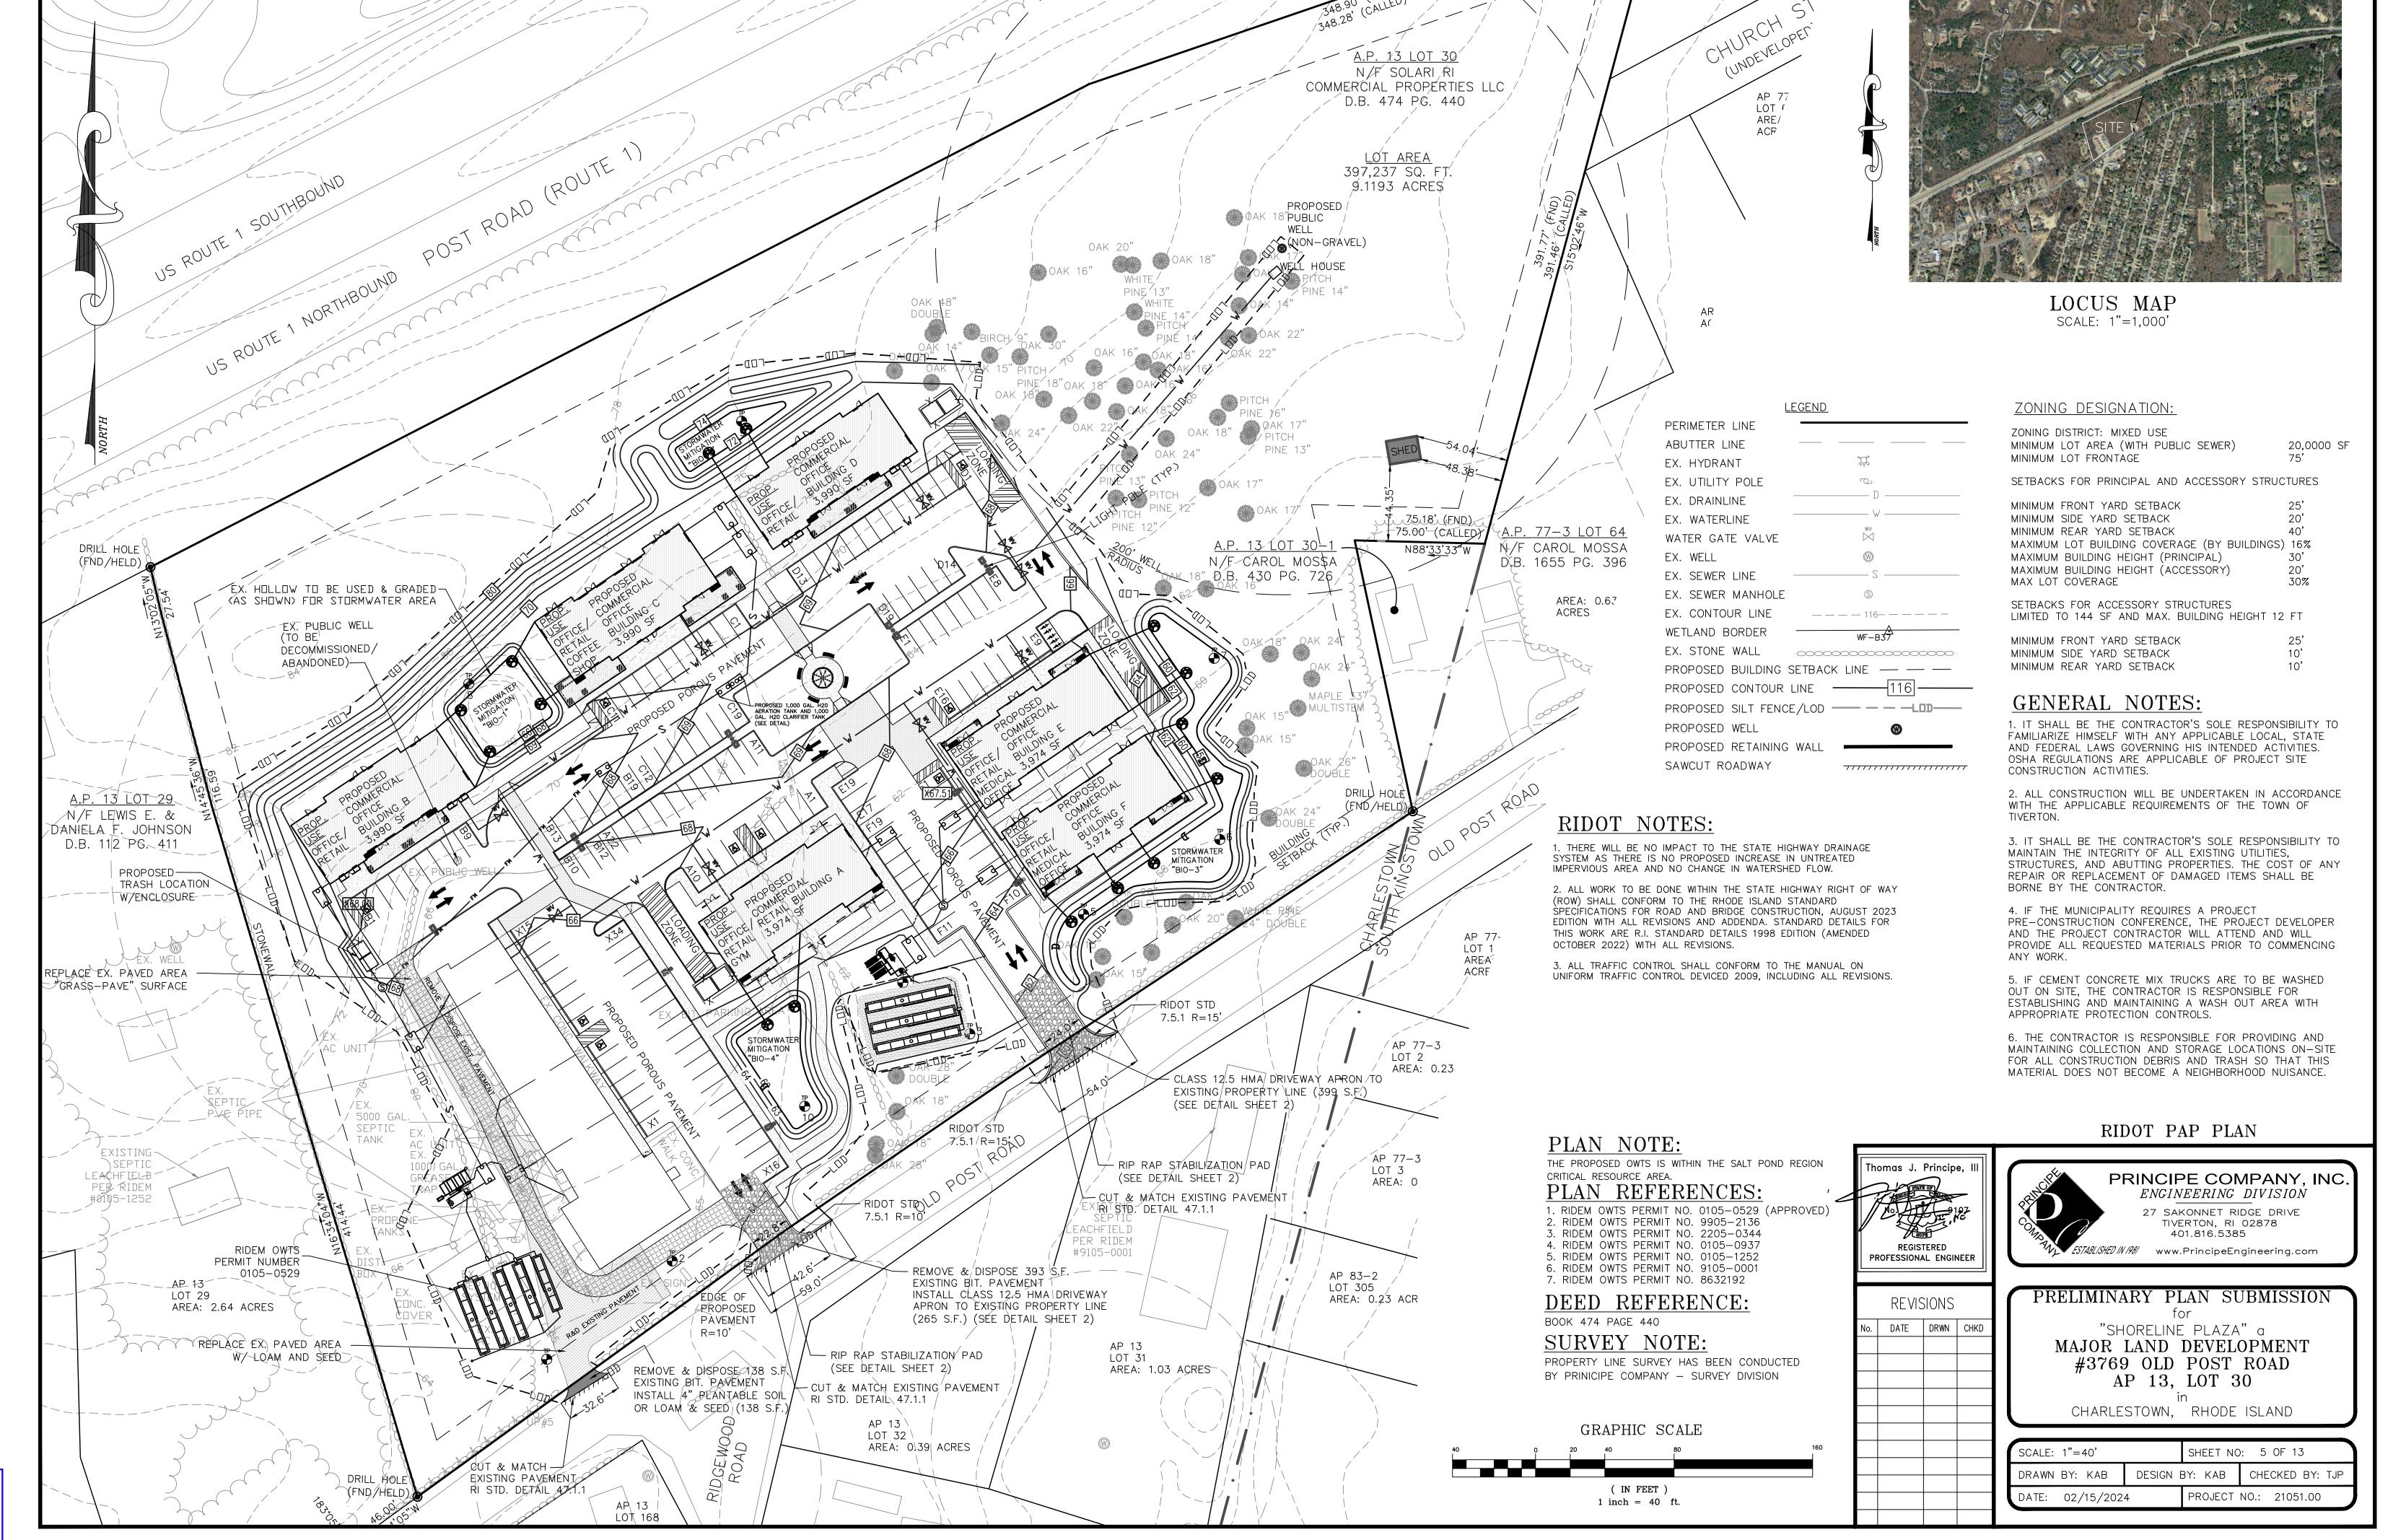

EX. ±11'X38'





VEGETATIVE COVER AND PLANTING

1. THE NORMAL ACCEPTABLE SEASONABLE SEEDING DATES ARE APRIL 1ST THROUGH OCTOBER 15TH.

2. TOP SOIL FOR PERMANENT OR LONG TERM TEMPORARY SEEDING SHOULD HAVE A SANDY LOAM TEXTURE, RELATIVELY FREE OF SUBSOIL MATERIAL, STONES, ROOTS, LUMPS OF SOIL, TREE LIMBS, TRASH OR CONSTRUCTION DEBRIS. TOP SOIL SHALL CONFORM WITH RHODE ISLAND SPECIFICATIONS.

3. THE DESIGN SEED MIX UTILIZED IN ALL DISTURBED AREAS TO BE SEEDED SHALL BE COMPRISED OF THE FOLLOWING:

PE % BY WEIGHT SEEDING DATE

CREEPING RED FESCUE 70

ASTORIA BENTGRASS 5 APRIL 1 - JUNE 15
BIRDFOOT TREFOIL 15 AUGUST 15 - OCTOBER 15

PERENNIAL RYE GRASS 10

APPLICATION RATE - 100 LBS PER ACRE

SEED MIX SHALL BE INOCULATED WITHIN 24 — HOURS BEFORE MIXING AND PLANTING, WITH APPROPRIATE INOCULATION FOR EACH SEED VARIETY. ALTERNATE SEED TYPES DUE TO SITE SPECIFIC CONDITIONS AND SOILS ARE ACCEPTABLE WITH THE ENGINEER'S APPROVAL.

4. IN TOPSOIL SEEDING AREAS, THE CONTRACTOR WILL LIME AND FERTILIZE AS REQUIRED TO COMPLIMENT OR UPGRADE SOIL CONDITIONS.

5. THE CONTRACTOR MUST REPAIR AND/OR RESEED ANY PERMANENT VEGETATIVE COVER AREAS THAT DO NOT DEVELOP OR WHICH ERODE WITHIN A ONE (1) YEAR PERIOD.

EROSION CONTROL, SOIL STABILIZATION AND SEDIMENT CONTROL PLAN

1. PRIOR TO THE COMMENCEMENT OF ANY CLEARING, GRUBBING, DEMOLITION OR EARTHWORK ACTIVITY, TEMPORARY EROSION AND SEDIMENT CONTROL MEASURES AS INDICATED ON THE PLANS ARE TO BE INSTALLED BY THE CONTRACTOR.

2. CONSTRUCTION ACCESS STABILIZATION ENTRANCE PADS ARE TO BE INSTALLED PRIOR TO THE COMMENCEMENT OF SITE GRUBBING OR EARTHWORK ACTIVITY.

3. EXISTING CATCH BASINS ARE TO BE PROTECTED WITH STRAW BALES AND/OR SILT SACS PRIOR TO THE START OF SITE GRUBBING, EARTHWORK OR UNDERGROUND UTILITY AND DRAINAGE INFRASTRUCTURE INSTALLATION TO SERVE THE DEVELOPMENT SITE

4. THE PROJECT CONSTRUCTION SEQUENCE, TO THE EXTENT PRACTICAL, SHOULD REQUIRE THE INSTALLATION OF DOWN GRADE AND OFF SITE STORM DRAINAGE SYSTEM IMPROVEMENTS BEFORE THE START OF SITE GRUBBING AND EARTHWORK ACTIVITY.

5. TEMPORARY SITE SLOPE TREATMENTS FOR SOIL STABILIZATION SHALL CONSIST OF STRAW, FIBER MULCH, RIP RAP OR PROTECTIVE COVERS SUCH AS MAT OR FIBER LINING (BURLAP, JUTE, FIBERGLASS NETTING, AND EXCELSIOR OR EQUAL PRODUCTS). THESE AND OTHER ACCEPTABLE MEASURES SHALL BE INCORPORATED INTO THE SITE WORK AS WARRANTED OR AS ORDERED BY THE ENGINEER.

6. CONSTRUCTION SITES ARE DYNAMIC, THE CONTRACTOR IS RESPONSIBLE FOR THE INSTALLATION AND OR MOVEMENT AND MAINTENANCE OF EROSION CONTROLS, SOIL STABILIZATION AND SEDIMENT CONTROL MEASURES AS NEEDED TO MAXIMIZE THE INTENT OF THE PLAN FOR ALL SITE CONDITIONS THROUGHOUT THE CONSTRUCTION PERIOD.

7. THE CONTRACTOR SHALL BE RESPONSIBLE FOR PERIODIC INSPECTION, MAINTENANCE, REPAIR, AND REPLACEMENT OF EROSION CONTROLS, SOIL STABILIZATION AND SEDIMENT CONTROL DEVICES UNTIL AN ACCEPTABLE PERMANENT VEGETATIVE GROWTH IS ESTABLISHED. THE CONTRACTOR SHALL MAINTAIN A DETAIL LOG OF ALL EROSION CONTROL INSPECTIONS, COMPLAINTS RELATED TO EROSION OR SEDIMENT, AND CORRECTIVE REMEDIAL MEASURES TAKEN THROUGHOUT THE COURSE OF THE PROJECT CONSTRUCTION.

8. SOIL EROSION AND SEDIMENT CONTROL IS NOT LIMITED TO DAMAGES CAUSED BY WATER BUT ALSO INCLUDES EROSION AND SEDIMENT RESULTING FROM WINDS. MEASURES, SUCH AS TEMPORARY GROUND COVERS, WATER AND CALCIUM APPLICATIONS ARE TO BE UNDERTAKEN AS NEEDED TO MINIMIZE WIND RELATED SOIL AND DUST CONTROL.

9. STOCK PILES OF EARTH MATERIALS SHALL NOT BE LOCATED NEAR WATERWAYS OR WETLANDS. STOCK PILES SHALL HAVE SIDE SLOPES NO GREATER THAN THIRTY PERCENT (30%). STOCK PILES SHALL BE SURROUNDED ON THE DOWN GRADIENT OF THE EXISTING GROUND SURFACE BY HAY BALES OR SILT FENCE. THE STOCK PILES SHALL ALSO BE SEEDED OR STABILIZED IN SOME MANOR TO PREVENT SOIL EROSION.

10. THE SMALLEST POSSIBLE SITE AREAS SHALL BE DISTURBED OR EXPOSED AT ONE TIME AND DENUDED SLOPES OR WORK AREAS SHALL NOT BE LEFT EXPOSED FOR EXCESSIVE PERIODS OF TIME, SUCH AS INACTIVE PERIODS OR SITE WORK SHUT DOWNS.

11. TO THE EXTENT POSSIBLE, ALL DISTURBED AREAS MUST BE SEEDED OR STABILIZED WITHIN THE CONSTRUCTION SEASON STABILIZATION OF ONE FORM OR ANOTHER SHALL BE ACHIEVED WITHIN FIFTEEN (15) DAYS OF FINAL GRADING.


12. EXPOSED STEEP OR LONG SLOPES SHOULD BE TREATED WITH "CRIMPING" OR "TRACKING" TO REDUCE EROSION AND SEDIMENT AND TO TACK DOWN SEEDING OR MULCH APPLICATIONS.

13. IF CONCRETE IS TO BE USED ON SITE, THE CONTRACTOR MUST ESTABLISH AND MAINTAIN SPECIFIC WASHOUT AREAS FOR THE CONCRETE TRUCKS WITH APPROPRIATE PROTECTION CONTROLS.

14. THE CONTRACTOR IS RESPONSIBLE FOR PROVIDING AND MAINTAINING COLLECTION AND STORAGE LOCATIONS ON—SITE FOR ALL CONSTRUCTION DEBRIS AND TRASH SO THAT THIS MATERIAL DOES NOT BECOME A NEIGHBORHOOD NUISANCE.

15. EXISTING TREES AND VEGETATION WILL BE RETAINED WHENEVER FEASIBLE.

16. SITE SOIL EROSION AND SOIL STABILIZATION AND SEDIMENT CONTROLS MUST CONFORM TO ALL REQUIREMENTS OF THE APPLICABLE LOCAL COMMUNITY ORDINANCES AND STATE REGULATIONS.

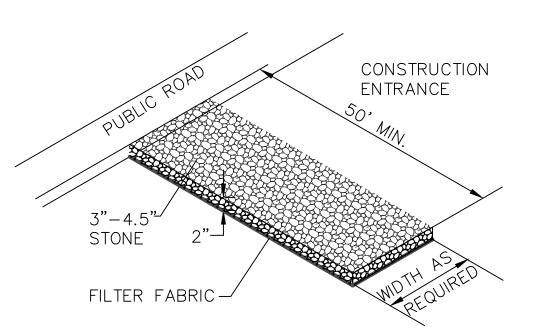

	MATERIALS	SIZE	
SQUARE MESH SIEVES	2"CRUSHED STONE OR GRAVEL	ASTM C-33 NO. 2	ASTM C-33 NO. 3
	% FINER	% FINER	% FINER
2-1/2 INCHES 2 INCHES 1-1/2 INCHES 1-1/4 INCHES	100 95-100 30-55 0-25	90-100 35-70 0-15 -	100 90-100 35-70 -
1 INCH	0-5	_	0-15
3/4 INCH	_	0-5	_
1/2 INCH	_	_	0-5
3/8 INCH	_	_	_

RIP-RAP STABILIZATION PAD @

CONSTRUCTION ENTRANCE

NOT TO SCALE

GENERAL NOTES:

1. IT SHALL BE THE CONTRACTOR'S SOLE RESPONSIBILITY TO FAMILIARIZE HIMSELF WITH ANY APPLICABLE LOCAL, STATE AND FEDERAL LAWS GOVERNING HIS INTENDED ACTIVITIES. OSHA REGULATIONS ARE APPLICABLE OF PROJECT SITE CONSTRUCTION ACTIVITIES.

2. ALL CONSTRUCTION WILL BE UNDERTAKEN IN ACCORDANCE WITH THE APPLICABLE REQUIREMENTS OF THE TOWN OF CHARLESTOWN.

3. IT SHALL BE THE CONTRACTOR'S SOLE RESPONSIBILITY TO MAINTAIN THE INTEGRITY OF ALL EXISTING UTILITIES, STRUCTURES, AND ABUTTING PROPERTIES. THE COST OF ANY REPAIR OR REPLACEMENT OF DAMAGED ITEMS SHALL BE BORNE BY THE CONTRACTOR.

4. IF THE MUNICIPALITY REQUIRES A PROJECT PRE-CONSTRUCTION CONFERENCE, THE PROJECT DEVELOPER AND THE PROJECT CONTRACTOR WILL ATTEND AND WILL PROVIDE ALL REQUESTED MATERIALS PRIOR TO COMMENCING ANY WORK.

5. IF CEMENT CONCRETE MIX TRUCKS ARE TO BE WASHED OUT ON SITE, THE CONTRACTOR IS RESPONSIBLE FOR ESTABLISHING AND MAINTAINING A WASH OUT AREA WITH APPROPRIATE PROTECTION CONTROLS.

6. THE CONTRACTOR IS RESPONSIBLE FOR PROVIDING AND MAINTAINING COLLECTION AND STORAGE LOCATIONS ON—SITE FOR ALL CONSTRUCTION DEBRIS AND TRASH SO THAT THIS MATERIAL DOES NOT BECOME A NEIGHBORHOOD NUISANCE.

ORDER OF PROCEDURE:

PRIOR TO ANY CLEARING AND GRUBBING OR ANY ROUGH GRADING, TEMPORARY STRAW BALES AND SANDBAGS SHALL BE PLACED OUTSIDE THE LIMITS OF CONSTRUCTION AS PER THE PLANS (I.E. ALONG ROADWAYS, STREAM BANKS, CRITICAL AREAS, ETC.).

ALL EROSION AND SEDIMENTATION CONTROL STRUCTURES SHALL BE PERIODICALLY MAINTAINED AS PER THE RESPECTIVE PROGRAMS FOR TEMPORARY CONTROL.

IF WORK PROGRESS IS TO BE INTERRUPTED AT ANY TIME, REFERENCE EROSION AND SEDIMENTATION PROGRAMS FOR TEMPORARY CONTROL.

TEMPORARY STRAW BALES AND SANDBAGS ALONG AND AT THE ENDS OF ROADWAYS MAY ALSO BE REMOVED AFTER FINAL SOIL STABILIZATION HAS BEEN ACHIEVED AND APPROVED.

STRAW BALES LOCATED AT DRAINAGE OUTLETS MUST REMAIN UNTIL SUCH TIME THAT A DESIRABLE STAND OF GRASS OR COVER HAS BEEN ESTABLISHED AND THE PROJECT RECEIVES A FAVORABLE APPROVAL FOR FINAL ACCEPTANCE FROM THE ENGINEER.

SEDIMENTATION CONTROL PROGRAM:

RIP RAP SPLASH PADS SHALL BE INSTALLED AT THE OUTLETS FOR ALL CULVERTS DISCHARGING INTO A WATERWAY.

EXTREME CARE SHALL BE EXERCISED SO AS TO PREVENT ANY UNSUITABLE MATERIAL ENTERING THE WETLANDS.

ALL DISTURBED AREAS SUBJECT TO EROSIVE TENDENCIES WHETHER THEY BE NEWLY FILLED OR EXCAVATED SHALL BE SEEDED

AND PROTECTED WITH A FIBER MULCH.

DURING CONSTRUCTION, THE CONTRACTOR AND/OR DEVELOPER SHALL BE RESPONSIBLE FOR MAINTAINING DRAINAGE AND RUNOFF


FLOW DURING STORMS AND PERIODS OF RAINFALL.


SEDIMENTATION CONTROL DEVICES SHALL BE INSPECTED CLOSELY AND MAINTAINED PROMPTLY AFTER EACH RAINFALL.

CARE SHOULD BE TAKEN SO AS NOT TO PLACE "REMOVED SEDIMENTS" WITHIN THE PATH OF EXISTING, NEWLY CREATED (BOTH TEMPORARY AND PERMANENT) OR PROPOSED WATERCOURSES OR THOSE AREAS SUBJECTED TO STORM WATER FLOW.

ADDITIONAL STRAW BALES OR SANDBAGS SHALL BE LOCATED AS CONDITIONS WARRANT.


ALL SEDIMENTS SHALL BE REMOVED FROM THE DRAINAGE AND DETENTION FACILITIES AS SCHEDULED FOR EACH FACILITY

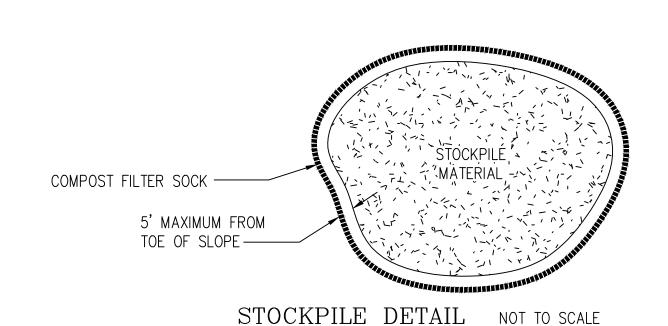


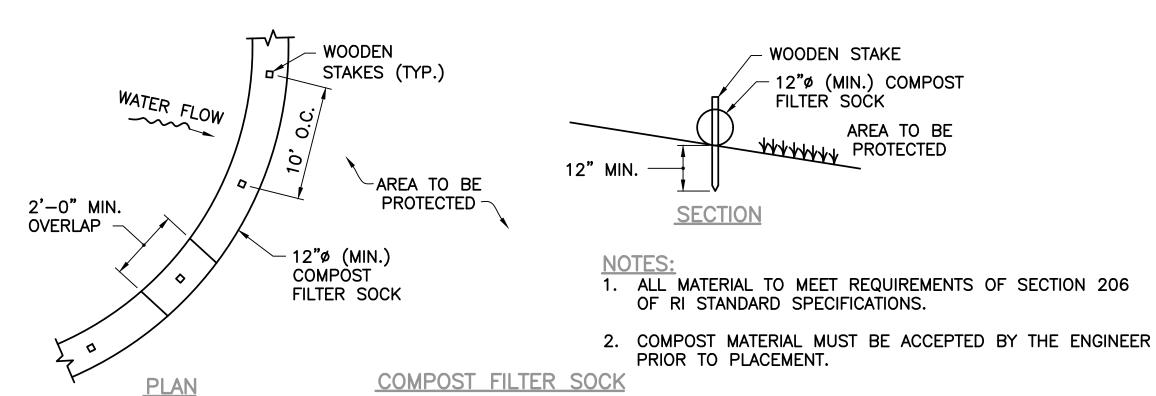


PERIMETER EROSION CONTROLS


NOT TO SCALE

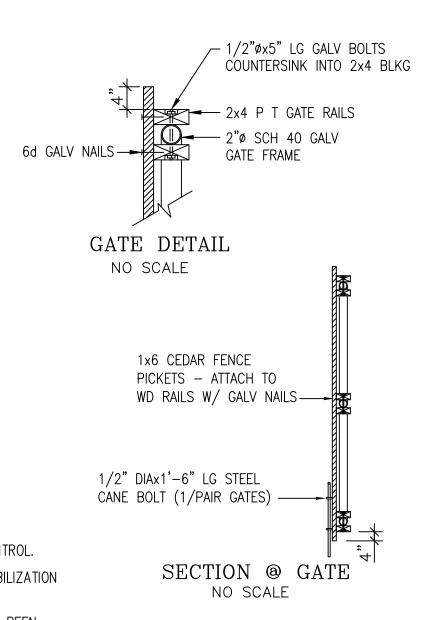

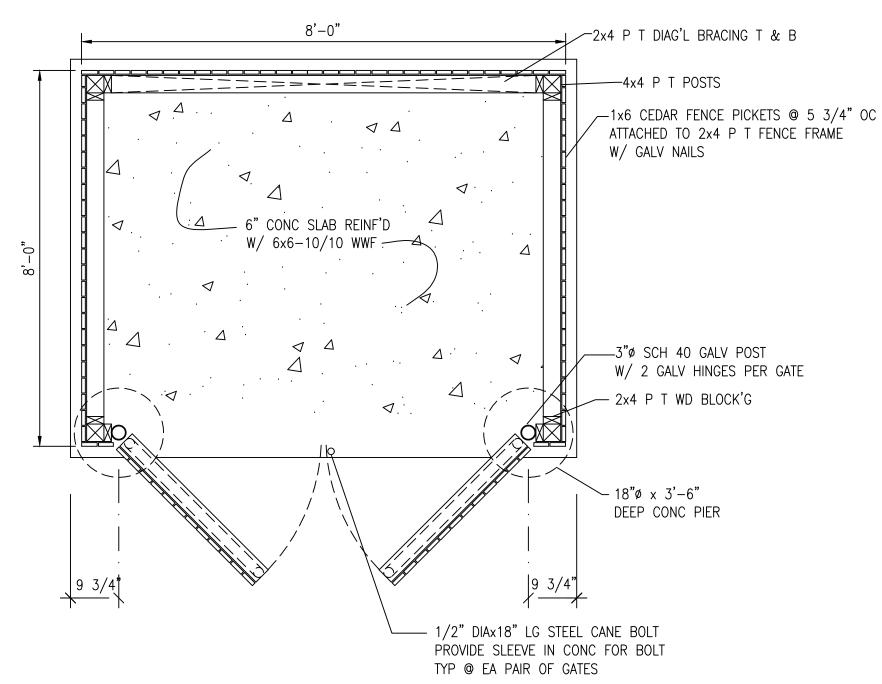

TRASH ENCLOSURE PLAN
NO SCALE

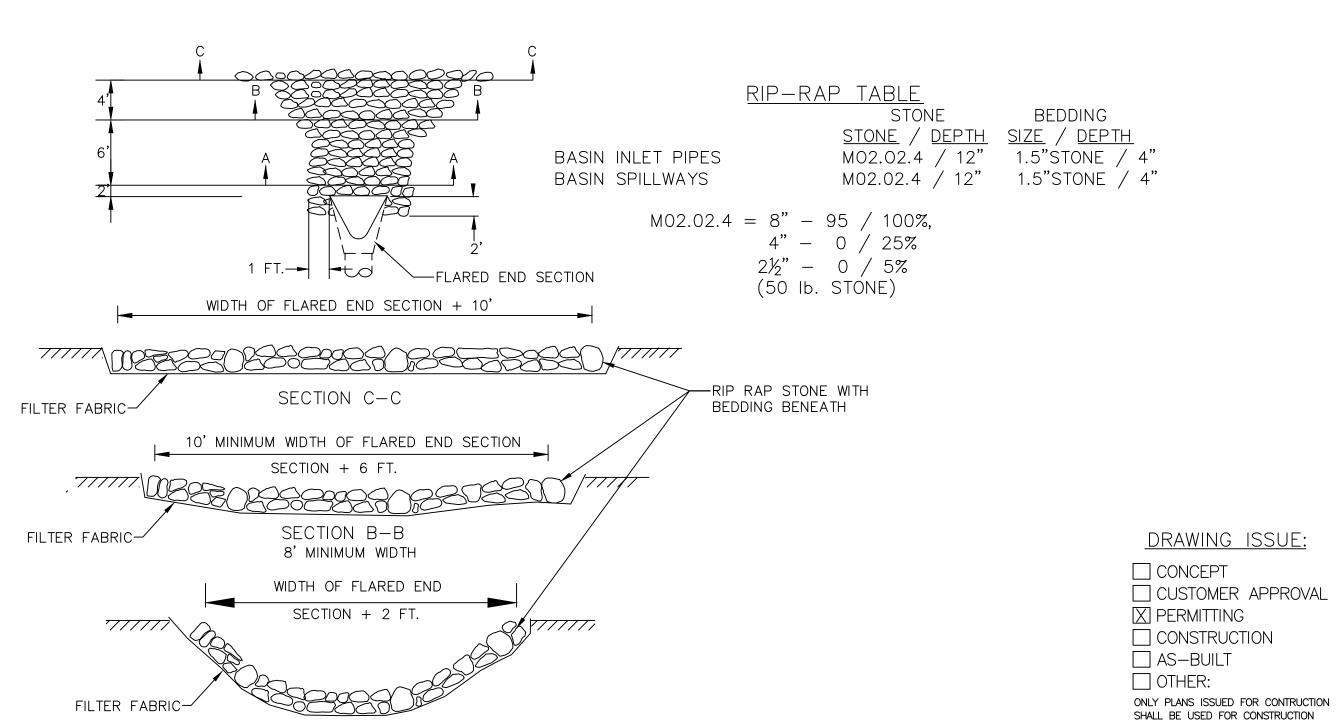


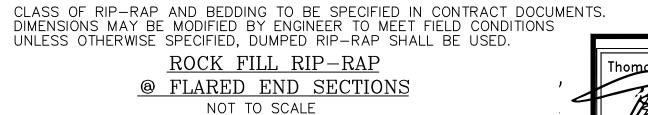

SECTION A-A

5' MINIMUM WIDTH

NOTES:

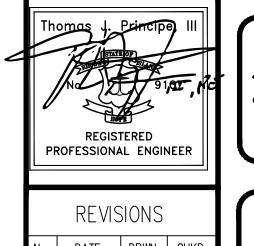



DETAILS-1

REVISIONS

DATE DRWN CHKD

MAJOR LAND DEVELOPMENT

#3769 OLD POST ROAD

AP 13, LOT 30

OWNER:
SOLARIA RI, LLC
OMMERCIAL PROPERTIES
PO BOX 225
HOCKESSIN, DE 19707
PO BOX 225

CHARLESTOWN, RHODE ISLAND

ALE: 1"=40' SHEET NO: 8 OF 13

DRAWN BY: KAB DESIGN BY: KAB CHECKED BY: TJF
DATE: 02/15/2024 PROJECT NO.: 21051.00



F.5.2.2 Bioretention Soil

The soil should be a uniform mix, free of stones, stumps, roots or other similar objects larger than two inches. No other materials or substances should be mixed or dumped within the bioretention area that may be harmful to plant growth, or prove a hindrance to the planting or maintenance operations. The bioretention soil should be free of noxious

The bioretention system shall utilize planting soil having a composition as follows: Sand: 85-88%

Soil fines: 8 to 12% (no more than 2% clay)

Organic Matter*: 3 to 5%

*Note: For bioretention applications with a soil depth of less than 4 feet, add 20% (by volume) of well aged (3 months), well aerated, leaf compost (or approved equivalent) to the above planting soil mixture. Where soil fines content is less than 12%, add a corresponding % of leaf compost.

A textural analysis is required to ensure the bioretention soil meets the specification listed above. The bioretention soil should also be tested for the following criteria: pH range 5.2 - 7.0

magnesium not to exceed 32 ppm phosphorus P205 not to exceed 69 ppm potassium K20 not to exceed 78 ppm soluble salts not to exceed 500 ppm


F.5.2.3 Mulch Layer Specifications.

A finely shredded, well—aged organic hardwood mulch is the preferred accepted mulch; a finely shredded, well—aged organic dark pine mulch may be accepted on a case—by case basis. Bark dust mulches and wood chips will float and move to the perimeter of the bioretention area during a storm event and are not acceptable. Shredded mulch must be well aged (6-12 months) for acceptance. Mix approximately ½ the specified mulch layer into the planting soil to a depth of approximately 4 inches to help foster a highly organic surface layer.

NOTES:

(1) BIORETENTION AREA TO BE PROTECTED FROM CONSTRUCTION TO PREVENT COMPACTION AND SURROUNDED BY COMPOST FILTER SOCK UNTIL UPSLOPE AREAS ARE STABILIZED.

(2) BIORETENTION DESIGN AND INSTALLATION SHALL CONFORM TO THE STATE OF RHODE ISLAND STORMWATER DESIGN AND INSTALLATION STANDARDS MANUAL (LATEST REVISION).

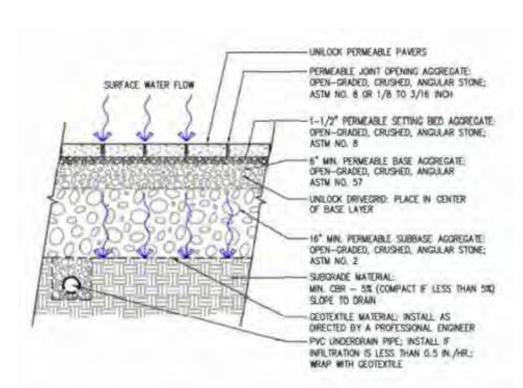

PERVIOUS CROSSWALK DETAIL NOT TO SCALE

DRAWING ISSUE:

☐ CONCEPT ☐ CUSTOMER APPROVAL X PERMITTING ☐ CONSTRUCTION AS-BUILT OTHER:

ONLY PLANS ISSUED FOR CONTRUCTION

SHALL BE USED FOR CONSTRUCTION

PO BOX 225

<u>APPLICANT:</u> JOHN SULLIVAN PO BOX 225 HOCKESSIN, DE 19707 HOCKESSIN, DE 19707

NOTE: METALLIC WARNING TAPE SHALL BE INSTALLED 12" ABOVE ALL STORM DRAIN LINES. METALLIC WARNING TAPE ___6"MIN. COVER 4"-48" DIA 12"MIN. COVER FOR GREATER THAN 48" DIA. HANCOR HDPE ----PIPE HAUNCHING/INITIAL MAINTAIN UNIFORM BACKFILL: CLASS TRENCH WIDTH TO I, II, III MIN. 12" ABOVE BACKFILL TOP OF PIPE MATERIAL INSTALLED PER -ASTM D2321 ---MINIMUM BEDDING THICKNESS 4"-6"

TOP ELE=A


ESHGWT=C

REFERENCE ASTM D2321, "STANDARD PRACTICE FOR UNDERGROUND INSTALLATION OF THERMOPLASTIC PIPE FOR SEWERS AND OTHER GRAVITY-FLOW APPLICATIONS."

HDPE TRENCH INSTALLATION DETAIL NOT TO SCALE

PIPE DIAMETER	TRENCH WIDTH	PIPE DIAMETER	TRENCH WIDTH
IN. (MM)	IN. (M)	IN. (MM)	IN. (M)
4 - 8 (100-200)	*	30 (750)	60 (1.5)
10 (250)	24 (0.6)	36 (900)	65 (1.7)
12 (300)	28 (0.7)	42 (1050)	84 (2.1)
15 (375)	35 (0.9)	48 (1200)	91 (2.3)
18 (450)	43 (1.1)	54 (1350)	97 (2.5)
24 (600)	56 (1.4)	60 (1500)	103 (2.6)

* USUALLY BASED ON SMALLEST BUCKET SIZE AVAILABLE

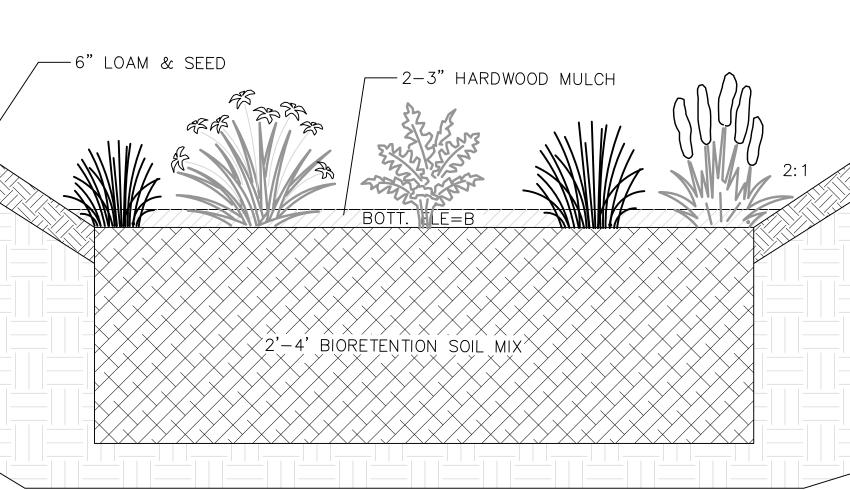

BIORETENTION AREA DETAIL

NOT TO SCALE

ELEVATION:	"A"	"B"	"C"
BIO-1	69.0	66.0	66.0
BIO-2	74.0	72.0	71.0
BIO-3	60.0	58.0	56.
BIO-4	64.0	62.0	58.

BOTANICAL NAME COMMON NAME

TOP ELE=A

85% COMPACTED NATIVE SOIL

PLANT SPECIES TO BE USED

ASTER DIVARICATUS WHITE WOOD ASTER

IRIS VERSICOLOR BLUE FLAG IRIS LOBELIA CARDINALIS CARDINAL FLOWER OSMUNDA CINNAMOMEA CINNAMON FERN

*PLANT SPECIES IN ONE GALLON CONTAINERS TO BE INSTALLED AT 2' O.C. IN GROUPS OF THREE WITHIN THE BIORETENTION AREA.

BMP REQUIRED MAINTENANCE:

MONTHLY:

INSPECT AND REMOVE ANY TRASH REMOVE ANY INVASIVE SPECIES PLANTS


ANNUALLY:

MULCH- SPRING, AS NEEDED REPLACE ANY DEAD VEGETATION—SPRING REMOVE DEAD VEGETATION—FALL OR SPRING PRUNE-SPRING

AS NEEDED:


REPLACE SOIL MEDIA AND PLANTS WHEN PONDING DOES NOT SUBSIDE WITHIN 72 HRS (CAREFUL MAINTENANCE SHOULD PROLONG THIS REQUIREMENT)

*ALL PLANT MATERIAL SHALL BE WATERED AND MAINTAINED BY THE OWNER TO ASSURE THAT SUITABLE GROWTH HAS

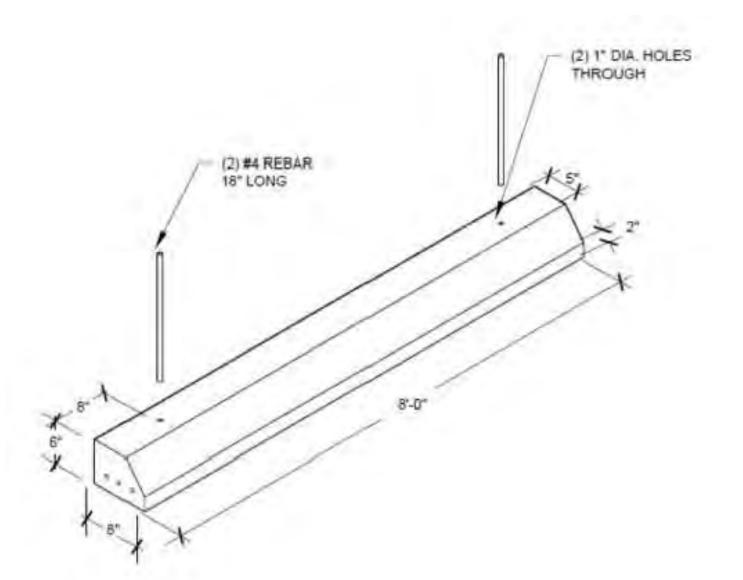

CONCRETE CURB STOP DETAIL NOT TO SCALE

DETAILS-2

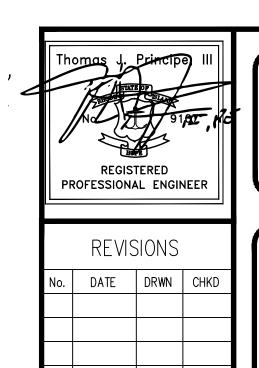


PRINCIPE COMPANY, INC. ENGINEERING DIVISION 27 SAKONNET RIDGE DRIVE TIVERTON, RI 02878 401.816.5385

STABLISHED IN 1981 www.PrincipeEngineering.com

PRELIMINARY PLAN SUBMISSION "SHORELINE PLAZA" a MAJOR LAND DEVELOPMENT #3769 OLD POST ROAD AP 13, LOT 30

CHARLESTOWN, RHODE ISLAND

SCALE: 1"=40' SHEET NO: 9 OF 13 DESIGN BY: KAB | CHECKED BY: TJF DRAWN BY: KAB PROJECT NO.: 21051.00 DATE: 02/15/2024

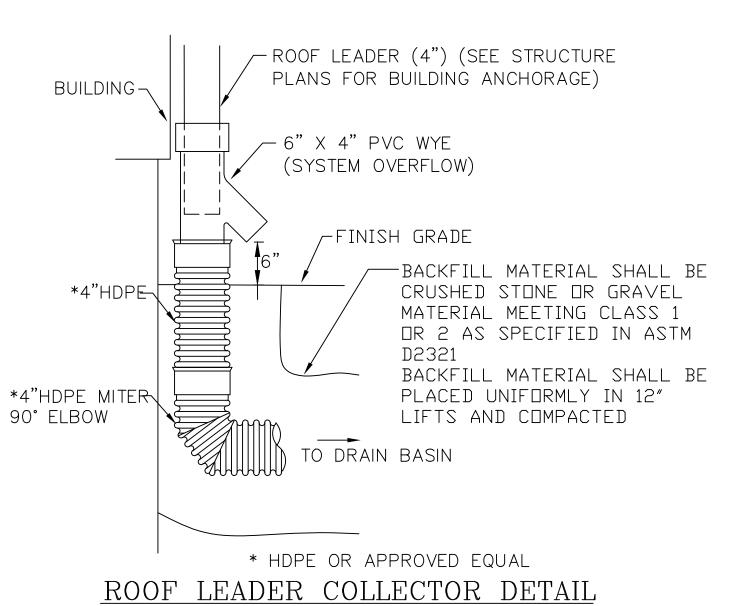

NOT TO SCALE



RECEIVED

2/22/2024

COASTAL RESOURCES
MANAGEMENT COUNCIL

DIAMOND DESIGN Rhode Island Stormwater Design and Installation Standards Manual Amended March 2015

Figure F-2 Typical Parking Area Cross-Section for Pervious Pavement System

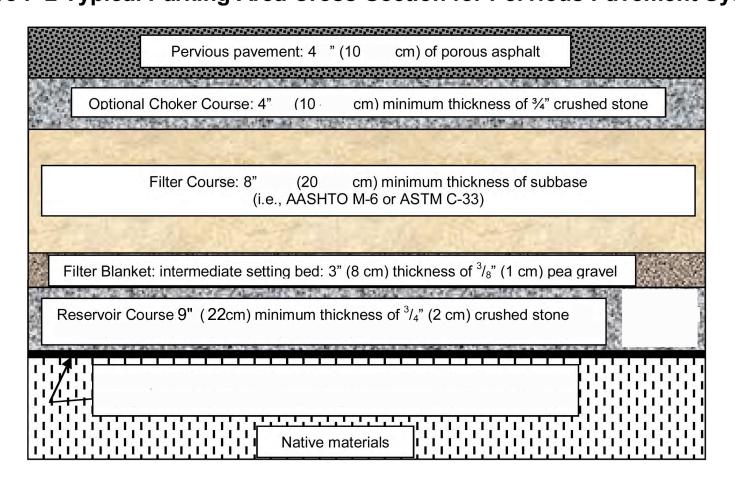



Table F-7 Gradations and compaction of choker, filter, and reservoir course matoriale

material	S.				
US	Percent Passing (%)				
Standard Sieve Size (inches/mm)	Choker Course (AASHTO No. 57)	Filter Course (AASHTO No. M-6)	Reservoir Course (AASHTO No.3)	Reservoir Course Alternative* (AASHTO No.5)	
6/150	-		-		
21/2/63	-		100	-	
2 /50	-		90 – 100	-	
1½/37.5	100		35 – 70	100	
1/25	95 - 100		0 – 15	90 – 100	
3⁄4/19	-		-	20 - 55	
1/2/12.5	25 - 60		0 - 5	0 - 10	
3/8/9.5	-	100	-	0 - 5	
#4/4.75	0 - 10	70-100	-		
#8/2.36	0 - 5		-		
#200/0.075		0 – 6**			
% Compaction ASTM D698 / AASHTO T99	95	95	95	95	

^{*} Alternate gradations (e.g. AASHTO No. 5) may be accepted upon Engineer's approval.

APPENDIX F: GUIDANCE ON BMP CONSTRUCTION SPECIFICATIONS

INFORMATION OBTAINED FROM 2015 RI STORMWATER DESIGN & INSTALLATION STANDARDS MANUAL

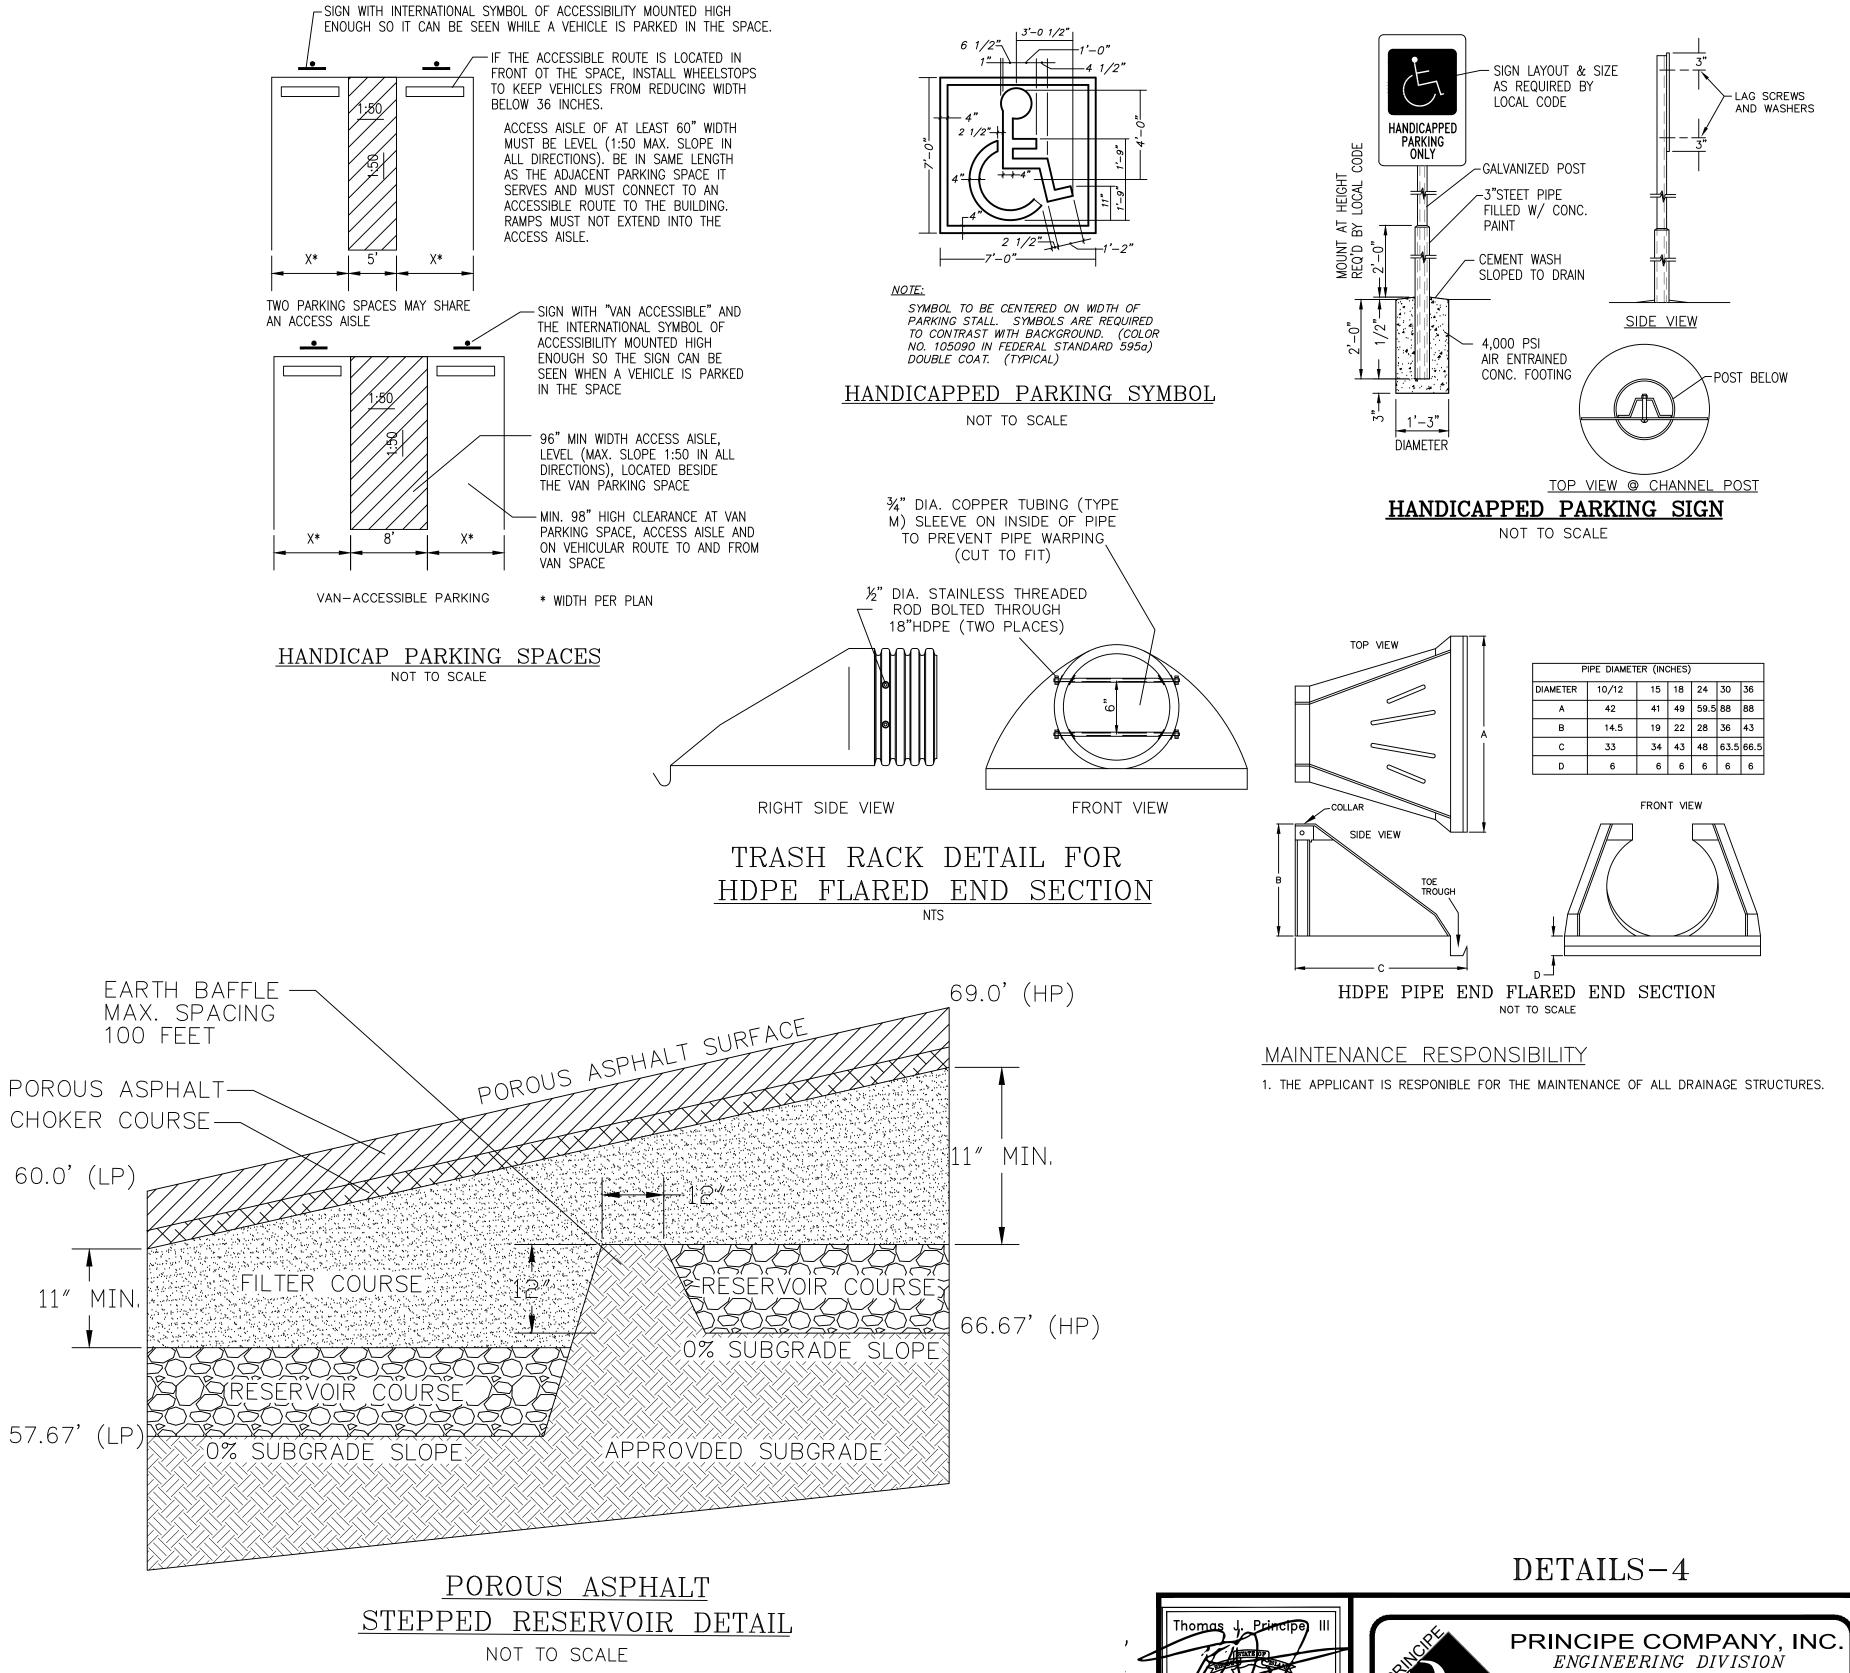

DRAWING ISSUE:

☐ CUSTOMER APPROVAL

ONLY PLANS ISSUED FOR CONTRUCTION

☐ CONCEPT

X PERMITTING

☐ AS-BUILT OTHER:

☐ CONSTRUCTION

2" HOT MIX ASPHALT SURFACE COURSE -2.5" HOT MIX ASPHALT BASE COURSE -8" GRAVEL SUB-BASE

F-42

1. The driveway within the ROW shall have an 8 inch gravel base that has been machine compacted and then paved with 4 inches of hot mix asphalt laid in two courses. Any existing hot mix asphalt berm or edging that exists within the proposed driveway must be sawcut and removed. The new pavement must tie into and not overlap the edge of the hardened surface of the roadway. 2. The driveway radii shall be tied into the State ROW.

HMA / DRIVEWAY APRON CROSS SECTION NOT TO SCALE

NATIVE SOIL

PO BOX 225

DATE DRWN CHKD

REGISTERED

PROFESSIONAL ENGINEER

REVISIONS "SHORELINE PLAZA" a MAJOR LAND DEVELOPMENT #3769 OLD POST ROAD AP 13, LOT 30

CHARLESTOWN, RHODE ISLAND


27 SAKONNET RIDGE DRIVE TIVERTON, RI 02878 401.816.5385

STABLISHED IN 1981 www.PrincipeEngineering.com

PRELIMINARY PLAN SUBMISSION


SCALE: 1"=40" SHEET NO: 11 OF 13 DESIGN BY: KAB | CHECKED BY: TJP DRAWN BY: KAB PROJECT NO.: 21051.00 DATE: 02/15/2024




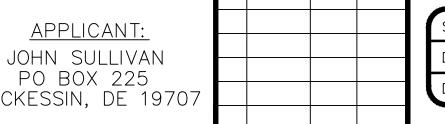






^{**} Preferably less than 4% fines

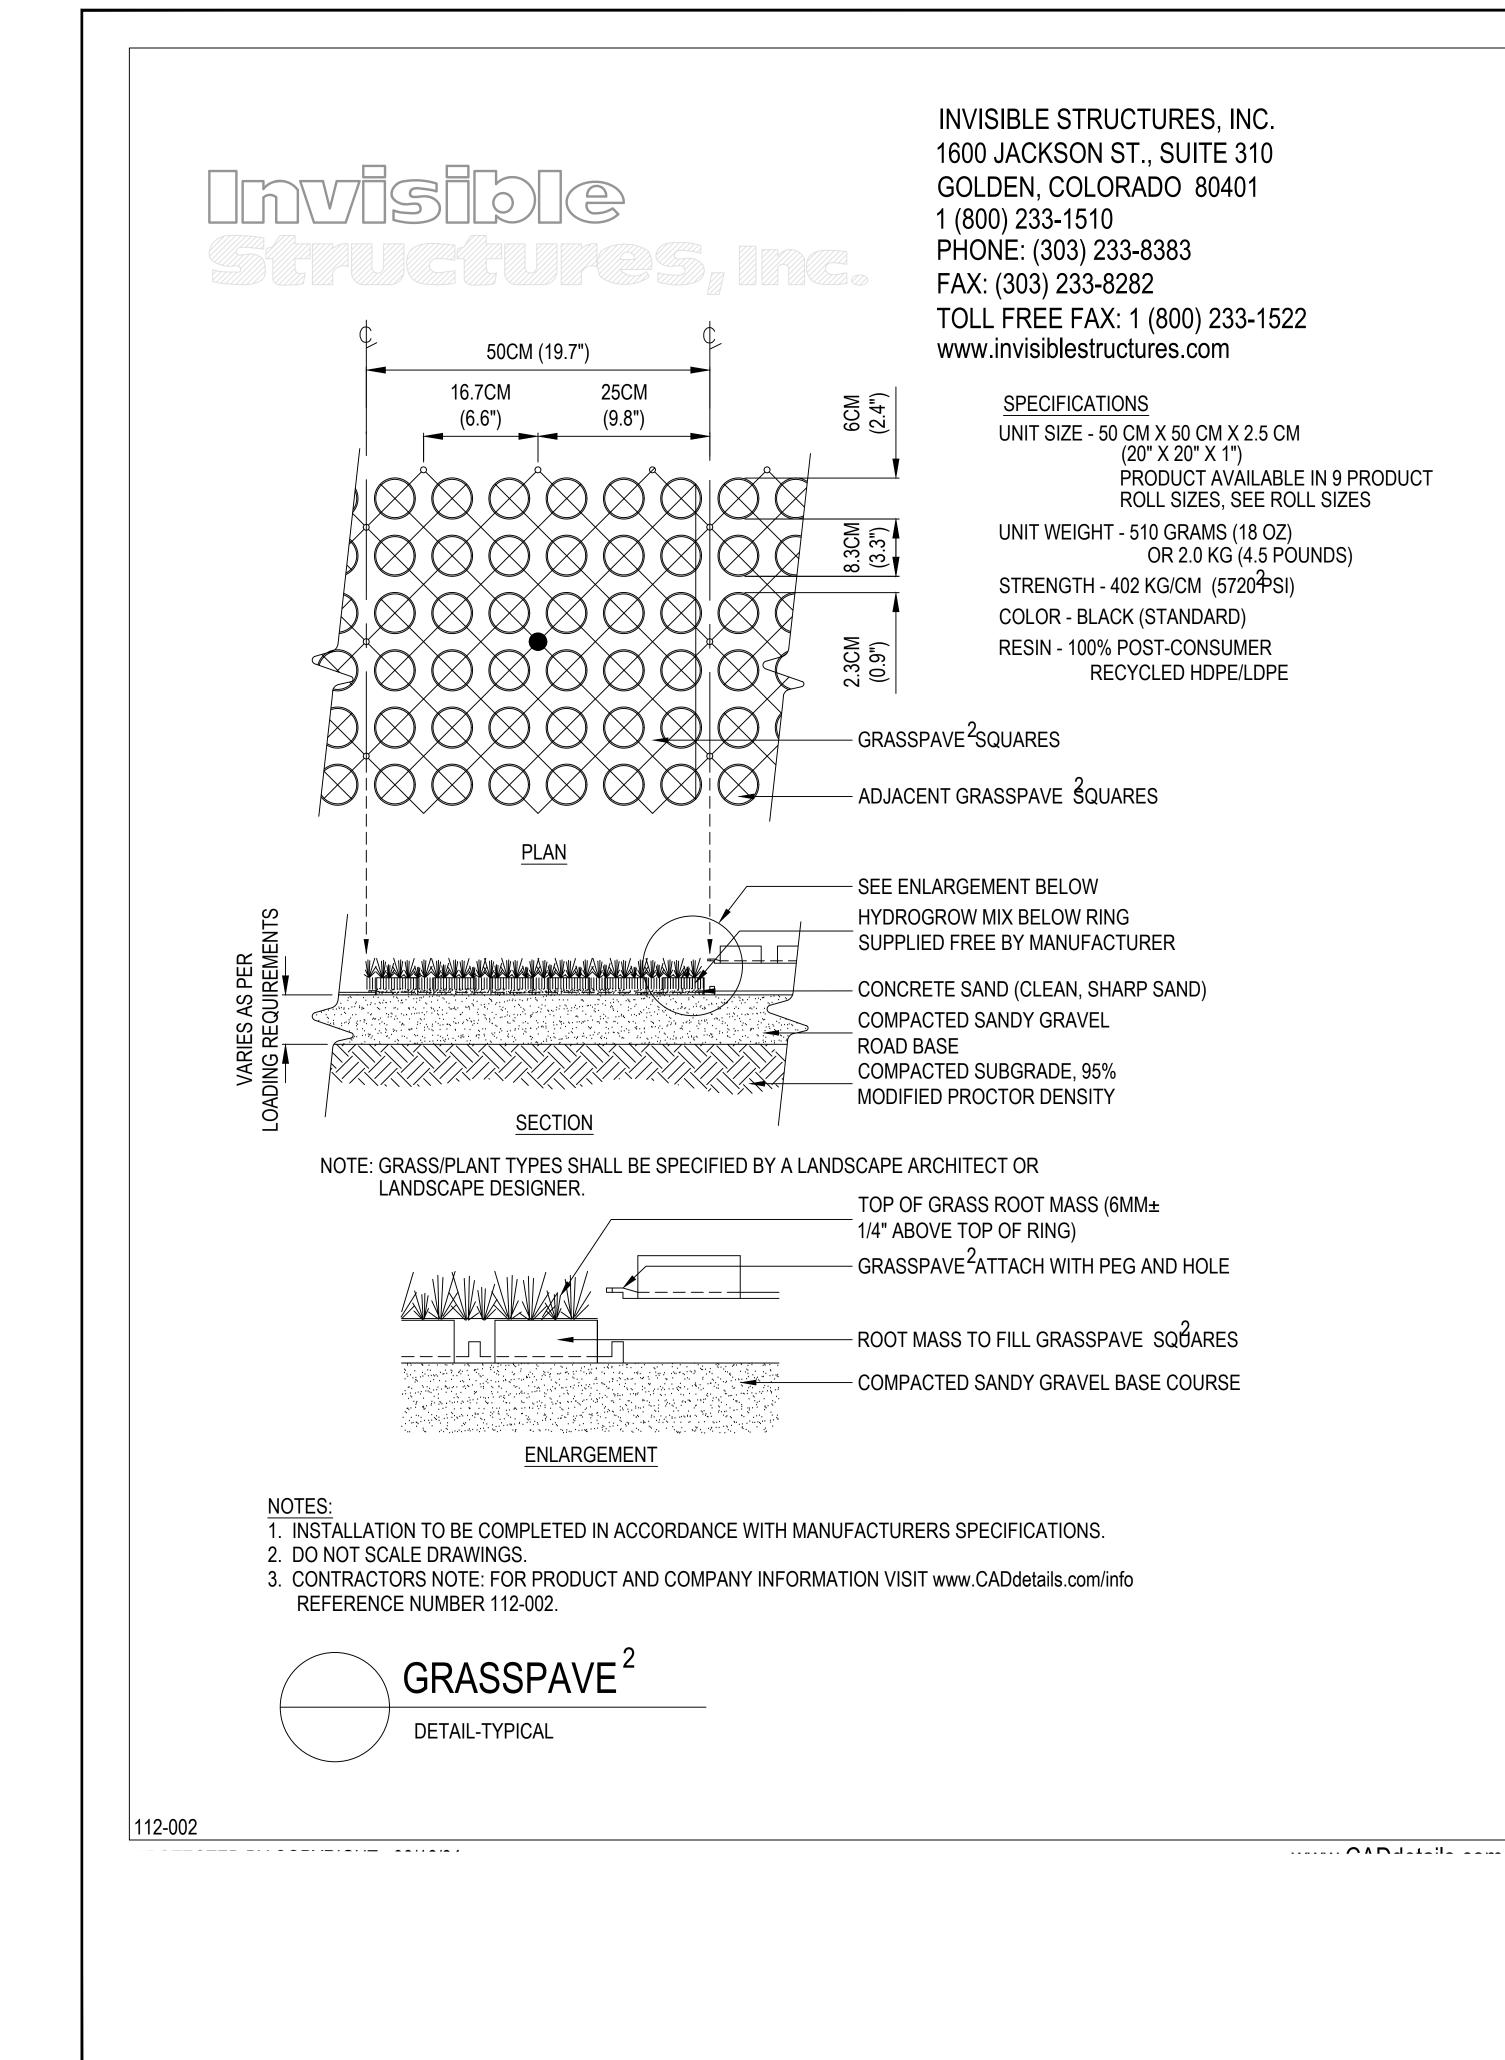

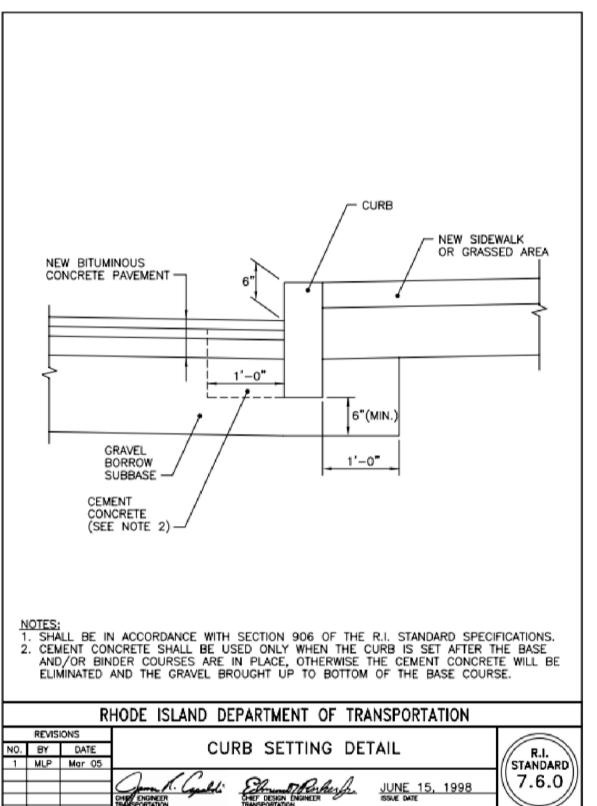

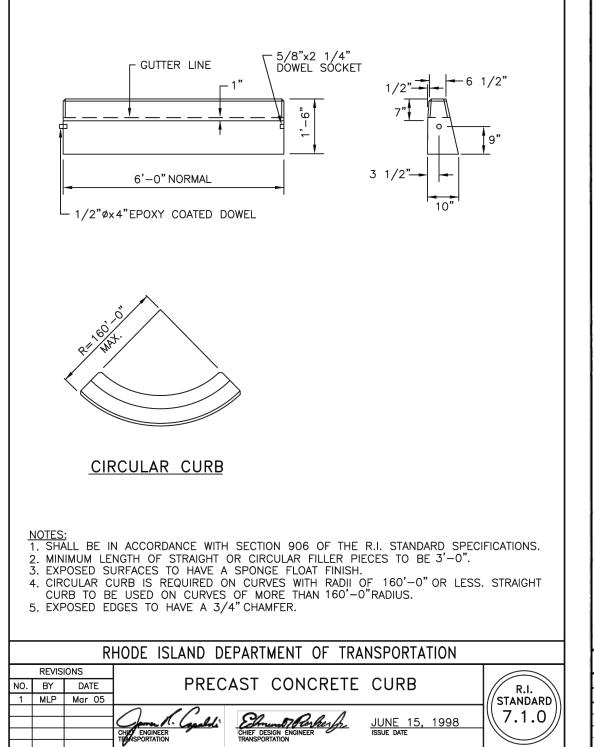

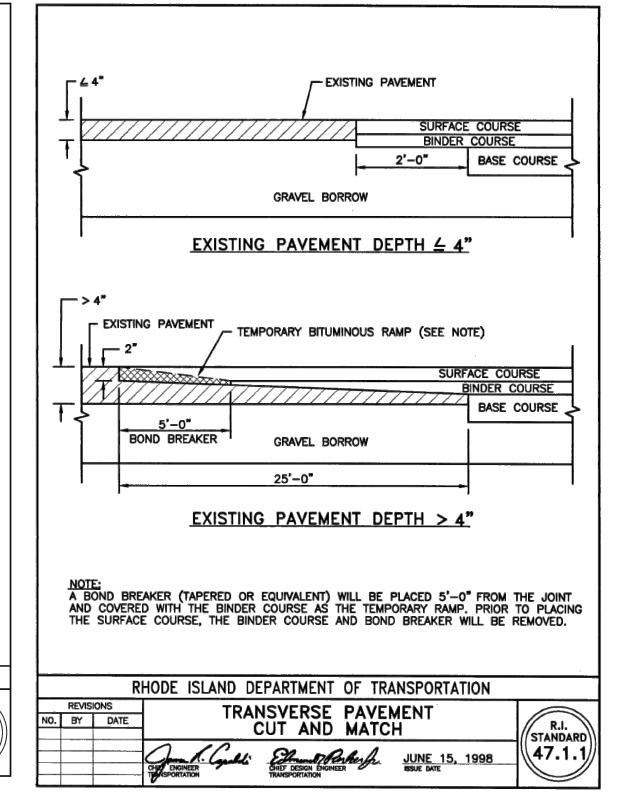

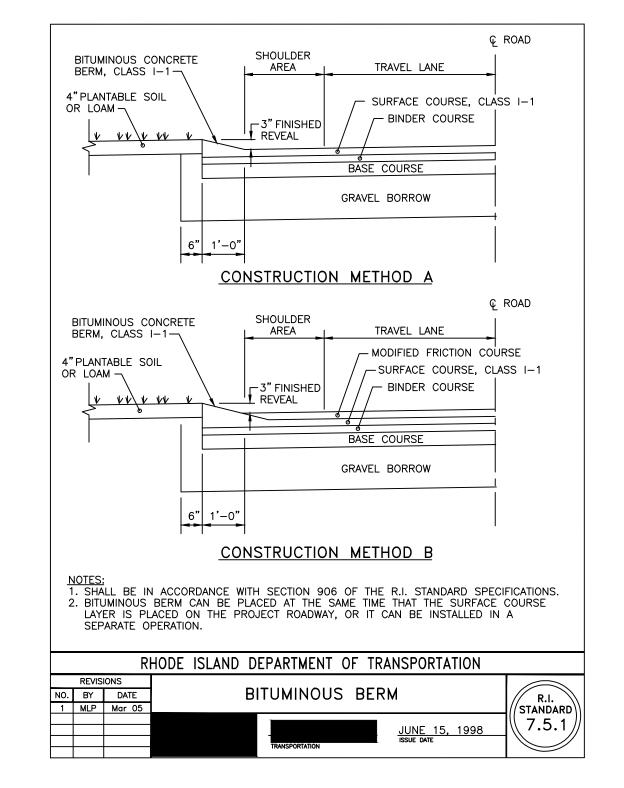



DRAWING ISSUE:


☐ CUSTOMER APPROVAL

☐ CONCEPT

X PERMITTING

☐ CONSTRUCTION



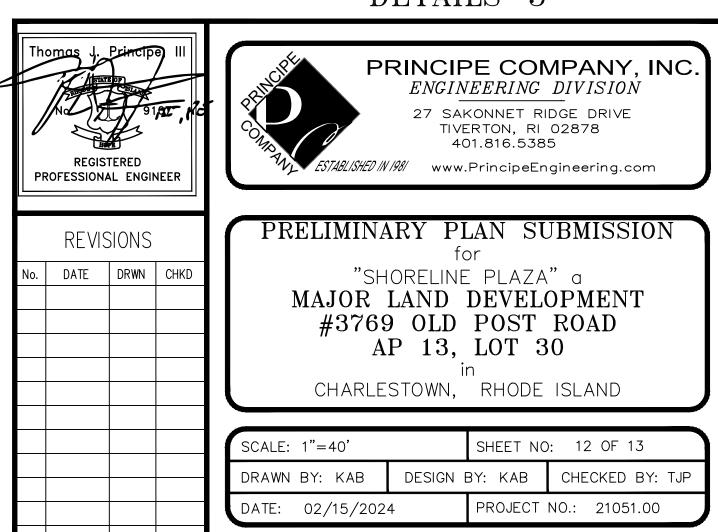

OWNER:
SOLARIA RI, LLC

COMMERCIAL PROPERTIES


PO BOX 225

HOCKESSIN, DE 19707 HOCKESSIN, DE 19707

RECEIVED

2/22/2024

COASTAL RESOURCES
MANAGEMENT COUNCIL

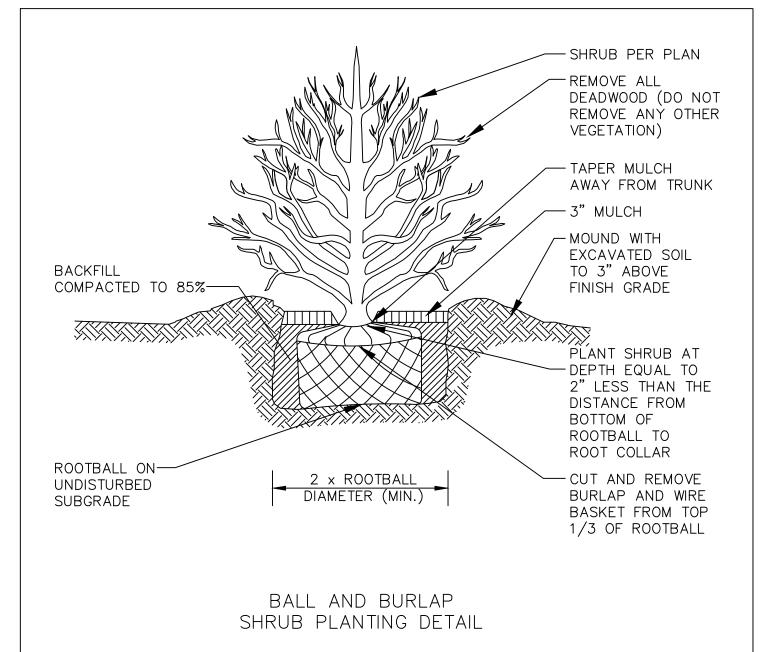

	SHRUB PLANTING DETAIL							
	MASTER PLANT SCHEDULE							
SYMBOL	QTY.	BOTANICAL NAME	COMMON NAME	SIZE	ROOT	REMARKS		
Ac	7	Amelanchier canadensis 'Autumn Brilliance'	Autumn brilliance shadbush	8-10' clump	В&В	SPECIMEN		
Ah	112	Amsonia hubrectii	Blue star flower	#1	CAN	3' o.c.		
At	44	Asclepias tuberosa	Butterfly weed	#1	CAN	3' o.c.		
Bn	13	Betula nigra 'Dura—Heat'	Dura—Heat river birch	8-10' clump	B&B	SPECIMEN		
EPW	59	Echinacea 'Pow Wow'	Pow Wow coneflower	#1	CAN	3' o.c.		
ELP	104	Eupatorium dubium 'Little—Pye'	Little Pye Joe-pye weed	#1	CAN	3' o.c.		
Ер	165	Eupatorium perfoliatum	Boneset	#1	CAN	3' o.c.		
IHG	60	ltea virgininica 'Henry's Garnet'	Henry's Garnet sweetspire	#3	CAN	3' o.c.		
Jv	26	Juniperus viriginiana	Red cedar	6-7'	B&B	8' o.c.		
LM	105	Lavandula 'Munstead'	Munstead lavender	#1	CAN	3' o.c.		
Lt	10	Liriodendron tulipifera	Tuliptree	2-2.5" cal.	B&B	5' STD.		
Ос	176	Osmunda cinnamomea	Cinnamon fern	#1	CAN	3' o.c.		
Pv	52	Panicum virgatum	Switch grass	#1	CAN	3' o.c.		
Rh	42	Rudbeckia hirta 'Sahara'	Sahara black-eyed Susan	#1	CAN	3' o.c.		
Sh	17	Sarcococca humilis 'Sarsid1'	Fragrant Valley sweet box	#3	CAN	3' o.c.		
SLL	62	Solidago 'Little Lemon'	Little Lemon goldenrod	#1	CAN	3' o.c.		
Sr	12	Syringa reticulata 'Ivory Silk'	Ivory Silk tree lilac	2-2.5" cal.	B&B	5' STD.		
Тс	77	Tiarella cordifolia	Foamflower	#1	CAN	3' o.c.		

Sterling silver linden

LANDSCAPE NOTES:

TS | 13 | Tilia tomentosa 'Silver'


- 1) ALL PLANT MATERIAL TO CONFORM TO AAN STANDARDS.
- 2) ALL PLANT MATERIAL TO RECEIVE THREE INCHES OF SHREDDED PINE BARK MULCH, 3) ALL PLANT MATERIAL TO BE GUARANTEED TO SURVIVE AT LEAST ONE GROWING SEASON,
- OR THEY SHALL BE REPLACED AT THE LANDSCAPE CONTRACTOR'S EXPENSE.
- 4) ALL PLANT MATERIAL SUBJECT TO VERIFICATION AS TO LOCATION AND SPECIES.
- 5) THERE WILL BE NO PLANT MATERIAL SUBSTITUTIONS WITHOUT THE WRITTEN CONSENT OF THE LANDSCAPE ARCHITECT.
- 6) DISTURBED SOILS WITHIN THE PROJECT LIMITS ARE TO BE LOAMED AND SEEDED.


Contractor's Lakeview Conservation Mix Item Number: ERNMX-116


45.0% Lolium perenne, 'Confetti III' (Perennial Ryegrass, 'Confetti III' (turf type)) 30.0% Lolium multiflorum (Annual Ryegrass) 12.0% Festuca rubra (Creeping Red Fescue) Poa pratensis, 'Shamrock' (Kentucky Bluegrass, 'Shamrock') Trifolium repens, Dutch (White Clover, Dutch)

-REMOVE ALL DEADWOOD (DO NOT REMOVE ANY OTHER VEGETATION) — 3" MULCH - MOUND WITH **BACKFILL** EXCAVATED SOIL COMPACTED TO 85%-TO 3" ABOVE FINISH GRADE PLANT SHRUB AT -DEPTH EQUAL TO GENTLY HAND 2" LESS THAN THE LOOSEN SOIL FROM DISTANCE FROM AROUND ROOTBALL BOTTOM OF WITHOUT SEVERING ROOTBALL TO MAIN ROOTS ROOT COLLAR 2 x ROOTBALL SPREAD ROOTS -DIAMETER (MIN.) OVER UNDISTURBED SUBGRADE CONTAINER GROWN SHRUB DETAIL


-SHRUB PER PLAN

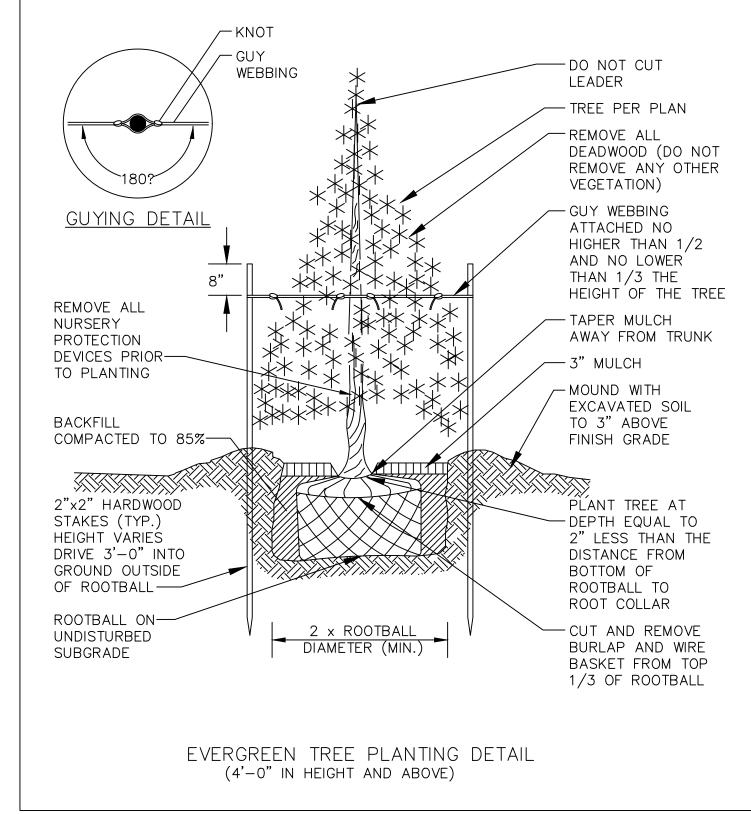

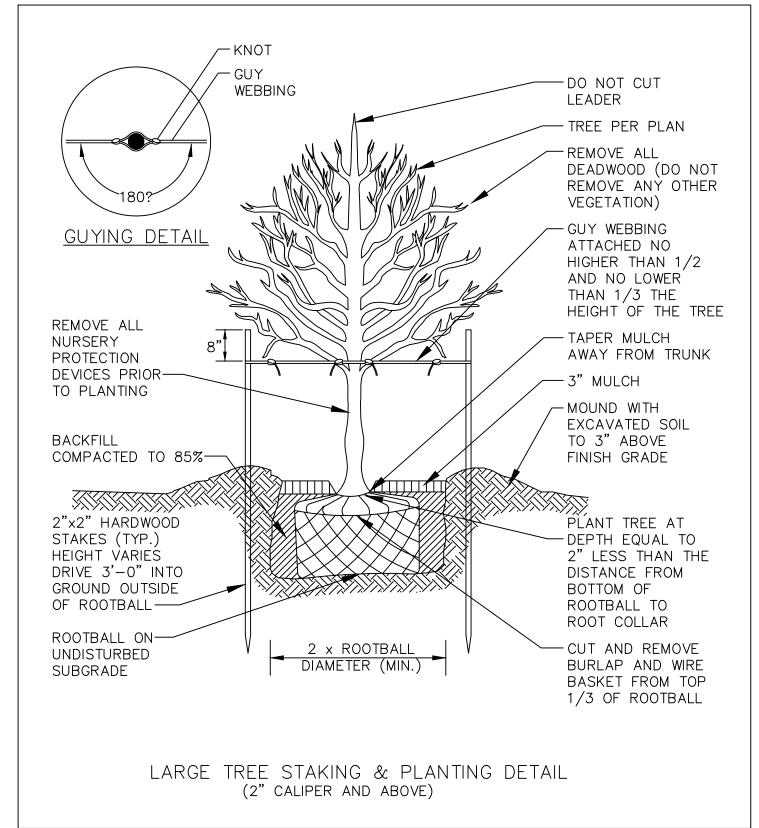

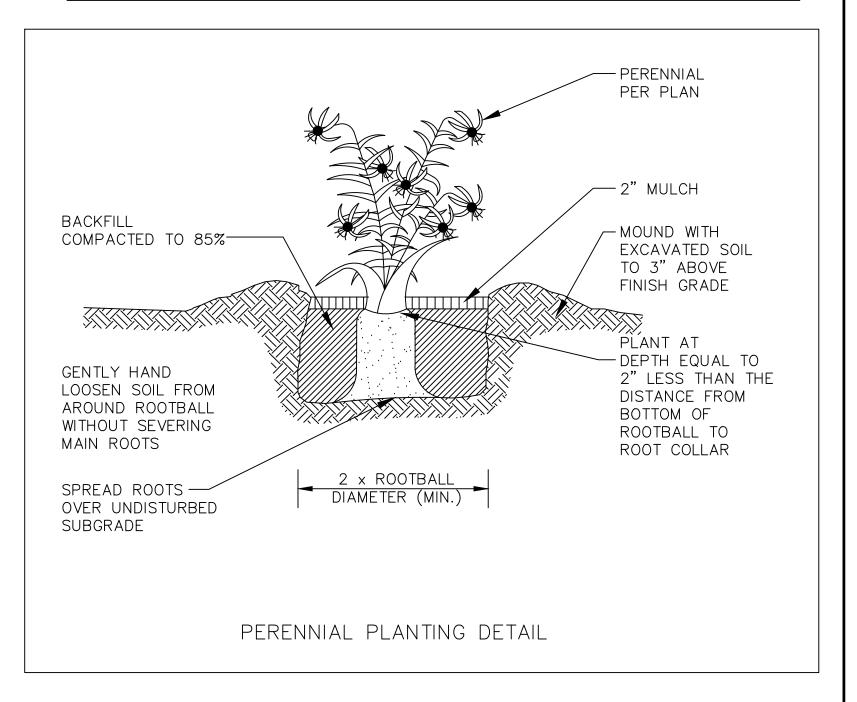



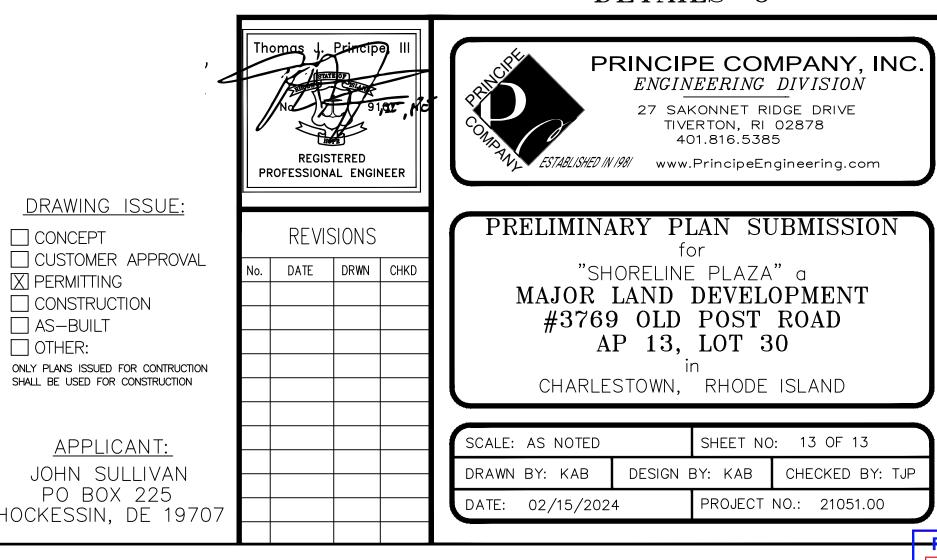

Seeding rate per acre in a mix: 75-150 lb per acre, or 3 lb per 1,000 sq ft

2/2.5" cal. | B&B | 5' STD.

SOLARIA RI, LLC COMMERCIAL PROPERTIES PO BOX 225 HOCKESSIN, DE 19707 HOCKESSIN, DE 19707

JOHN SULLIVAN PO BOX 225

☐ CONCEPT

X PERMITTING

☐ AS-BUILT

OTHER: