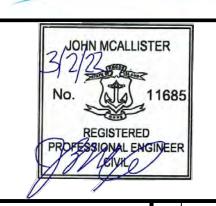
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## SOUTH QUAY PROPOSED SITE REDEVELOPMENT PROJECT

| 4             | 3/2/2022  | REVISIONS FOR ASSENT |                | JBM |
|---------------|-----------|----------------------|----------------|-----|
| 3             | 6/24/2021 | EDITS FOR ASSENT     |                | JBM |
| 2             | 3/11/2021 | USACE CHANNEL LIMITS |                | JBM |
| 1             | 11/2/2020 | UPDATED BATHY        |                | JBM |
| NO.           | DATE      | DESCRIPTION          |                | BY  |
| PROJECT NO.   |           |                      |                |     |
| CADD FILE     |           |                      |                |     |
| DESIGNED BY   |           |                      | JBM            |     |
| DRAWN BY      |           |                      |                |     |
| CHECKED BY    |           |                      | JAB            |     |
| DATE          |           |                      | SEPTEMBER 2020 |     |
| DRAWING SCALE |           |                      | N.T.S.         |     |
| GRAPHIC SCALE |           |                      |                |     |
|               |           |                      |                |     |

COVER SHEET

SHEET TITLE

DRAWING NO.

0

1 OF 33

SOUTH QUAY MARINE TERMINAL
PROPOSED REDEVELOPMENT
PROJECT

RECEIVED
MARCH 15, 2022
COASTAL RESOURCES
MANAGEMENT COUNCIL

PREPARED BY: LLOYD'S REGISTER ENERGY AMERICA'S, INC.



GZA GEOENVIRONMENTAL, INC.




PARE ENGINEERING, INC.



MCALLISTER MARINE ENGINEERING, LLC



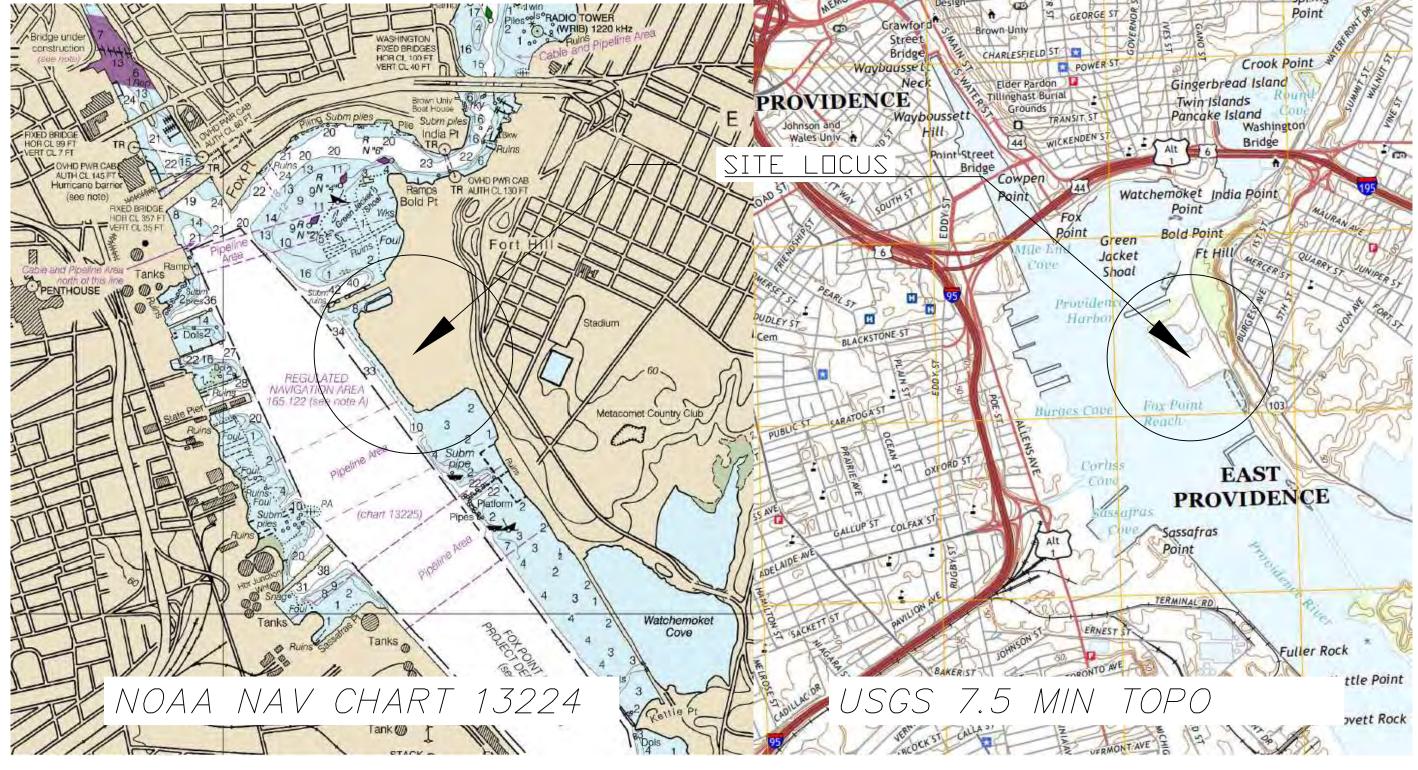

SITE LOCUS N.T.S.

PROJECT PROPONENT:

RI WATERFRONT ENTERPRISES, LLC

564 SOUTH WATER STREET

PROVIDENCE, RI 02903

COVER NOTES FACILITY USAGE PLAN EXISTING CONDITIONS EXISTING CONDITIONS EXISTING WATERSHED PLAN PROPOSED CONDITIONS EXISTING, PERMIT & PROPOSED CONDITIONS PROPOSED DREDGE PHASING PLAN STA 0+00 TO 6+00 DREDGE PLAN STA 10+48 DREDGE CROSS SECTIONS STA 6+00 TO 14+00 DREDGE PLAN PROPOSED PHASE 3 DREDGE PLAN PD-5PROPOSED CAD CELL 3AR FILL PLAN GRADING AND DRAINAGE PLAN INTERIM GRADING PLAN GD-2PROPOSED WATERSHED PLAN GRADING AND DRAINAGE PLAN GD-4GRADING AND DRAINAGE PLAN GRADING AND DRAINAGE PLAN UTILITY PLAN W— 1 WATERFRONT PLAN WATERTFRONT PLAN EROSION AND SEDIMENT CONTROL PLAN ESC-1ovett Rock ESC-2 EROSION AND SEDIMENT CONTROL PHASING ESC-3EROSION AND SEDIMENT CONTROL DETAILS XC-1CROSS-SECTIONS XC-2 CROSS-SECTIONS XC-3CROSS-SECTION WITH INTERIM GRADING DETAILS

D - 2

D-3

D-4

DETAILS

DETAILS

DETAILS

DRAFT — FOR PERMITTING REVIEW ONL' NOT FOR CONSTRUCTION

AND EXCESS MATERIAL IN ACCORDANCE WITH MASSACHUSETTS, LOCAL, AND FEDERAL LAWS.

21. CONTRACTOR SHALL ENSURE THAT ADEQUATE SHORING AND FALSEWORK ARE PROVIDED TO THE EXISTING STRUCTURE(S) RESULTING IN A STABLE AND SAFE STRUCTURE AT ALL

23. PRIDR TO COMMENCING WORK, THE CONTRACTOR SHALL VISIT THE SITE AND SHALL NOTIFY

THE ENGINEER OF ANY ADDITIONAL UTILITIES, STRUCTURES, OR ANY OTHER ELEMENTS

WHICH MAY IMPEDE WORK, UTILITY AND/OR STRUCTURE RELOCATIONS, IF NECESSARY,

20. THE CONTRACTOR SHALL PROTECT ALL ADJACENT STRUCTURES AND UTILITIES. THE CONTRACTOR SHALL BE RESPONSIBLE FOR REPAIR OF ALL DAMAGE TO ADJACENT

22. CONTRACTOR IS SOLELY RESPONSIBLE FOR MEANS, METHODS, AND SAFETY OF WORK.

24. ALL CONSTRUCTION ACTIVITIES SHALL BE CONFINED TO THE LIMITS OF WORK AND

25. THE CONTRACTOR WILL BE REQUIRED TO SUBMIT A CONSTRUCTION SCHEDULE TO THE OWNER WITH 5 DAYS OF THE NOTICE OF AWARD, THE CONTRACTOR SHALL UPDATE

26. THE CONTRACTOR SHALL STAGE ALL EQUIPMENT IN THE DESIGNATED STAGING AREA. ALL

STOCKPILED MATERIALS, AND OTHER MATERIALS ON THE SITE, FROM ENTERING THE

WATERWAY, STAGING/LAYDOWN AREAS, AS APPROVED BY THE ENGINEER, SHALL BE

RESTORED BY THE CONTRACTOR TO THE EXISTING CONDITION, IN ADDITION, THE

28. THE CONTRACTOR SHALL MAINTAIN A SECURE SIT AND PROVIDE APPROPRIATE SAFETY

29. IN CASE OF CONTRADICTION BETWEEN THE DRAWINGS, THE SPECIFICATIONS, AND THE

30. UPON COMPLETION OF THE PROJECT, CONTRACTOR IS TO PROVIDE TWO AS-BUILT PLAN

PREVENT TRACK OR FLOW OF MUD ONTO PUBLIC RIGHT-OF-WAY, THIS MAY REQUIRE

PERIODIC TOP DRESSING WITH 1-3"" OF STONE, AS CONDITIONS DEMAND. ALL MATERIALS

SPILLED, DROPPED, WASHED, OR TRACKED FROM VEHICLE ONTO PUBLIC ROADWAY OR INTO

31. THE CONSTRUCTION ENTRANCE SHALL BE MAINTAINED IN A CONDITION WHICH WILL

27. THE CONTRACTOR SHALL TAKE ALL NECESSARY PRECAUTIONS TO PREVENT ALL

INTO THE WATER SHALL BE REMOVED AND PROPERLY DISPOSED OF.

GREASING AND FUELING ACTIVITIES SHALL DCCUR IN THE STAGING AREA, ALL NECESSARY MEASURES SHALL BE TAKE TO PREVENT BY ANY METHOD, OIL, CONSTRUCTION DEBRIS,

CONTRACTOR SHALL REPLACE ALL DAMAGED MATERIALS AS A RESULT OF HIS OPERATIONS,

CONSTRUCTION DEBRIS OR WASTE FROM FALLING INTO THE WATER, ANY DEBRIS FALLING

MEASURES TO PREVENT ACCIDENTS. THE SAFETY MEASURES SHALL INCLUDE, BUT NOT BE LIMITED TO SIGNAGE, BARRICADES, FENCES, FLASHING WARNING LIGHTS, AND POLICING IF

CODES, OR IF ANY CHANGE IS REQUIRED, THE CONTRACTOR SHALL INFORM THE ENGINEER IMMEDIATELY, NO CHANGE SHALL BE MADE WITHOUT WRITTEN APPROVAL OF THE ENGINEER.

SETS TO THE OWNER DEPICTING ANY FIELD CHANGES OF DIMENSION OR DETAIL, LOCATION OF UNDERGROUND STRUCTURES AND/OR UTILITIES, CONSTRUCTION DEVIATIONS, CHANGES TO DUE TO FIELD OR CHANGE ORDER, AND DETAILS NOT ON THE ORIGINAL DRAWINGS.

STRUCTURES AND UTILITIES AT NO ADDITIONAL COST TO THE OWNER.

SHALL BE COORDINATED THROUGH THE OWNER'S ENGINEER.

SCHEDULE AS NEEDED THROUGHOUT THE COURSE OF WORK.

TEMPORARY EASEMENTS DEFINED HEREIN.

TO THE SATISFACTION OF THE ENGINEER.

STORM DRAIN MUST BE REMOVED IMMEDIATELY.

GRAPHIC DEPICTION OF TIDAL DATUM FOR

----MLLW 0

GRAPHIC DEPICTION OF TIDAL DATUM FOR PROVIDENCE RIVER IN MLLW FEET PROVIDENCE RIVER IN NAVD88 FEET BASED ON NOAA STATION 8454000 BASED ON NOAA STATION 8454000 - MHHW +4.84 ——— MHHW +2.37 - MHW +4.59 -MHW +2.12— NA∨D88 ±2,47 — NA∨D88 ±0 \_\_\_\_\_MSL +2.25 —MSL −0.22 -MLW + 0.18

MEAN TIDAL RANGE IS 4.42 FT, WITH THE DIURNAL RANGE OF 4.48 FT.

-MLW -2.29

---MLLW -2.47

\_\_\_\_\_ ETC \_\_\_\_ ETC \_\_\_\_ ETC \_\_\_\_ \_\_\_\_\_ ETC \_\_\_\_ ETC \_\_\_\_ ETC \_\_\_\_

RECEIVED <u>LEGEND</u> EXISTING PROPERTY EXISTING GRADING MARCH 15, 2022 EXISTING SPOT GRAD EXISTING WETLAND I EXISTING WETLAND 50 ECOASTAL RESOURCES MANAGEMENT COUNCIL — Е — Е — EXISTING ELECTRICAL EXISTING TELECOMM EXISTING DRIVEWAY PROPOSED CHAIN LINK FENCE PROPOSED GRADING PROPOSED SPOT GRADE PROPOSED SILT FENCE AND STRAW WATTLE PROPOSED DRAIN LINE PROPOSED CLEAN OUT PROPOSED LIGHTING ARRAY AND BOLLARDS PROPOSED WATER LINE PROPOSED FIRE HYDRANT PROPOSED GATE VALVE PROP. ELECTRICAL / SITE LIGHT DUCTBANK PROPOSED TELECOMM PROPOSED INFILTRATION TRENCH INFILTRATION TRENCH FLOW DIRECTION PROPOSED ASPHALT DRIVE PIPE SLOPE PROPOSED OVERFLOW GRATE PROPOSED DREDGE AREA PROPOSED JACK-UP BERTH

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PROPERTY LINE

MEAN LOWER LOW WATER (MLLW)

MEAN HIGH WATER (MHW)

JOHN MCALLISTER REGISTERED PROFESSIONAL ENGINEER / LETYICO/ SOUTH SOPOSI LOPMI S PR VEI 3/2/2022 REVISIONS FOR ASSENT JBM 6/24/2021 EDITS FOR ASSENT 3/11/2021 USACE CHANNEL LIMITS JBN UPDATED BATHY 11/2/2020 DATE DESCRIPTION PROJECT NO CADD FILE **DESIGNED BY** DRAWN BY CHECKED BY DATE SEPTEMBER 2020 DRAWING SCALE N/A **GRAPHIC SCALE** SHEET TITLE **GENERAL NOTES** AND **PROJECT DESCRIPTION** DRAWING NO. N-1 2 OF 33


Known for excelled Built on trust.


MARINI


engineering


(nown for excellence.


CORPORATIO

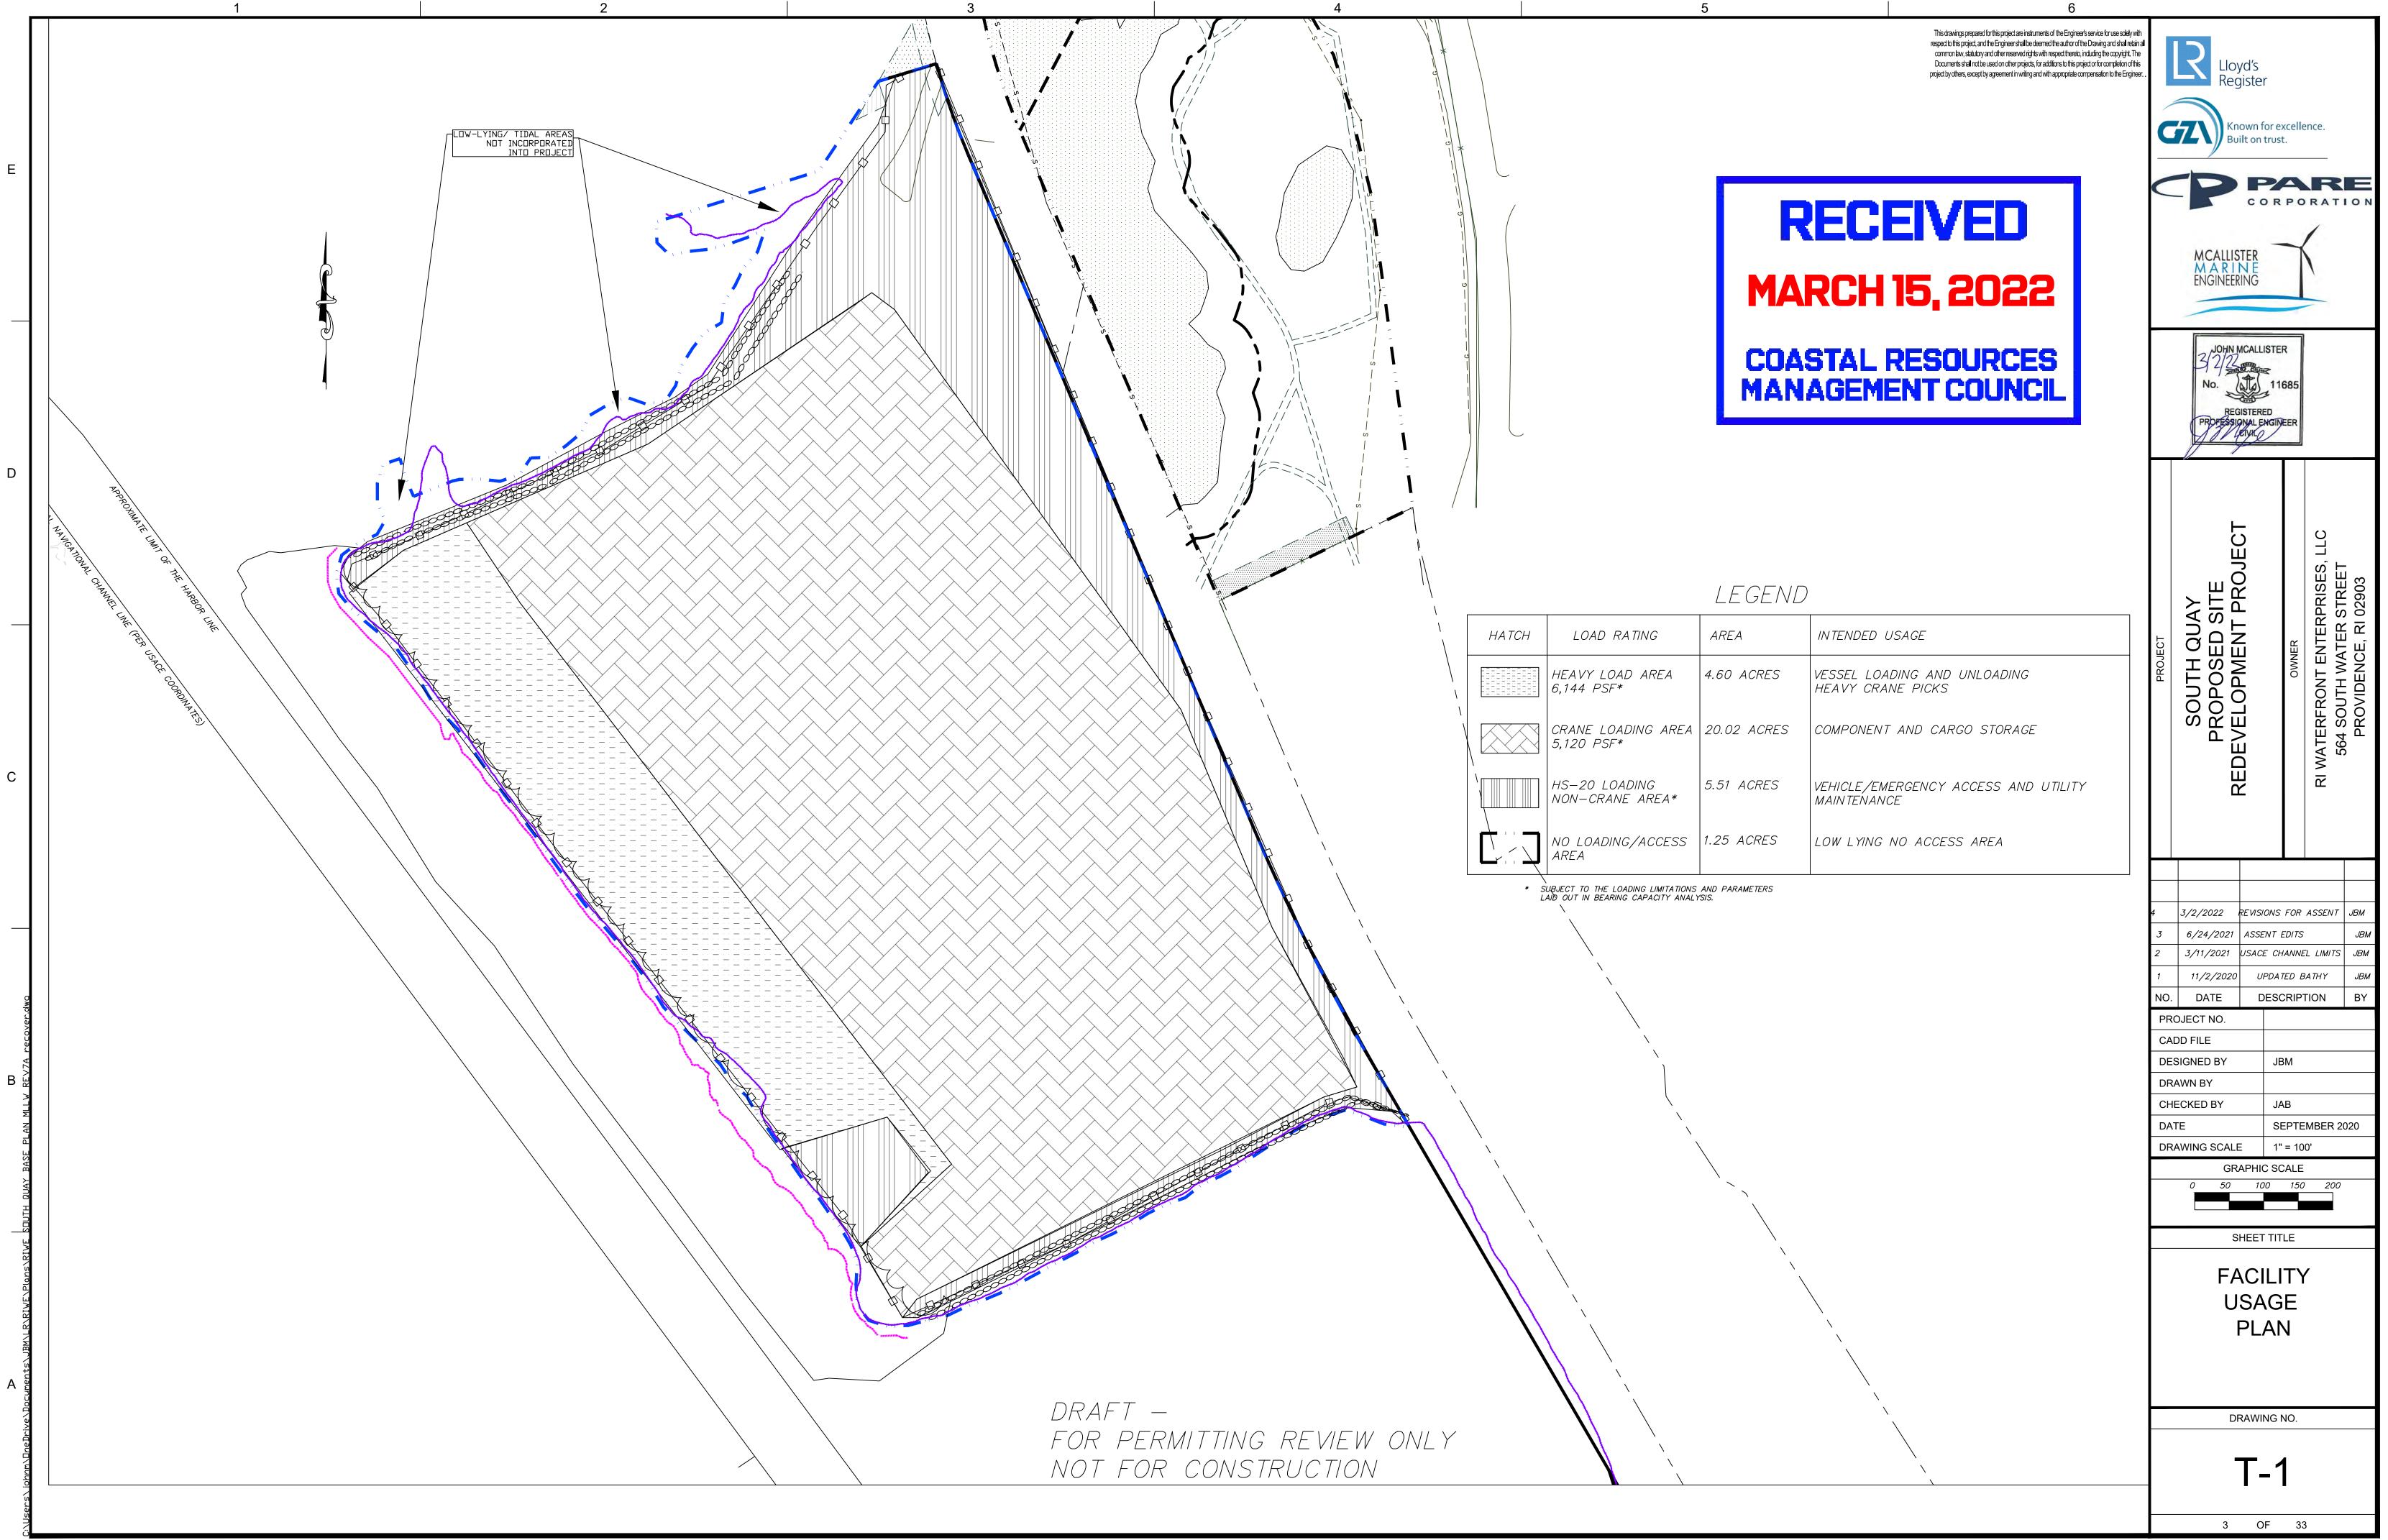


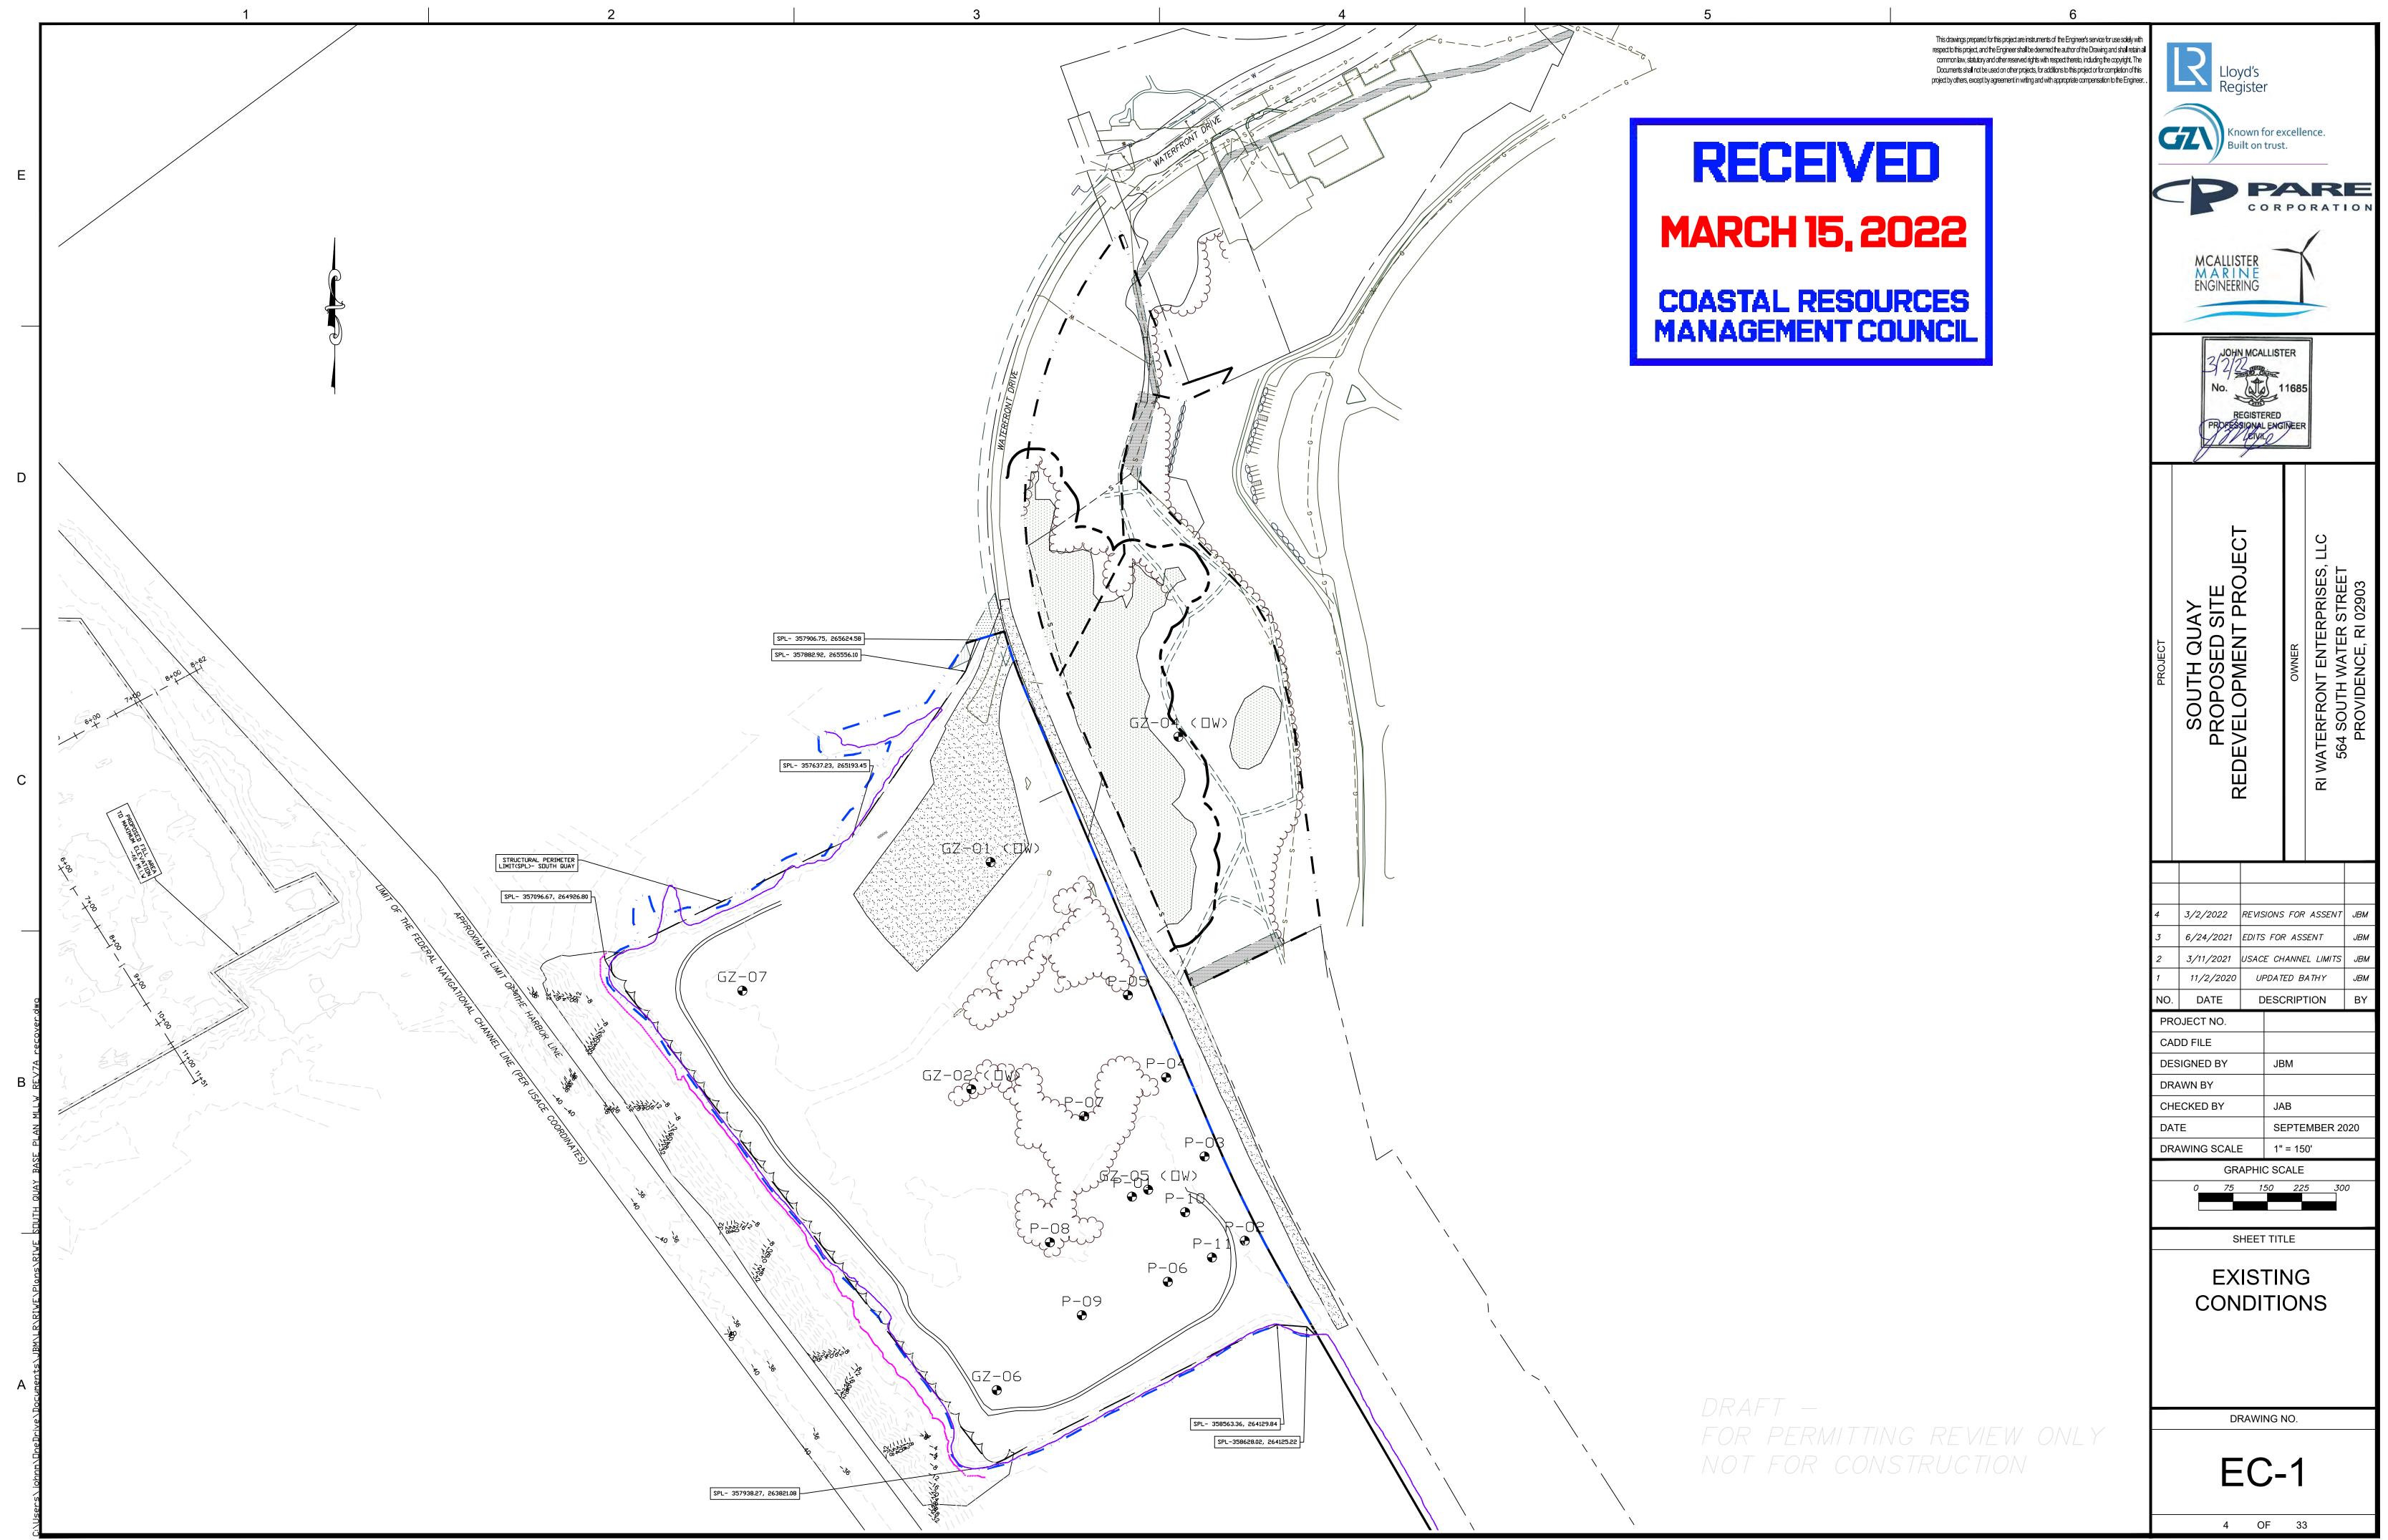


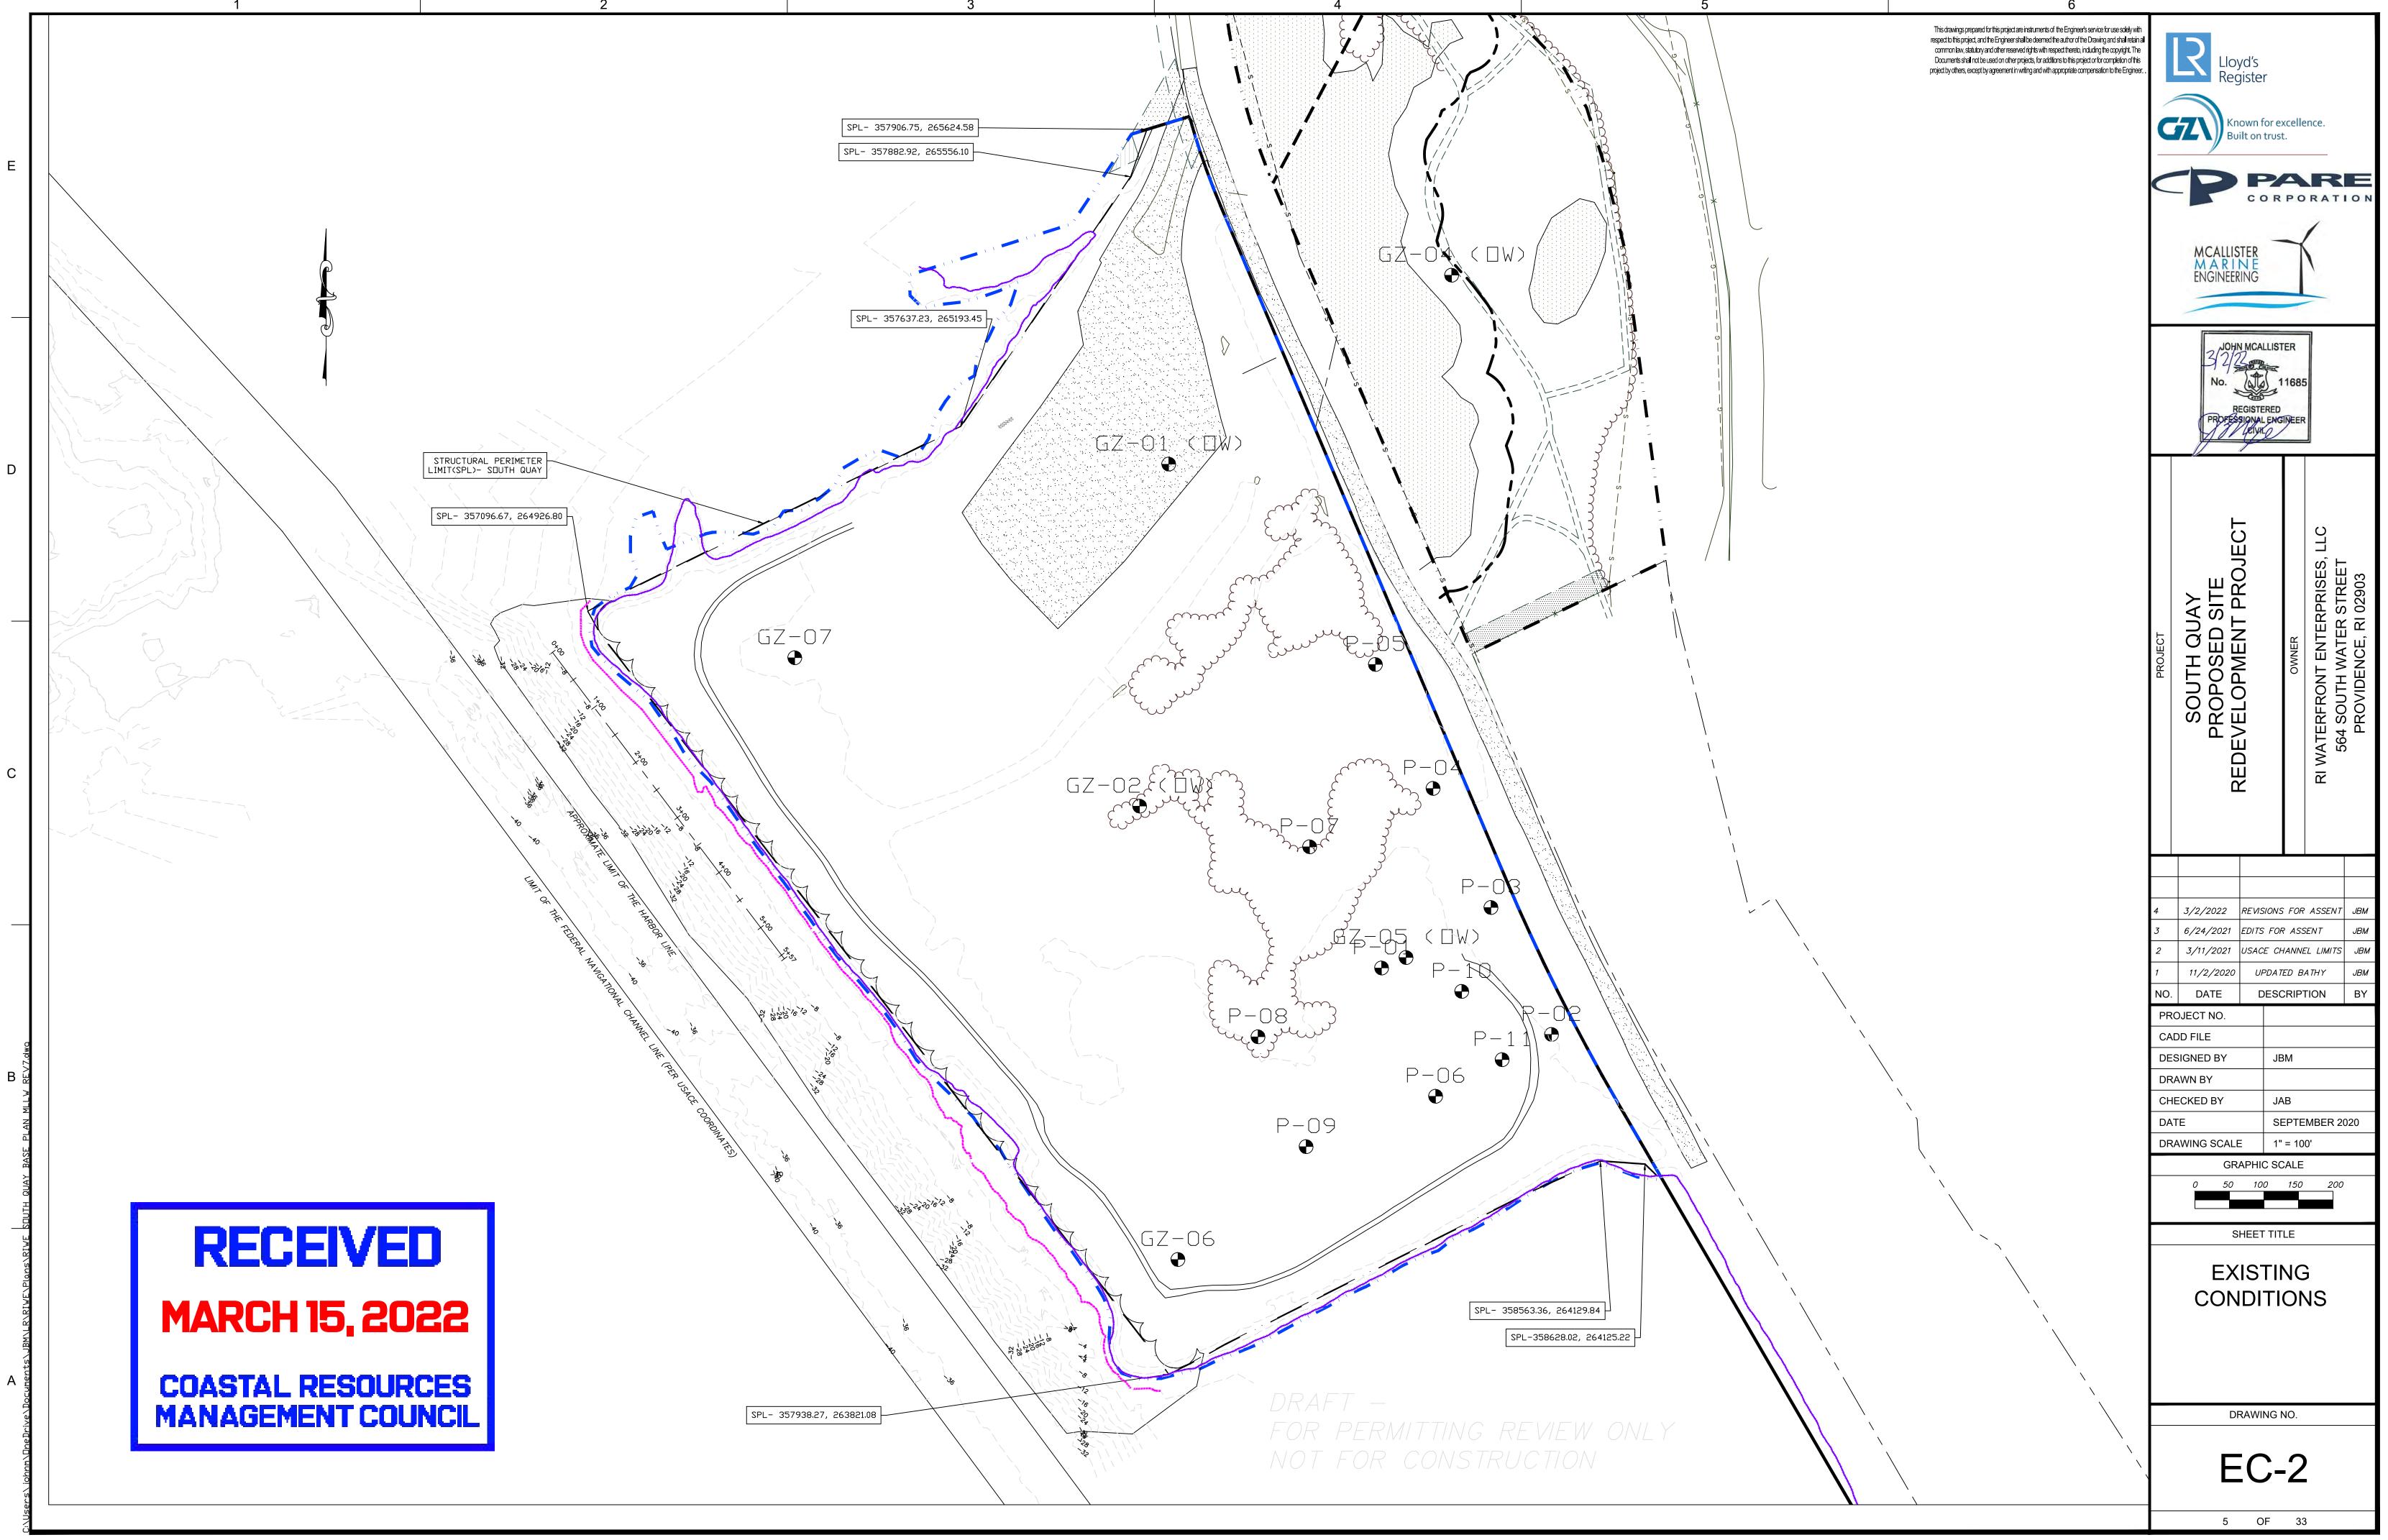


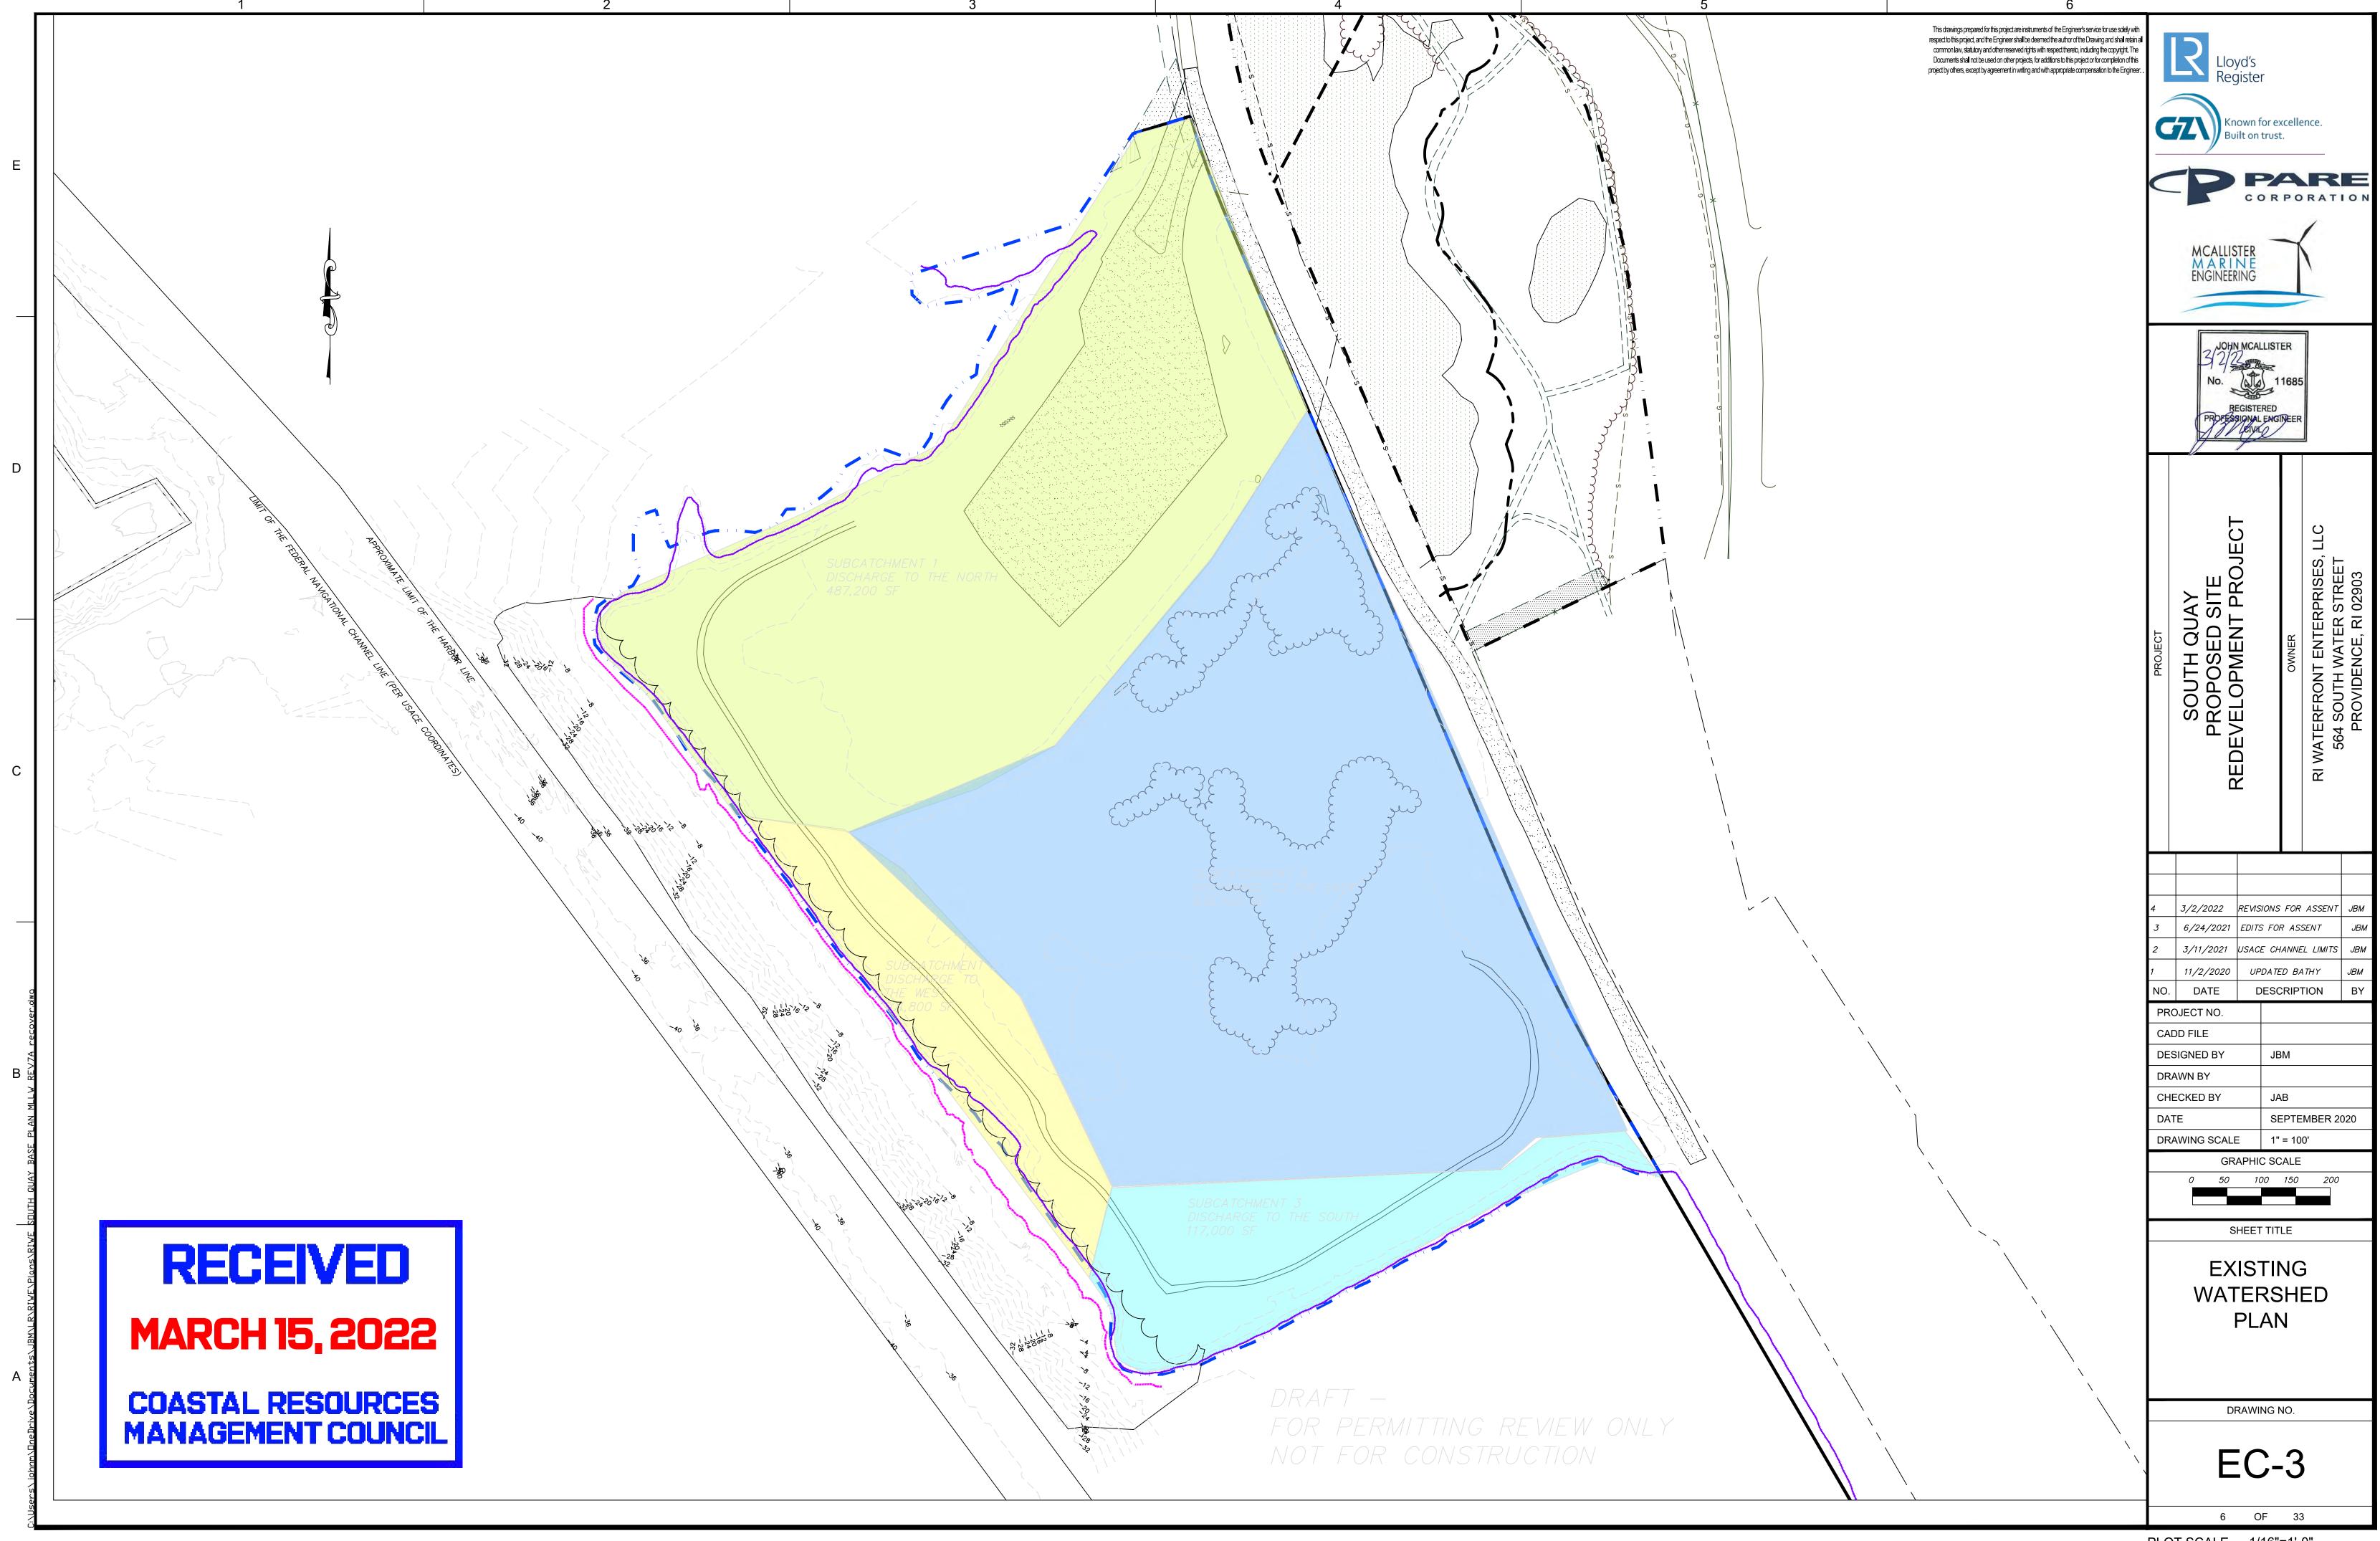


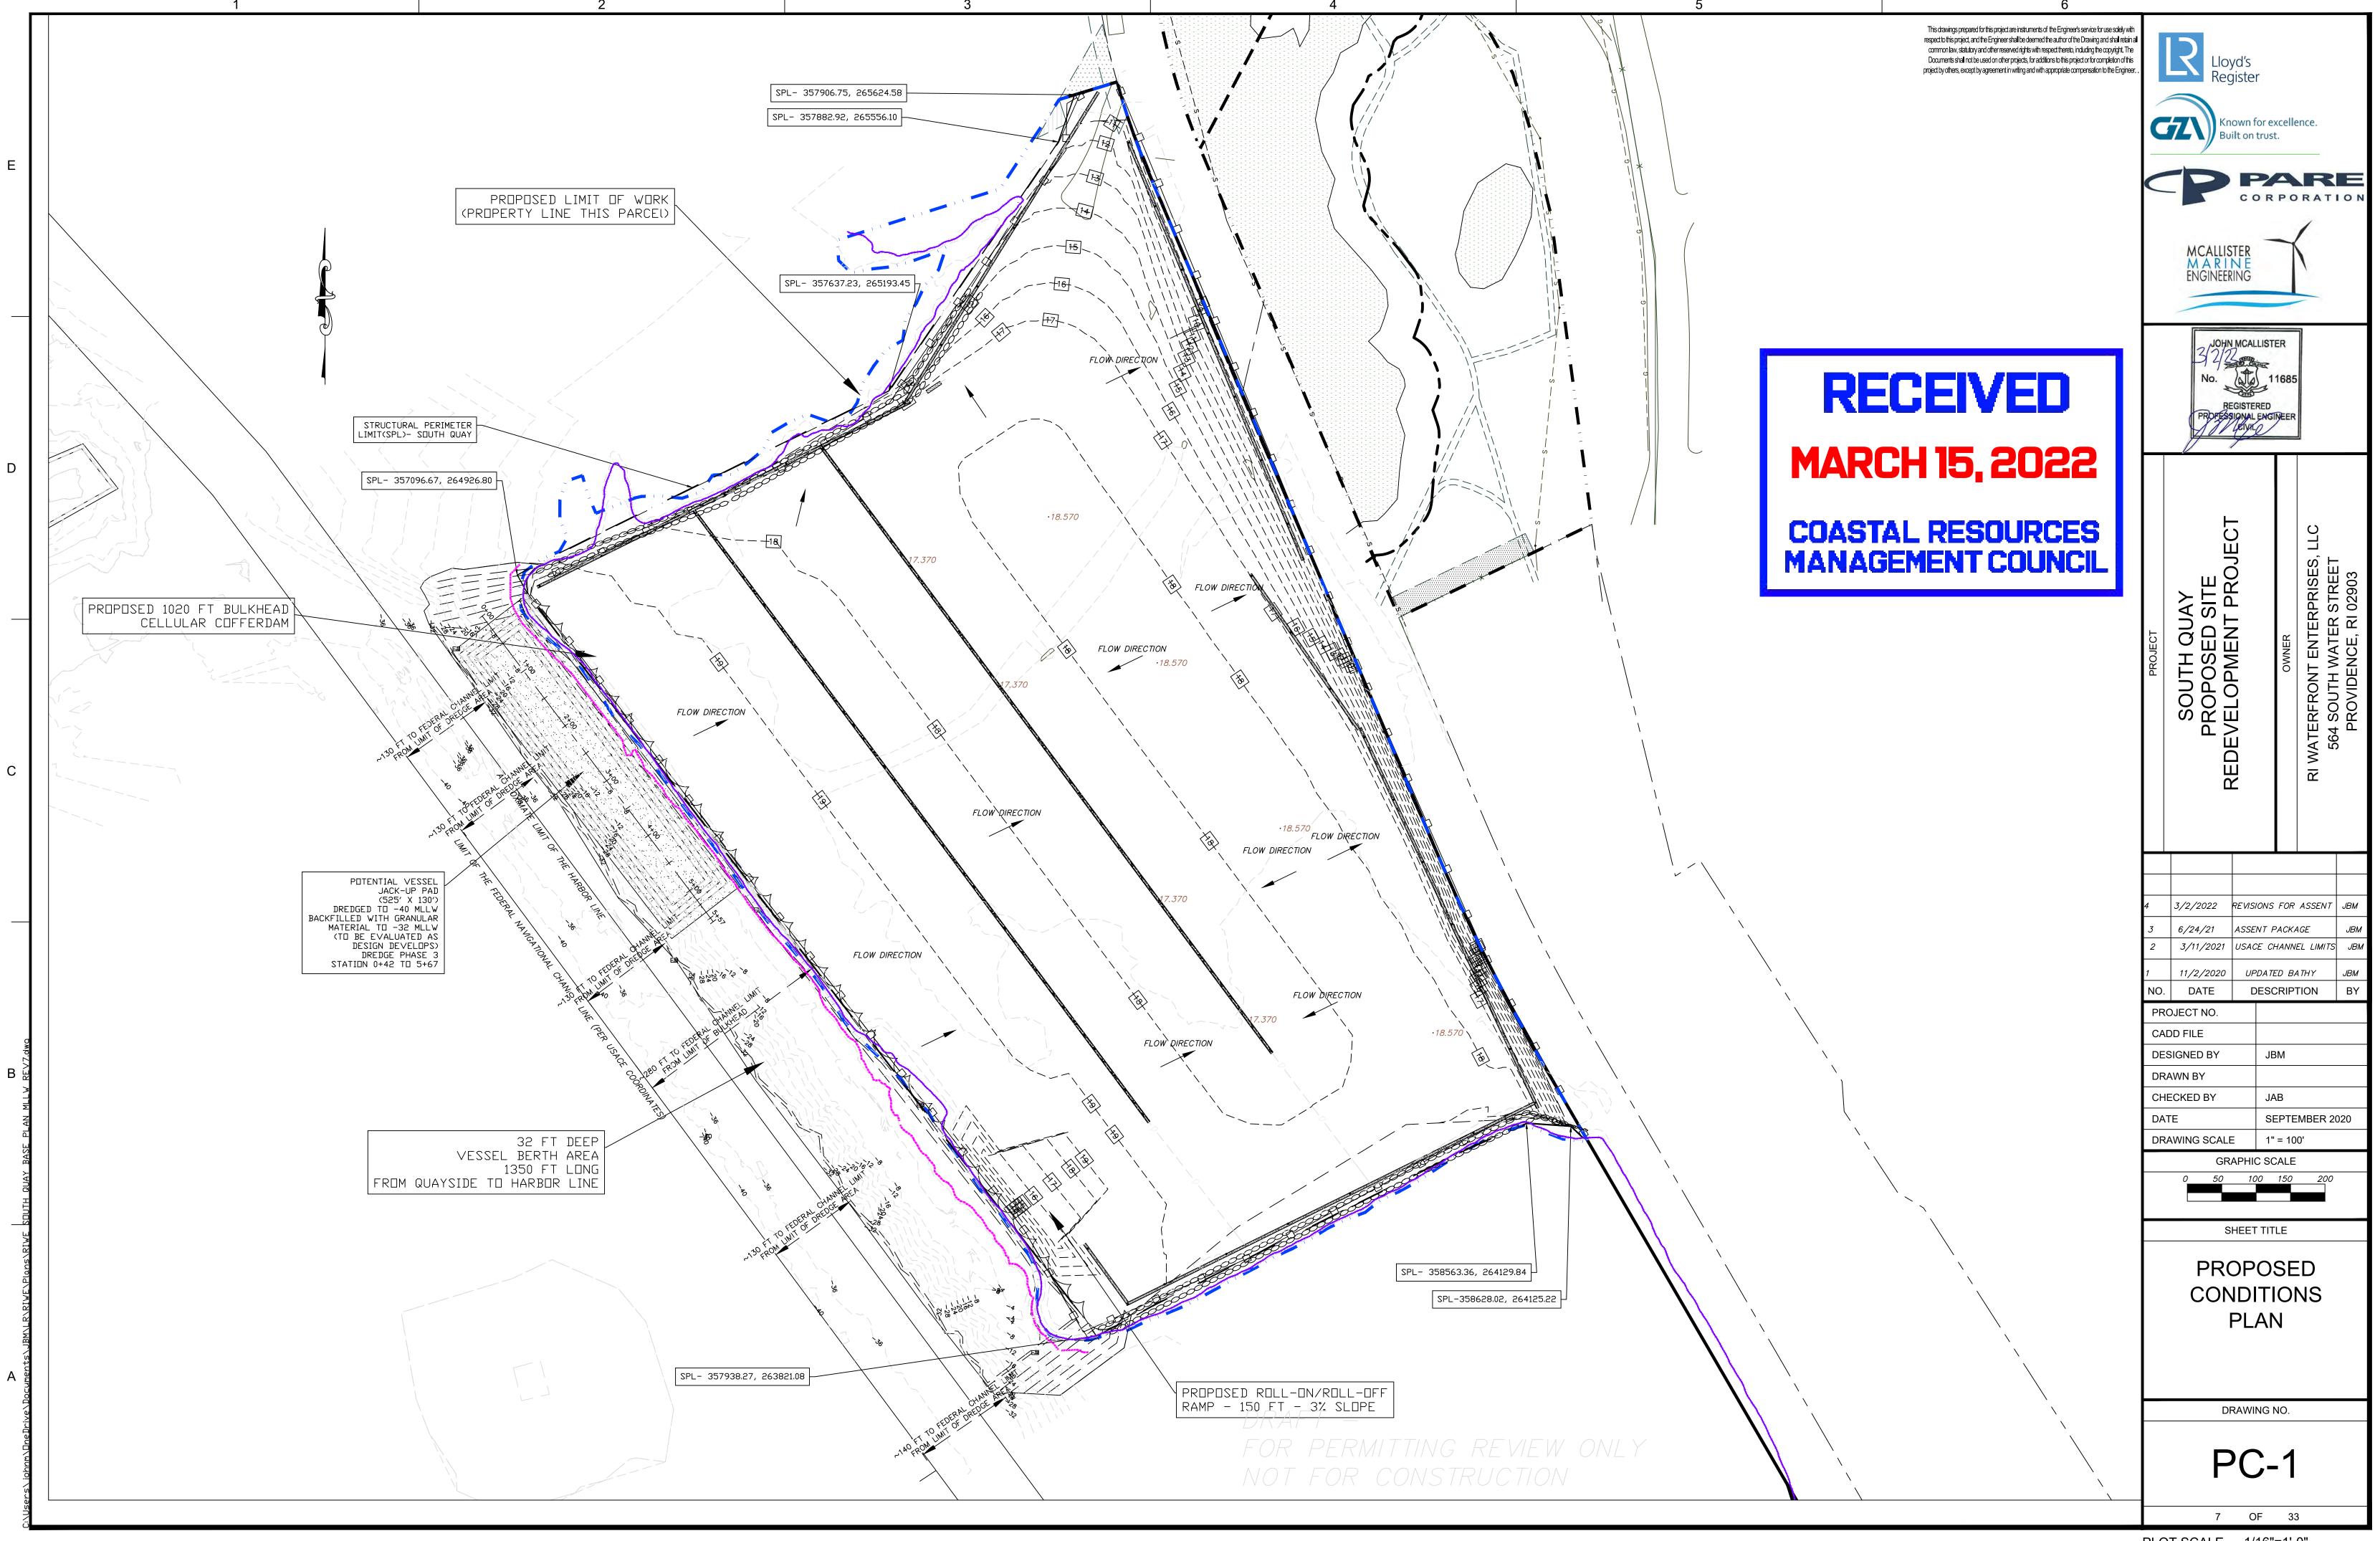


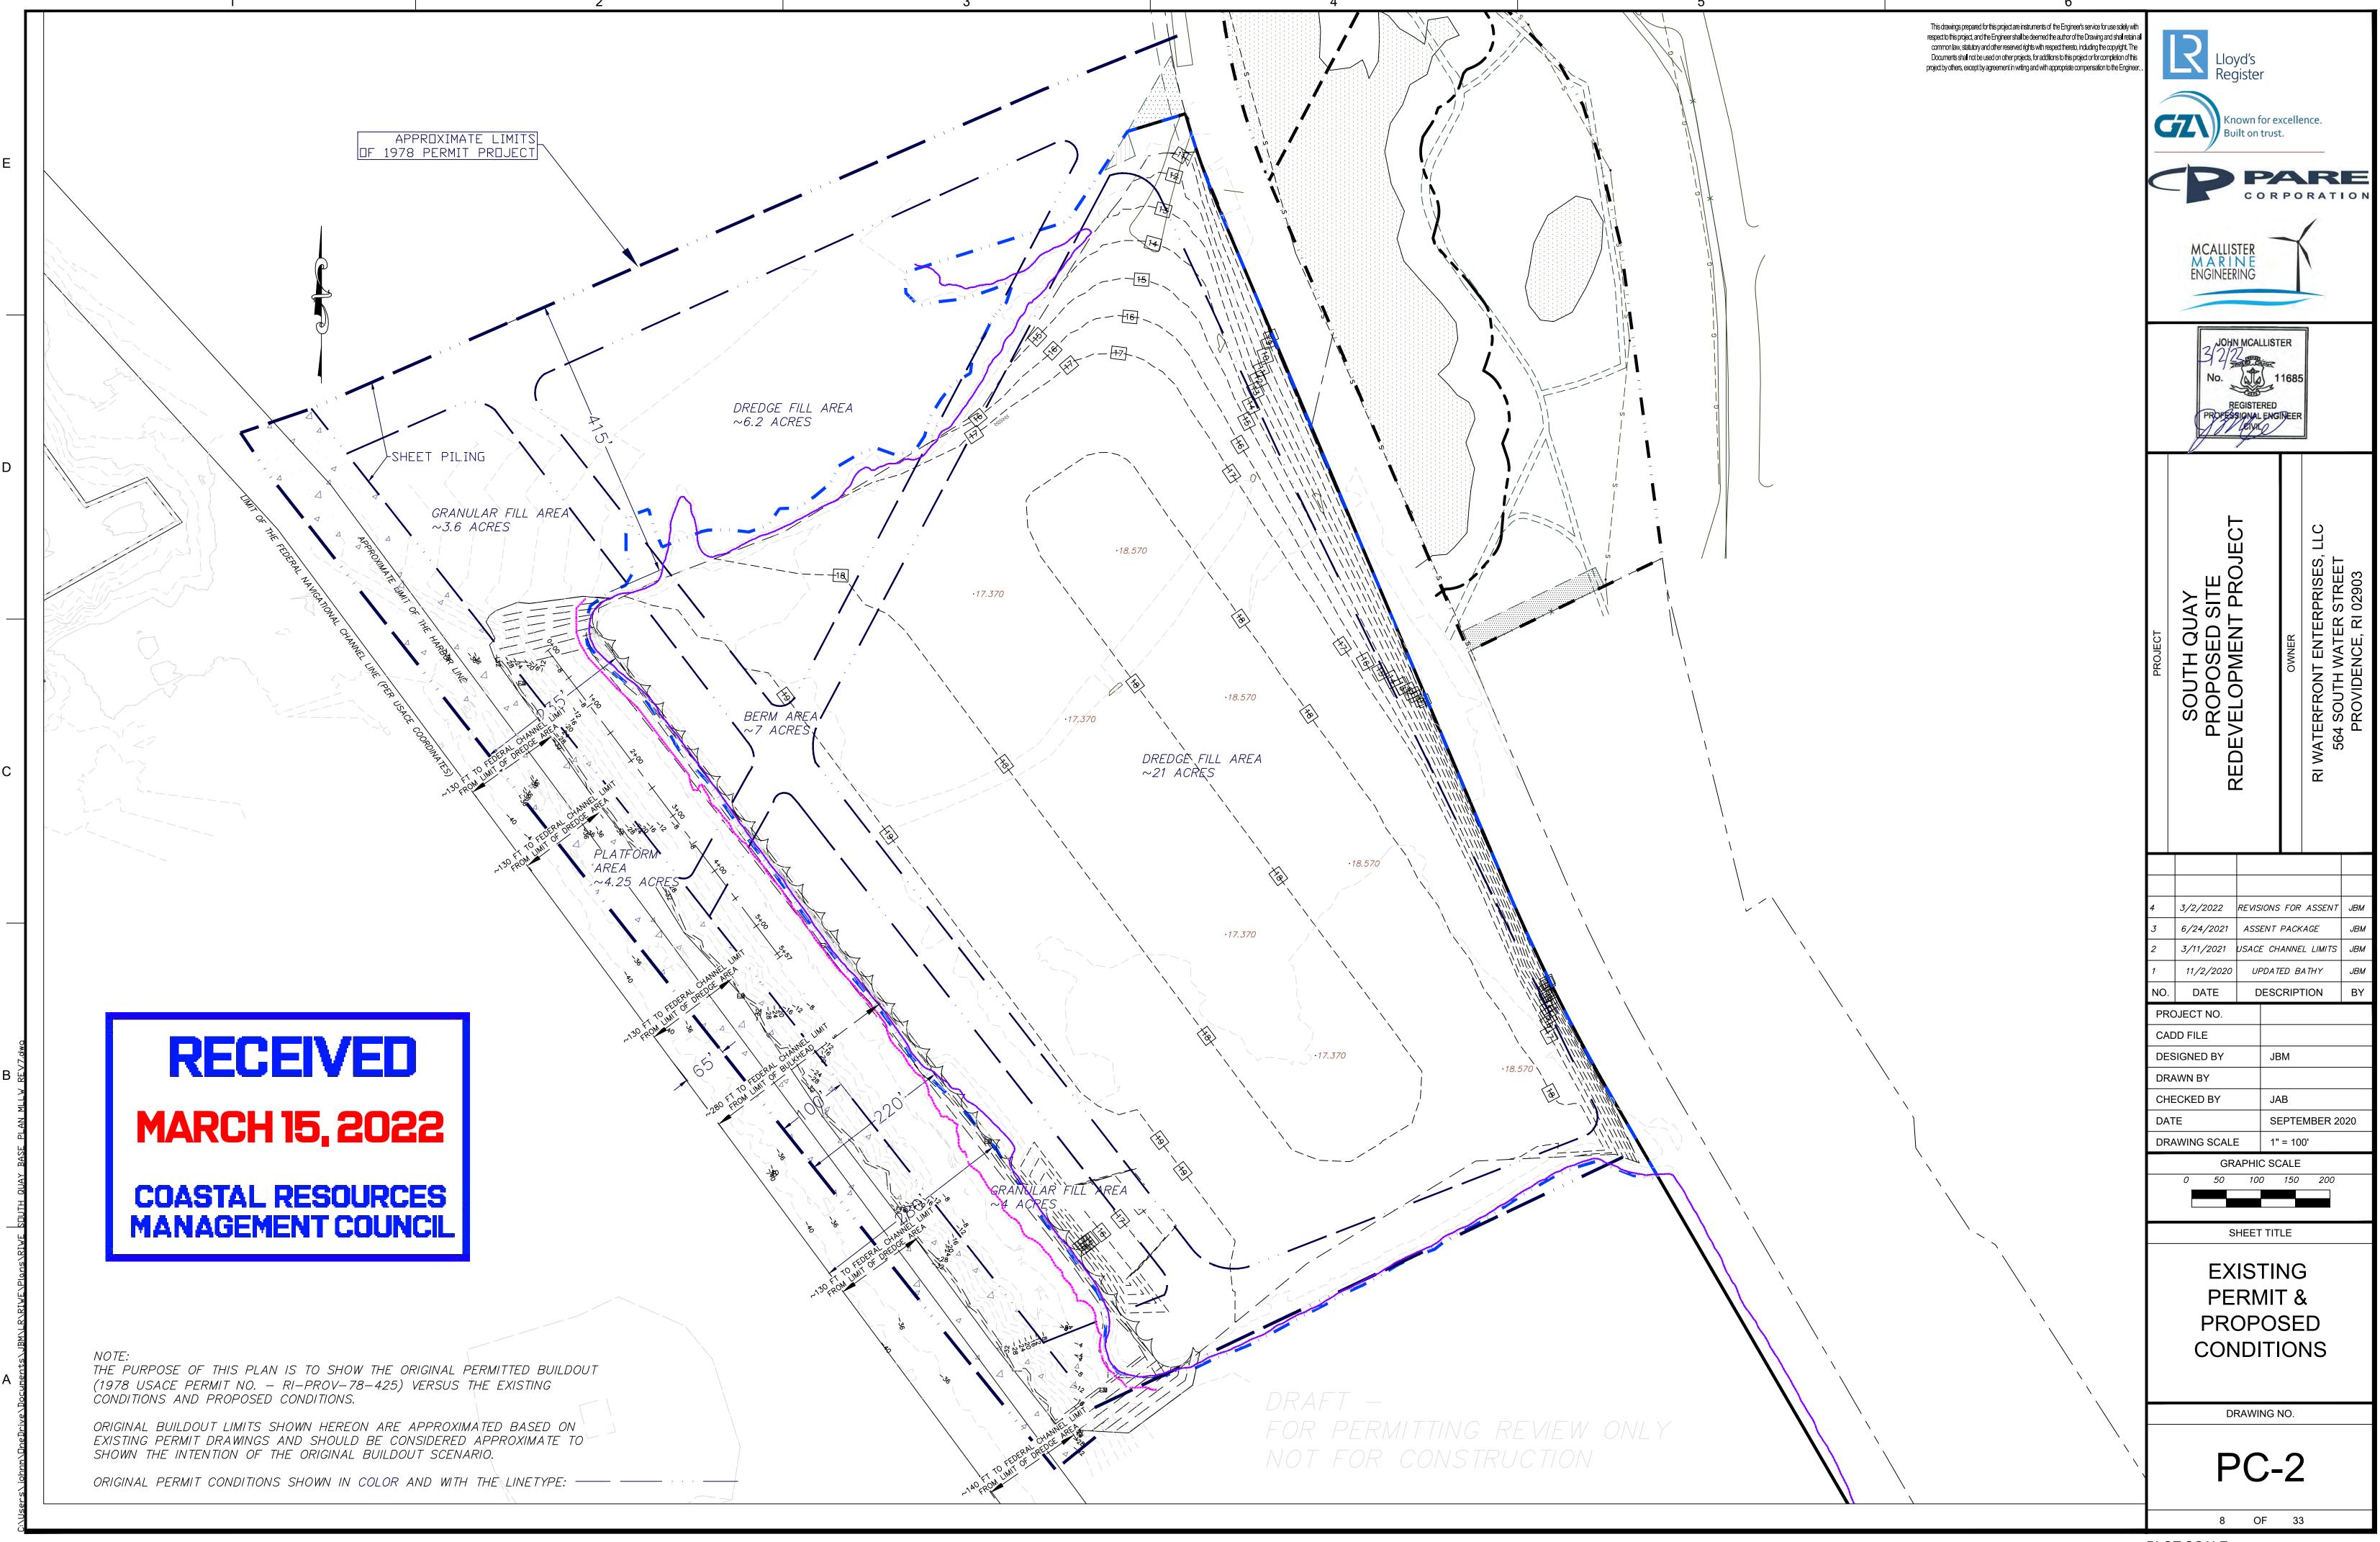


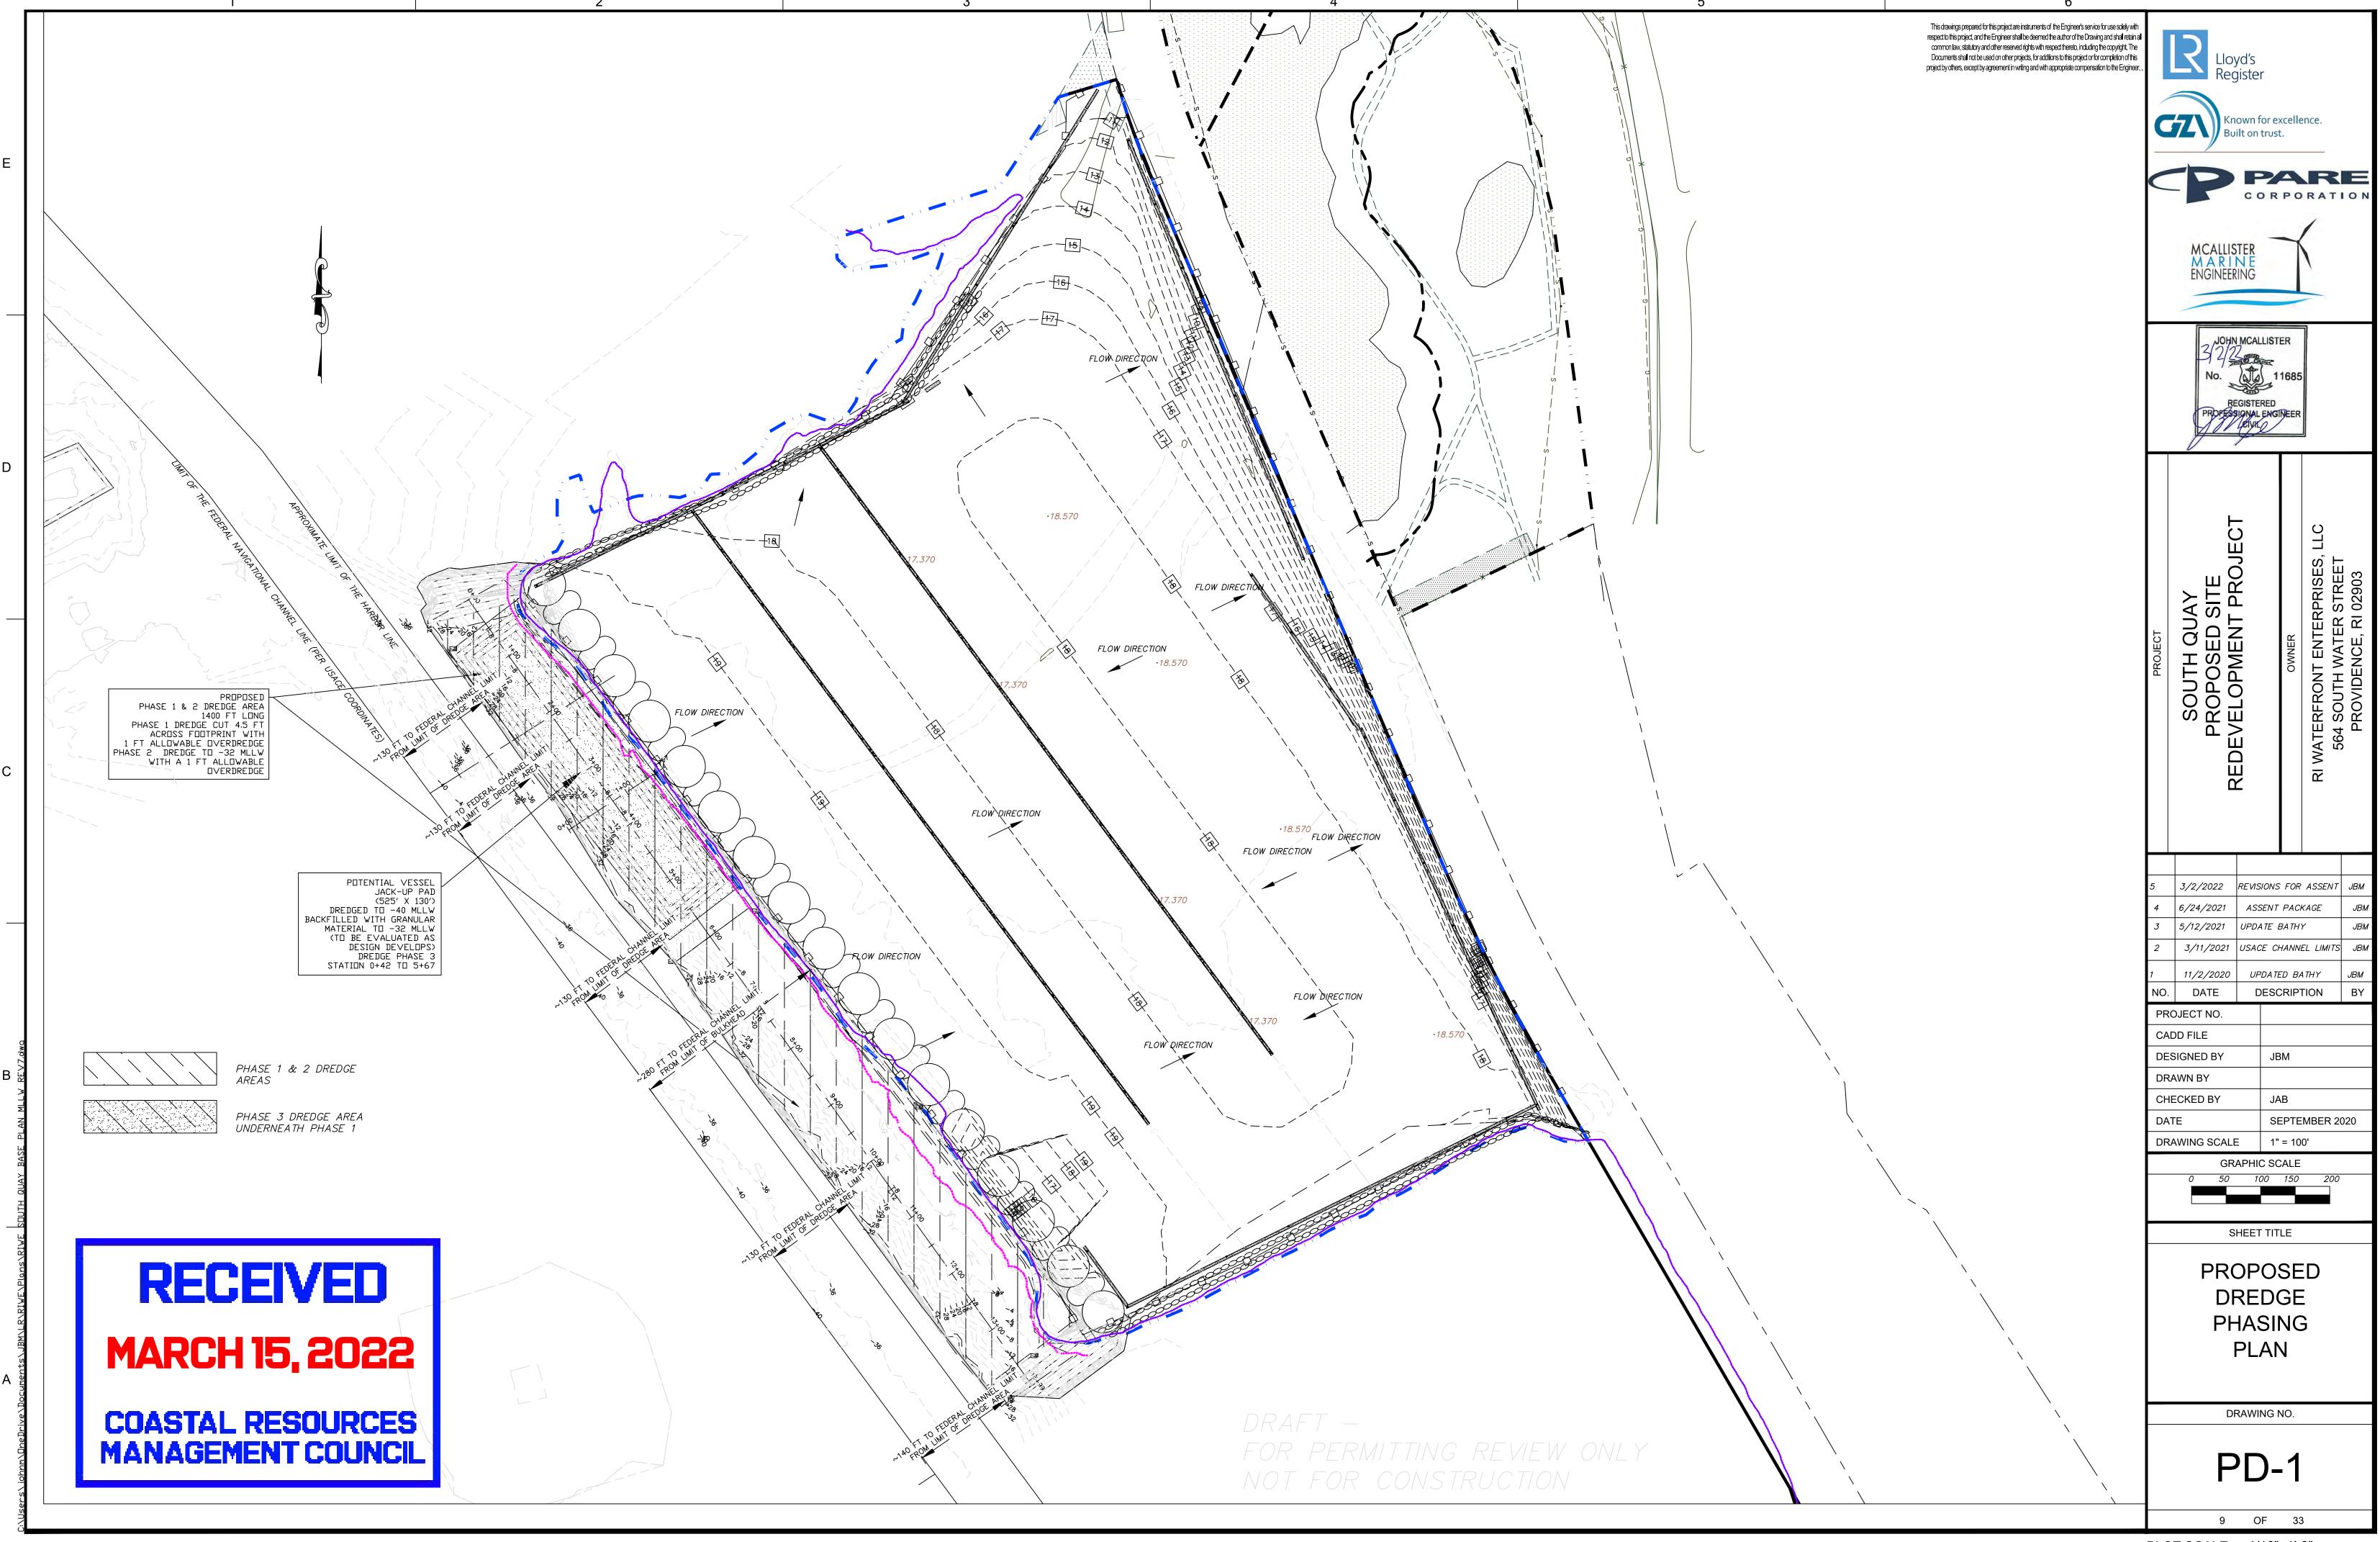


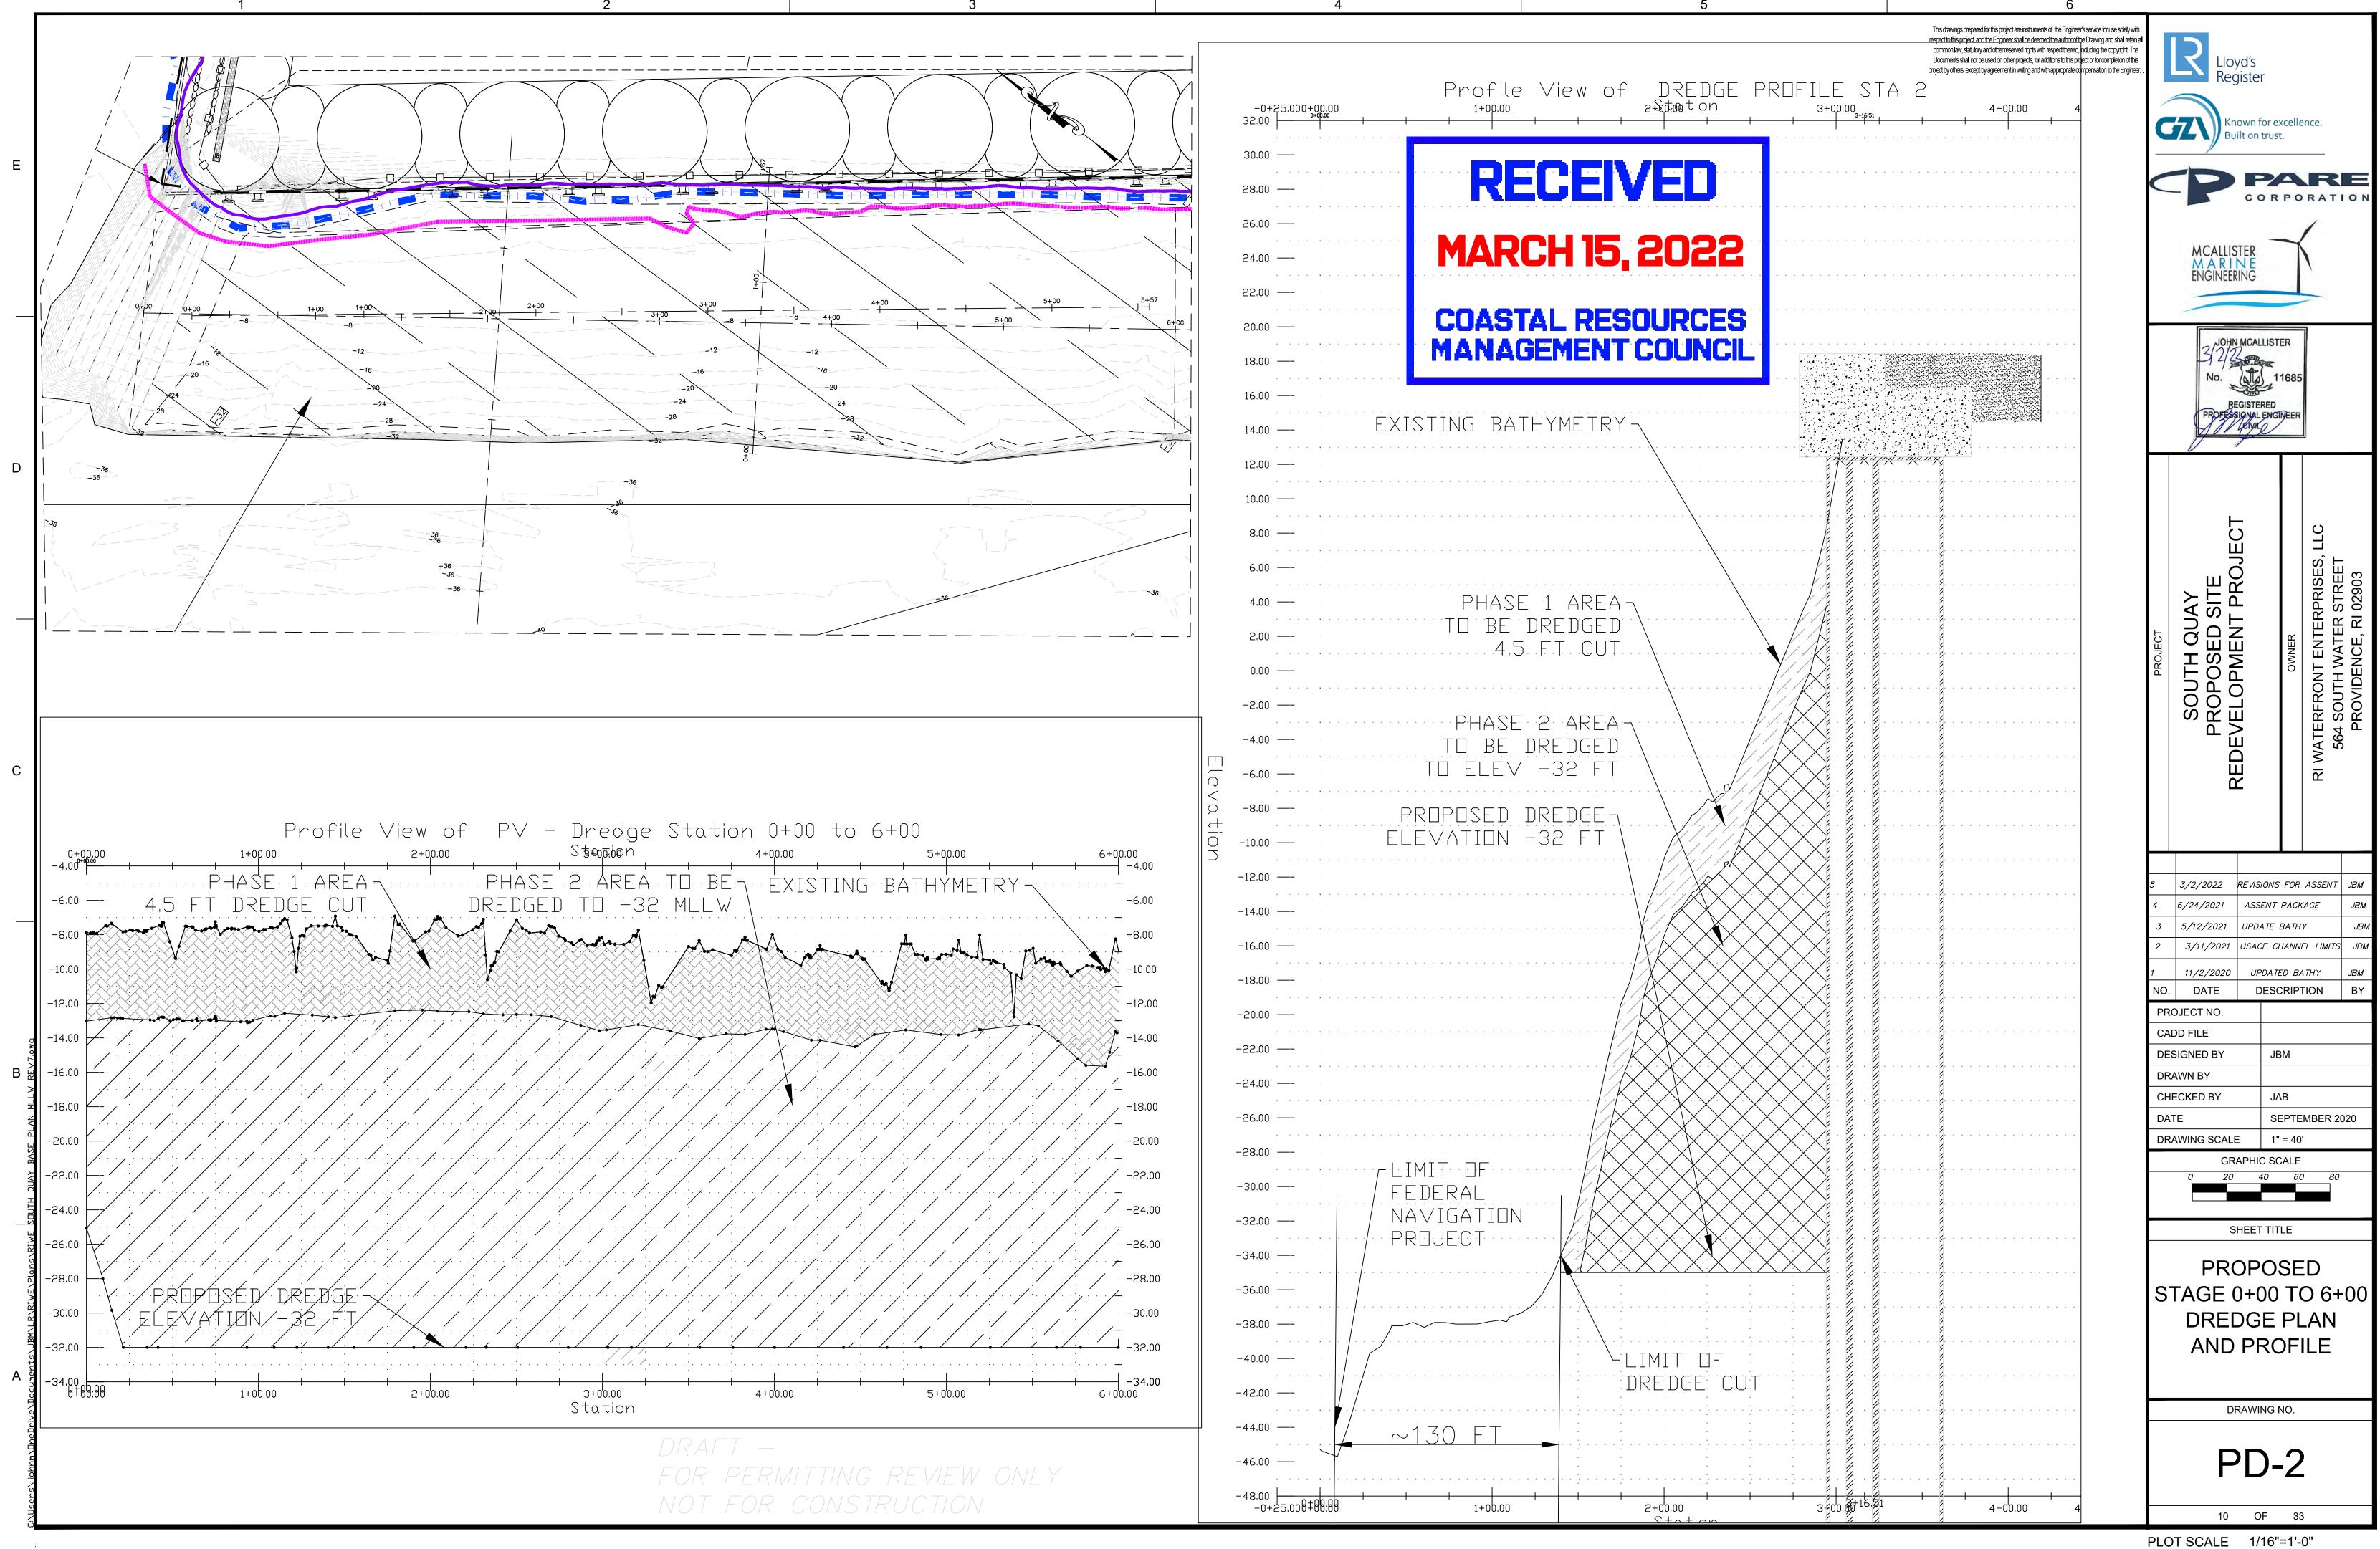


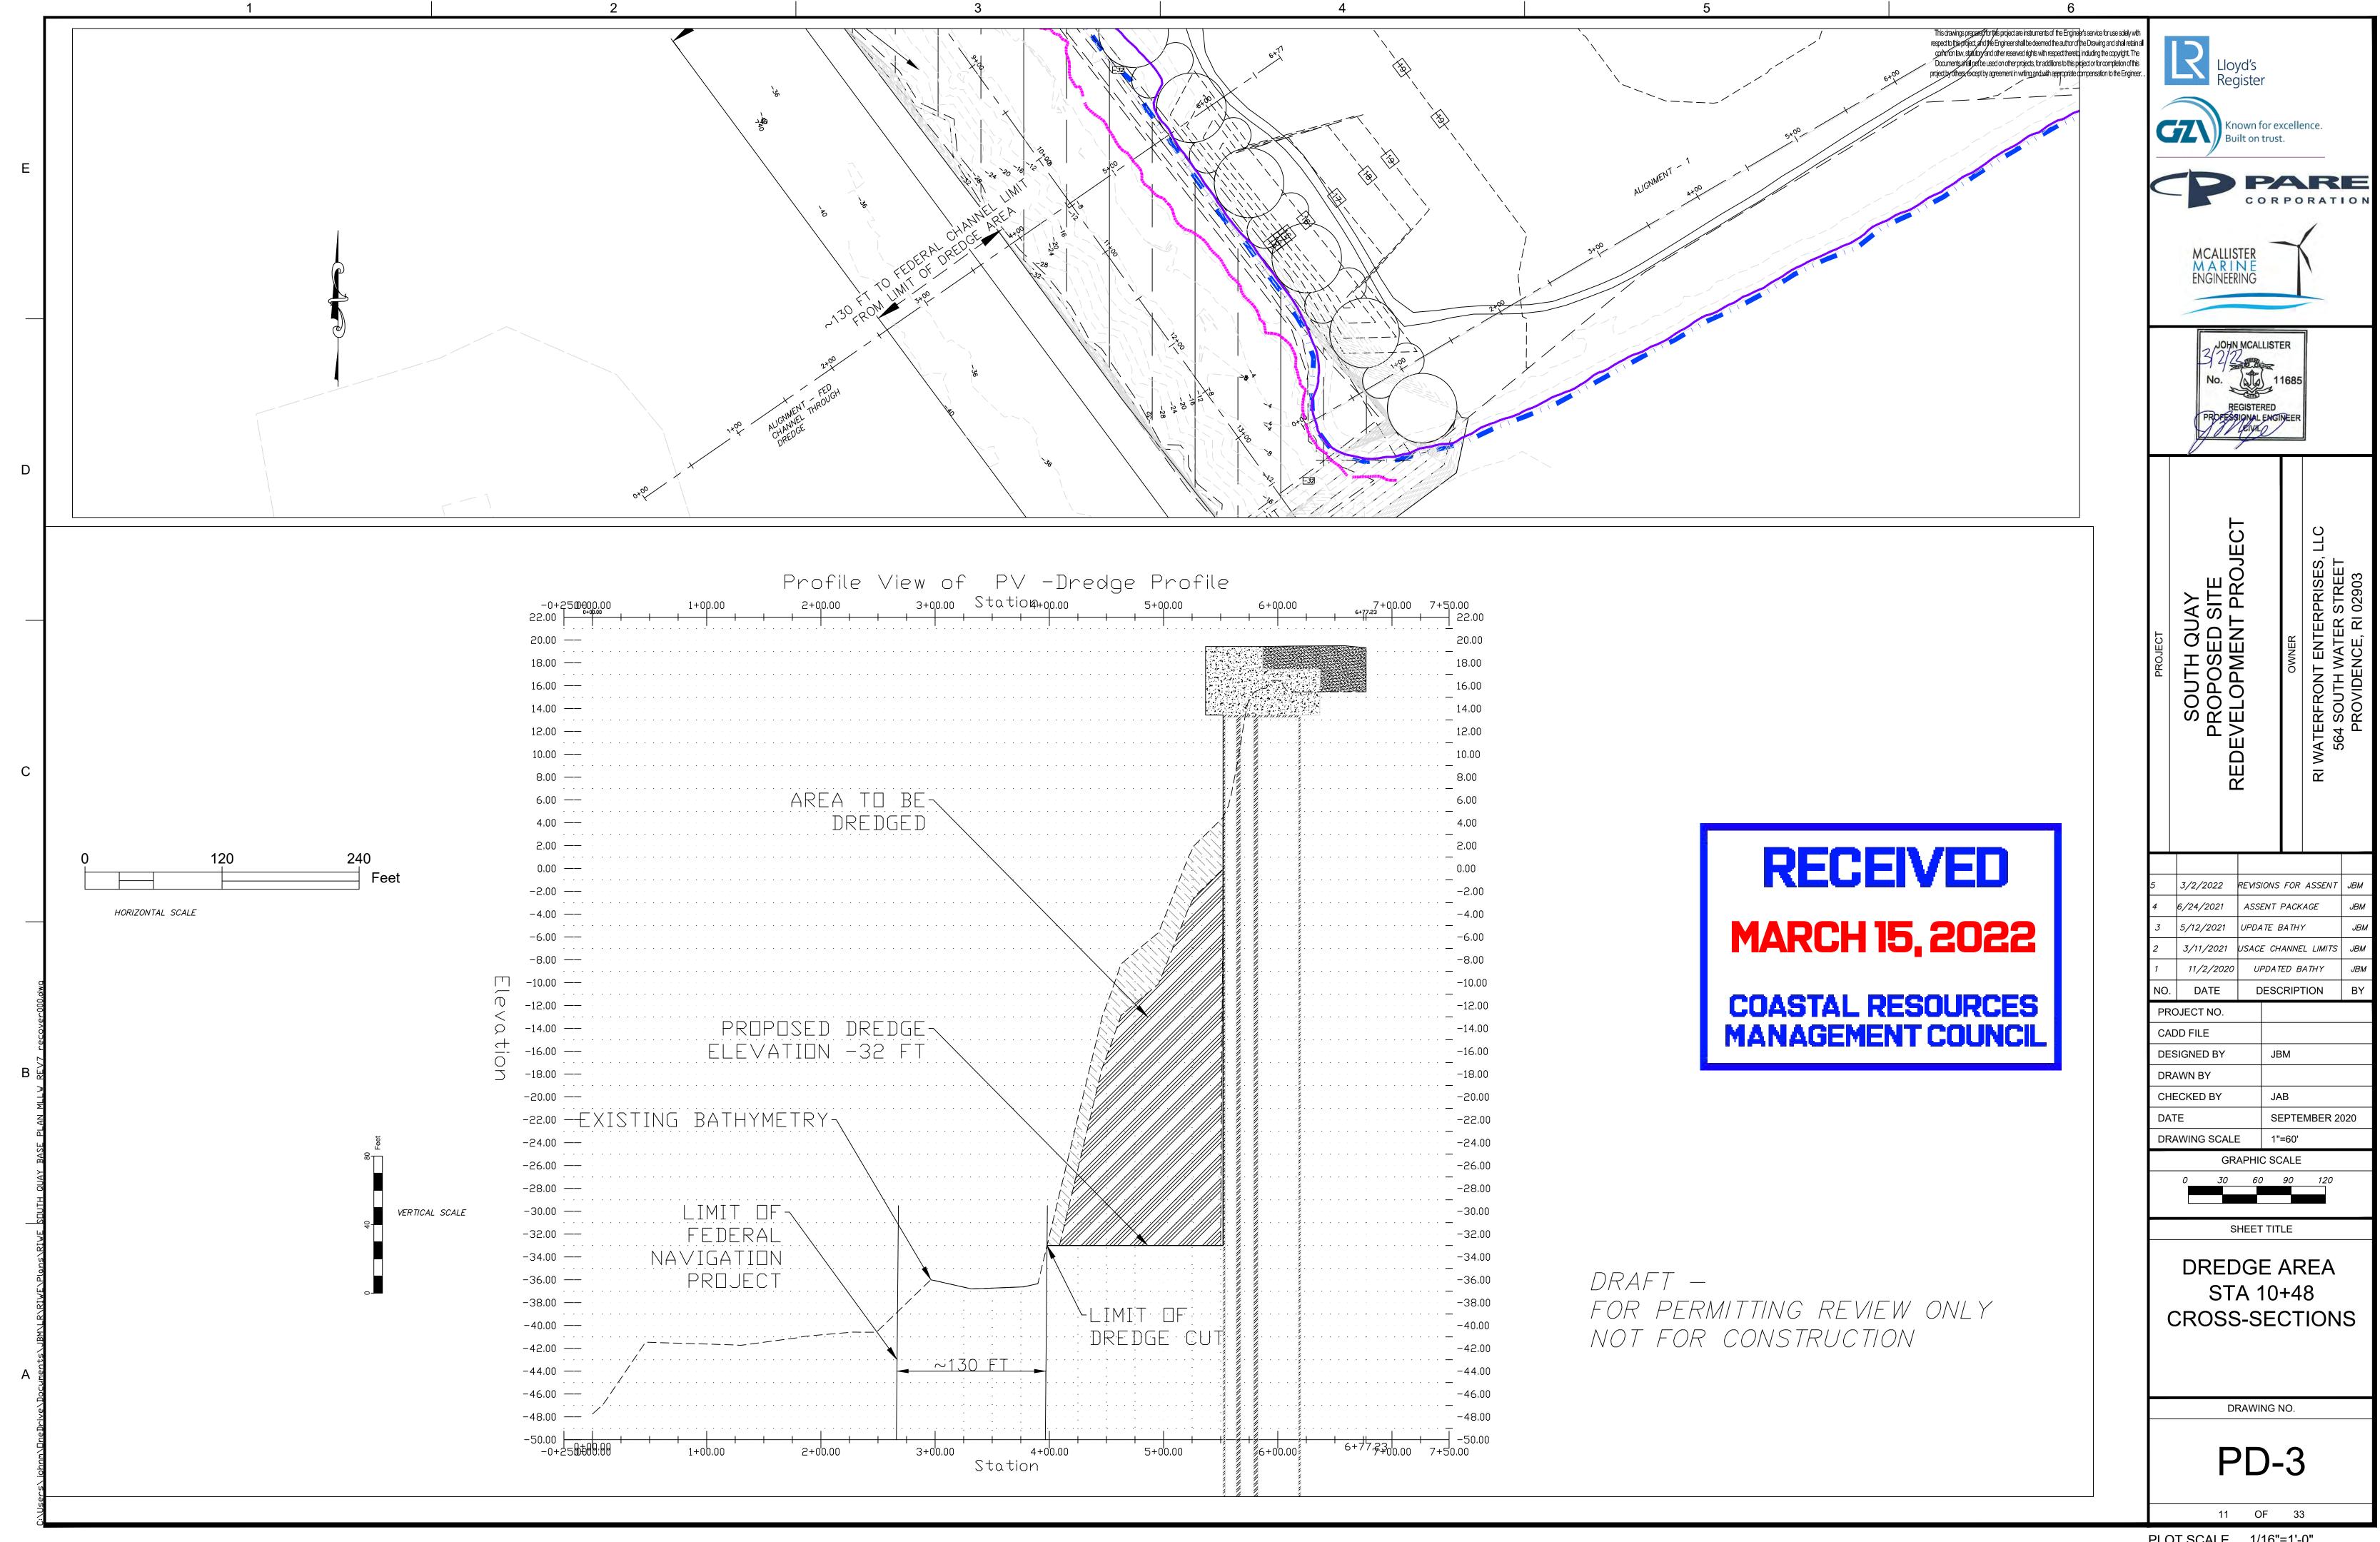


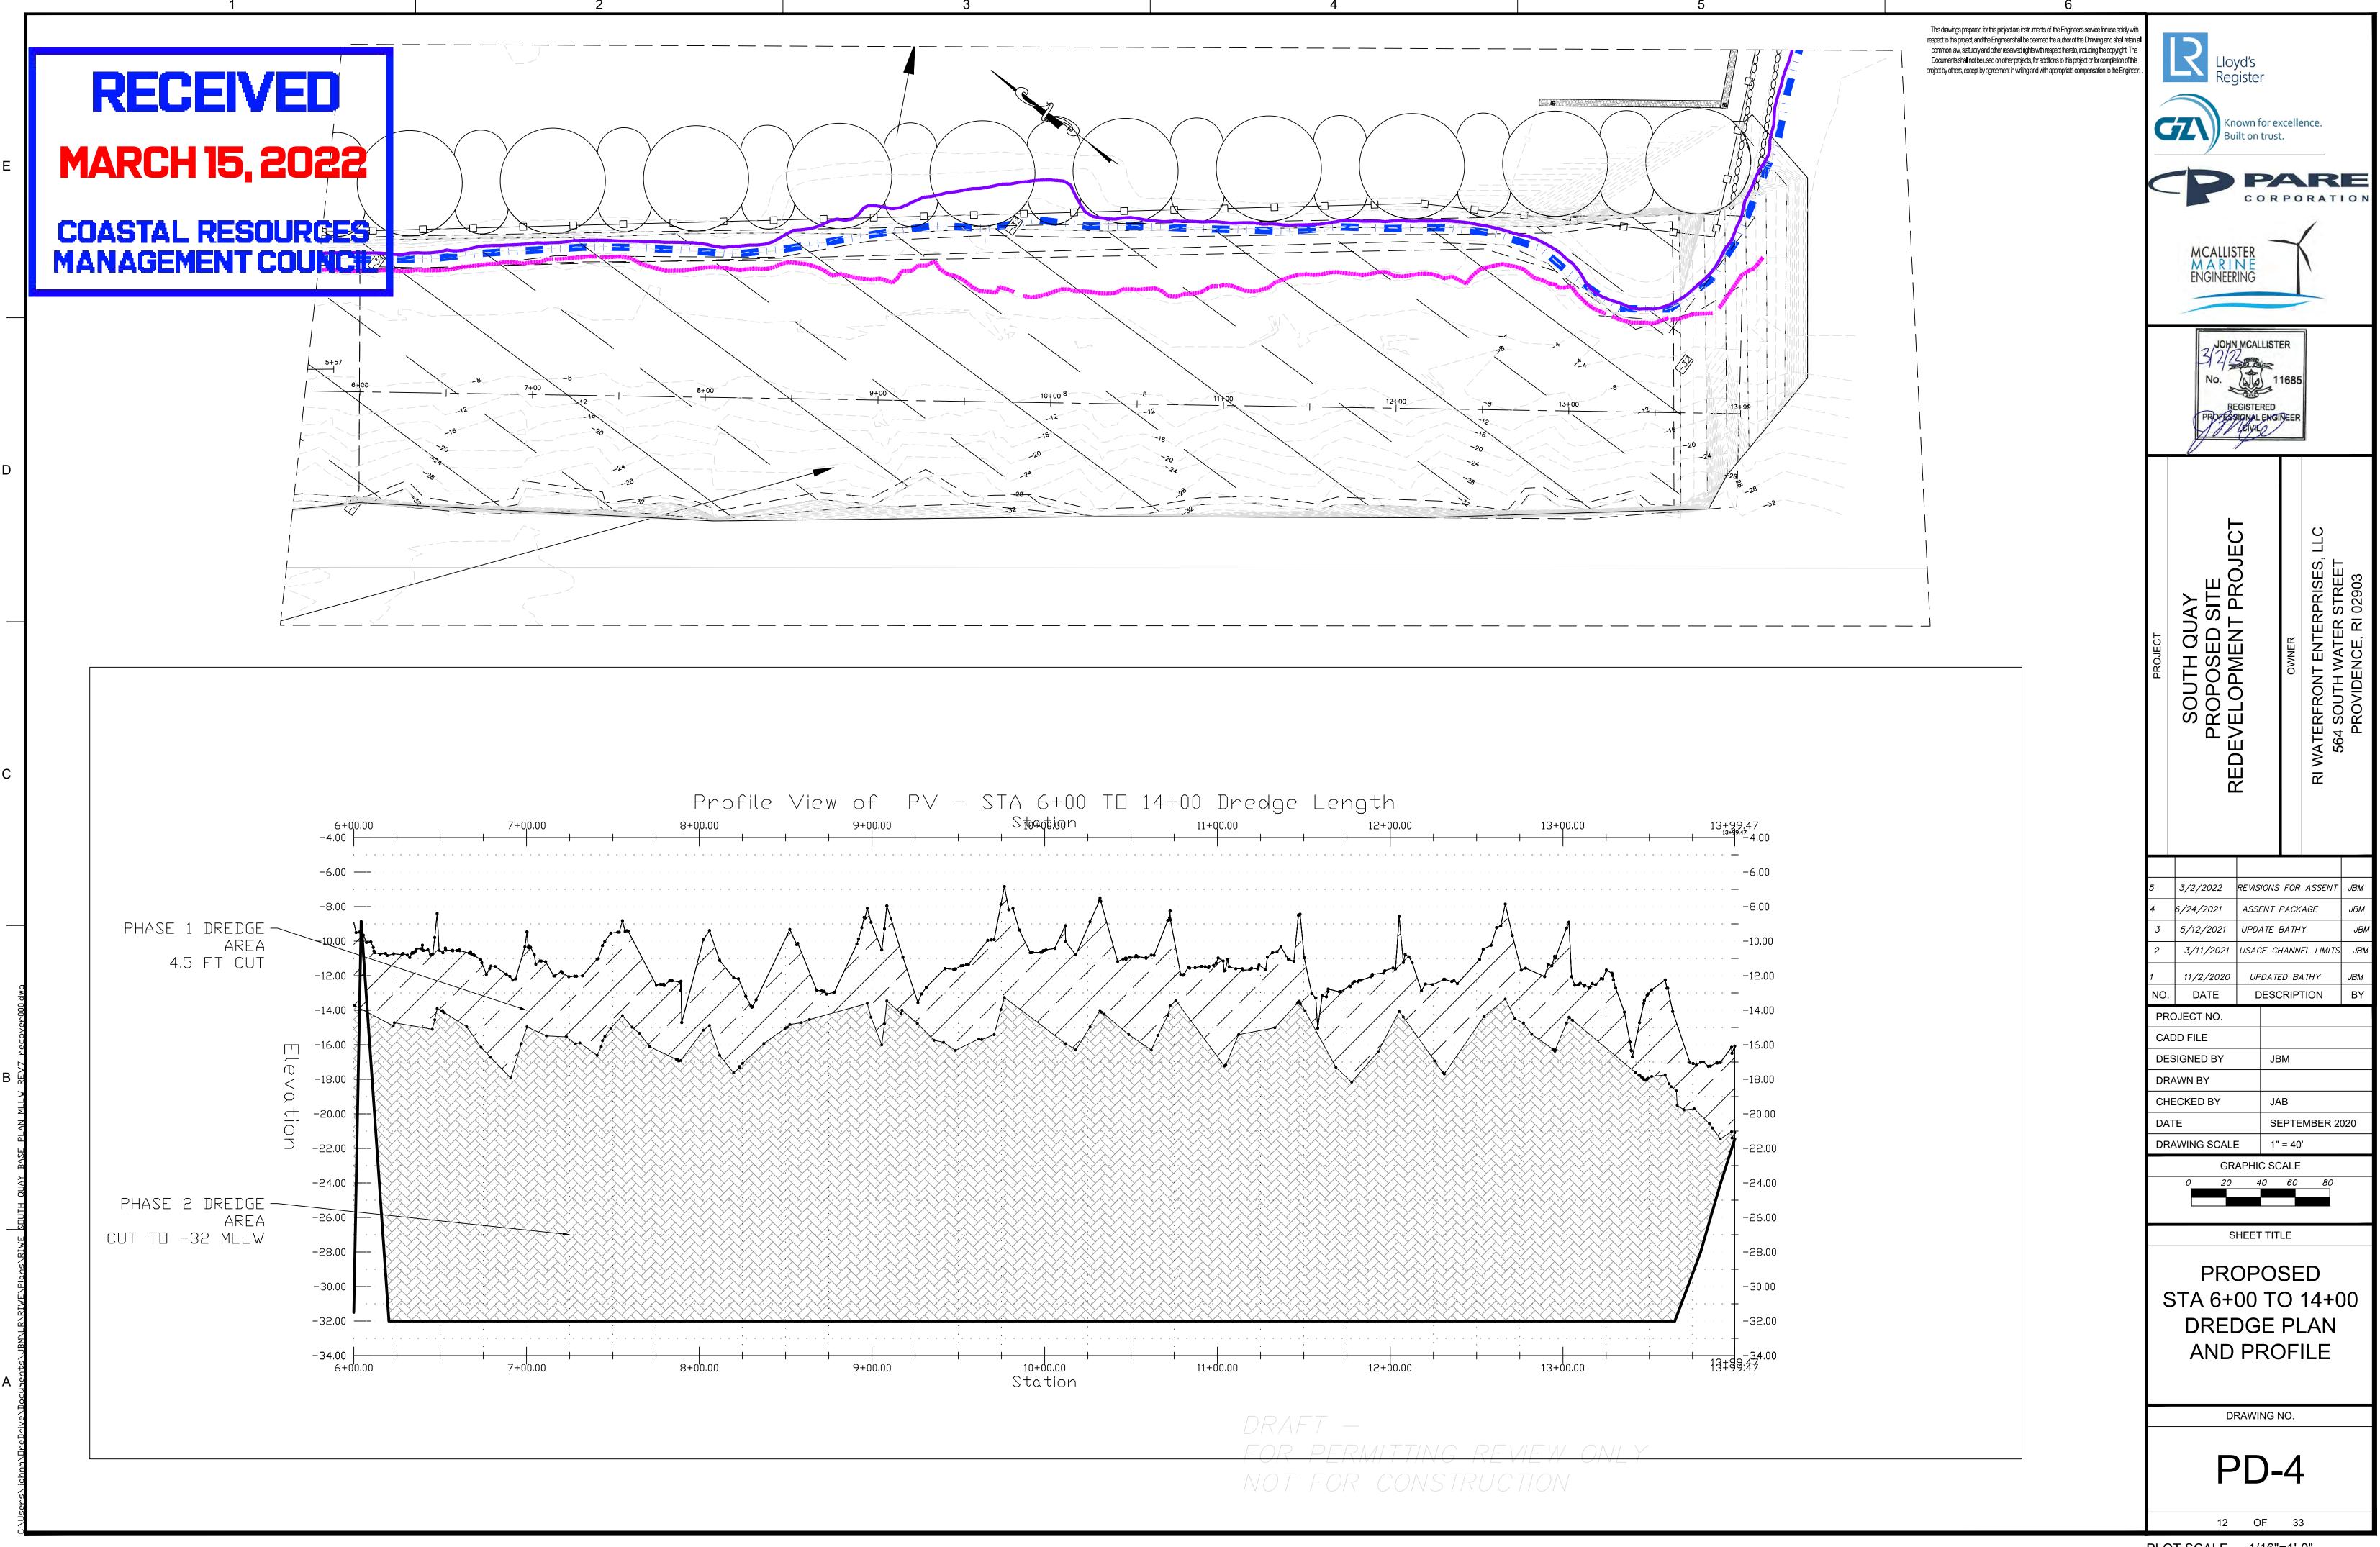


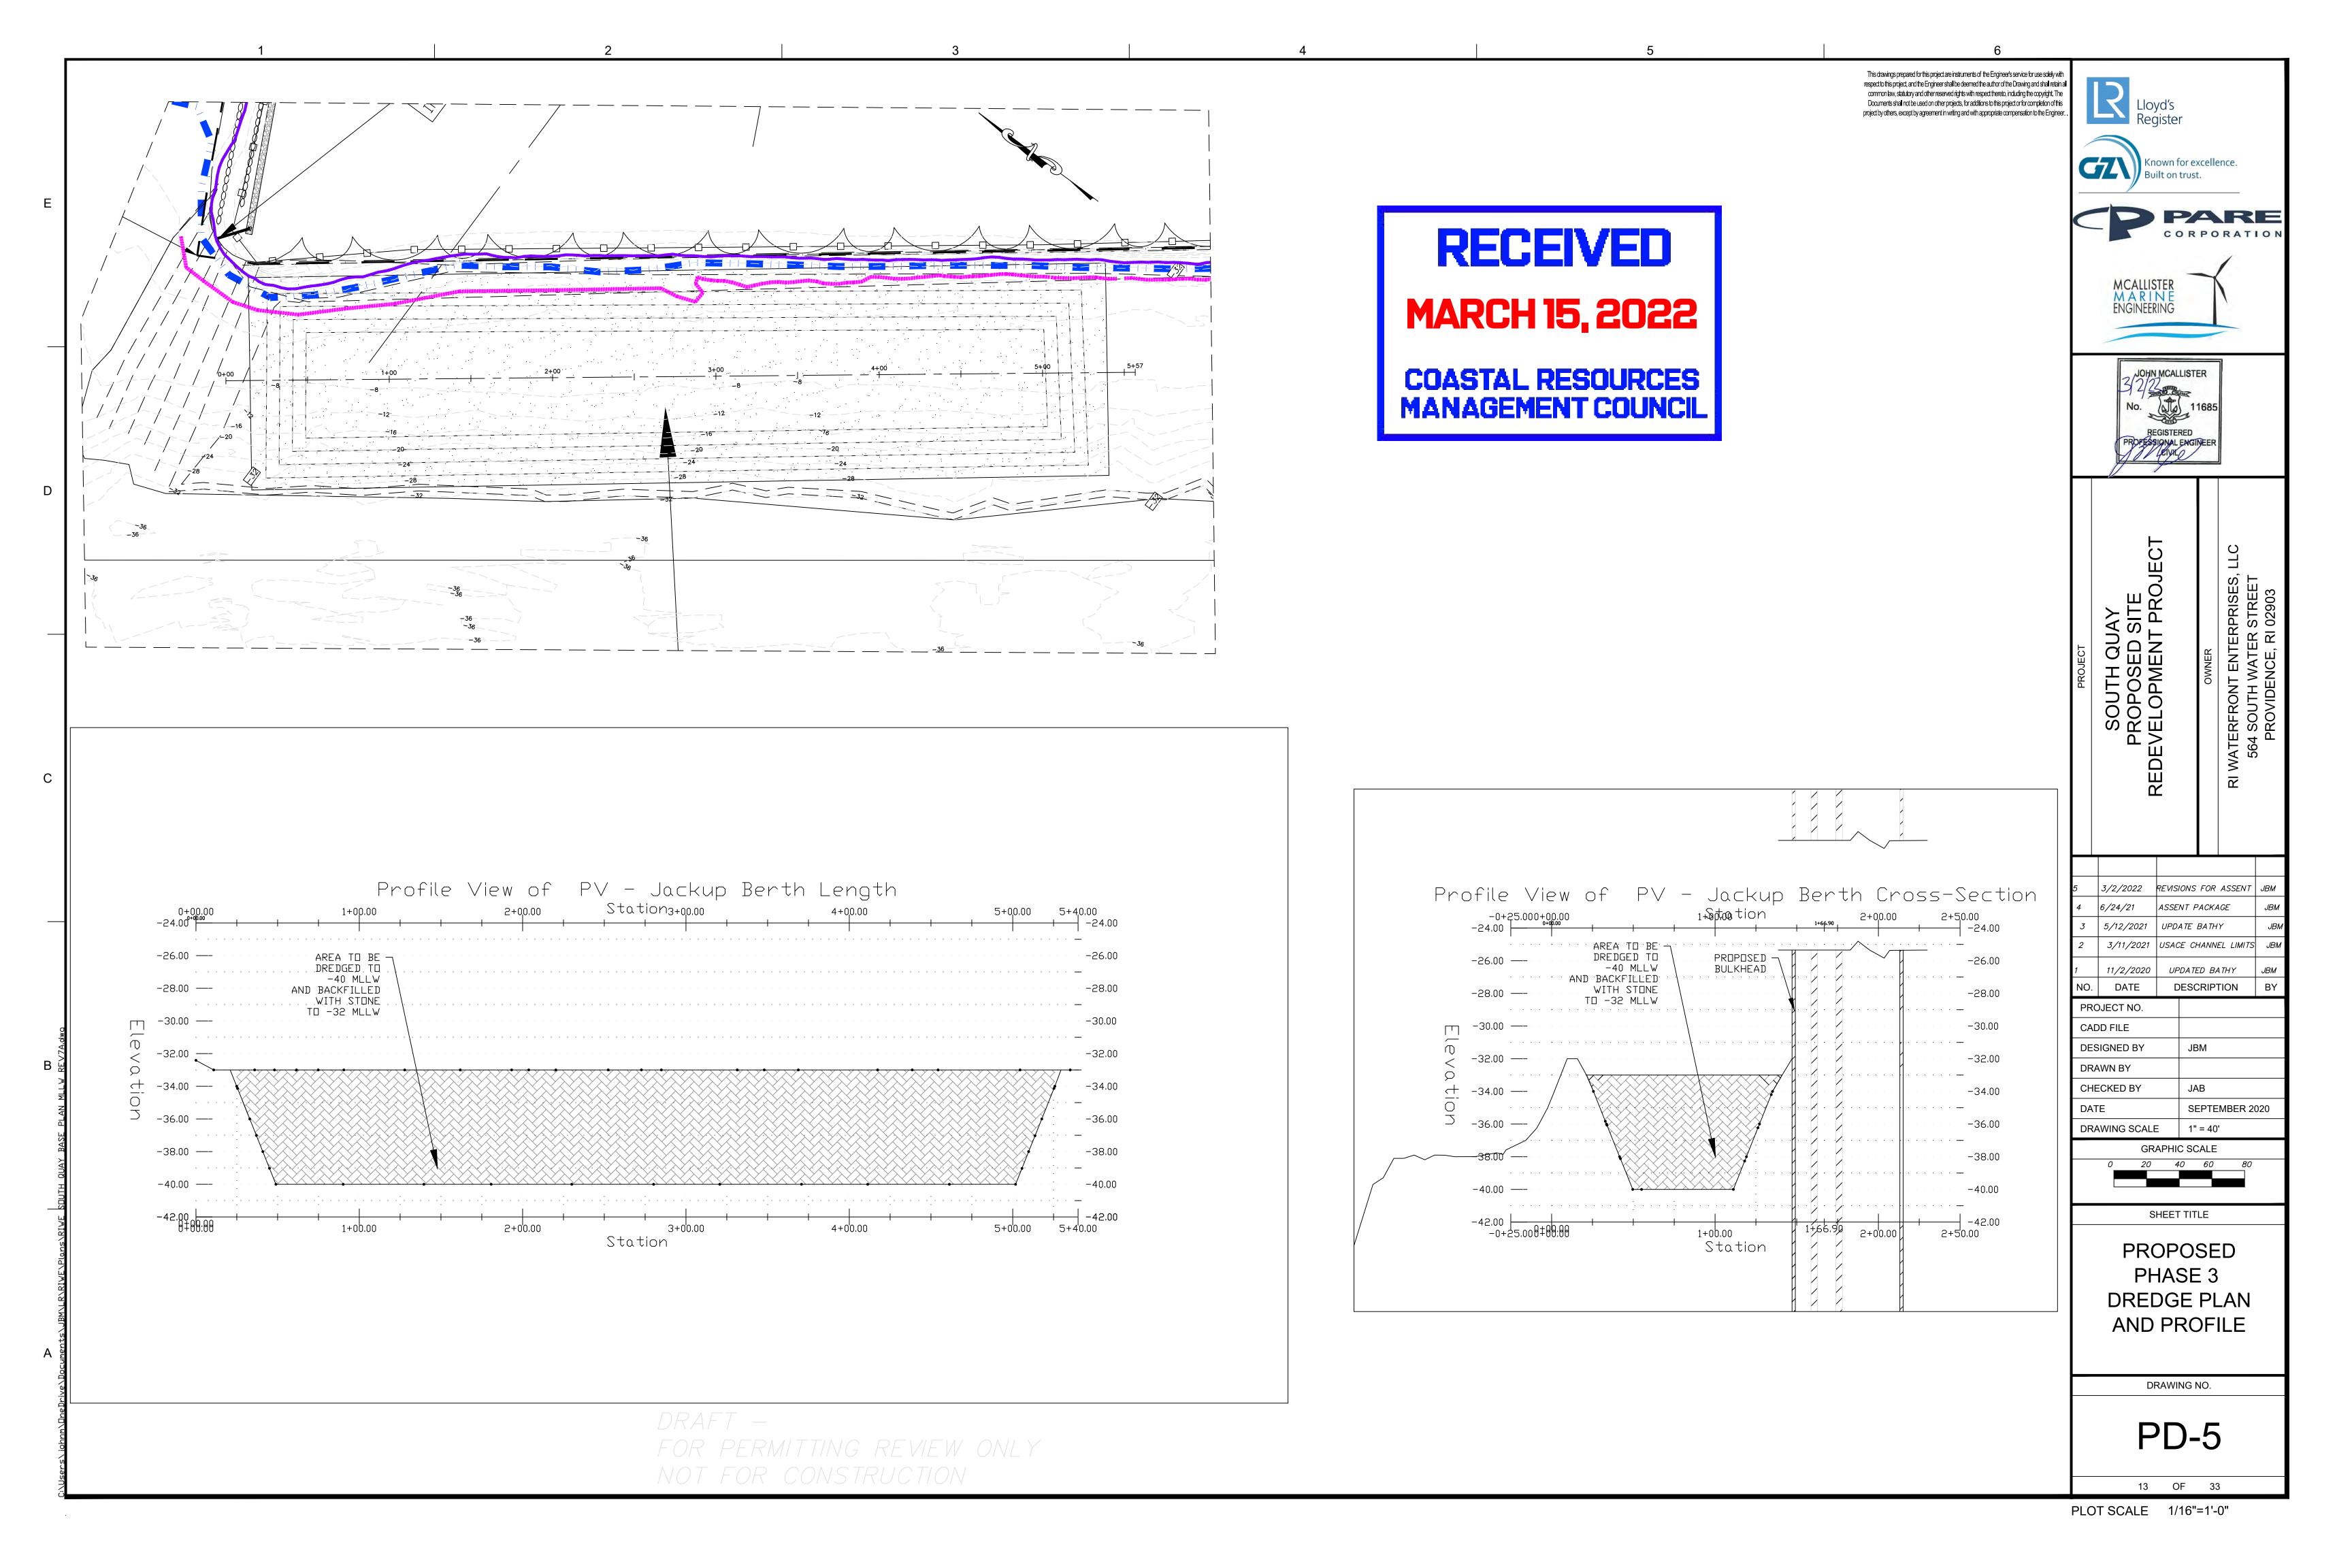


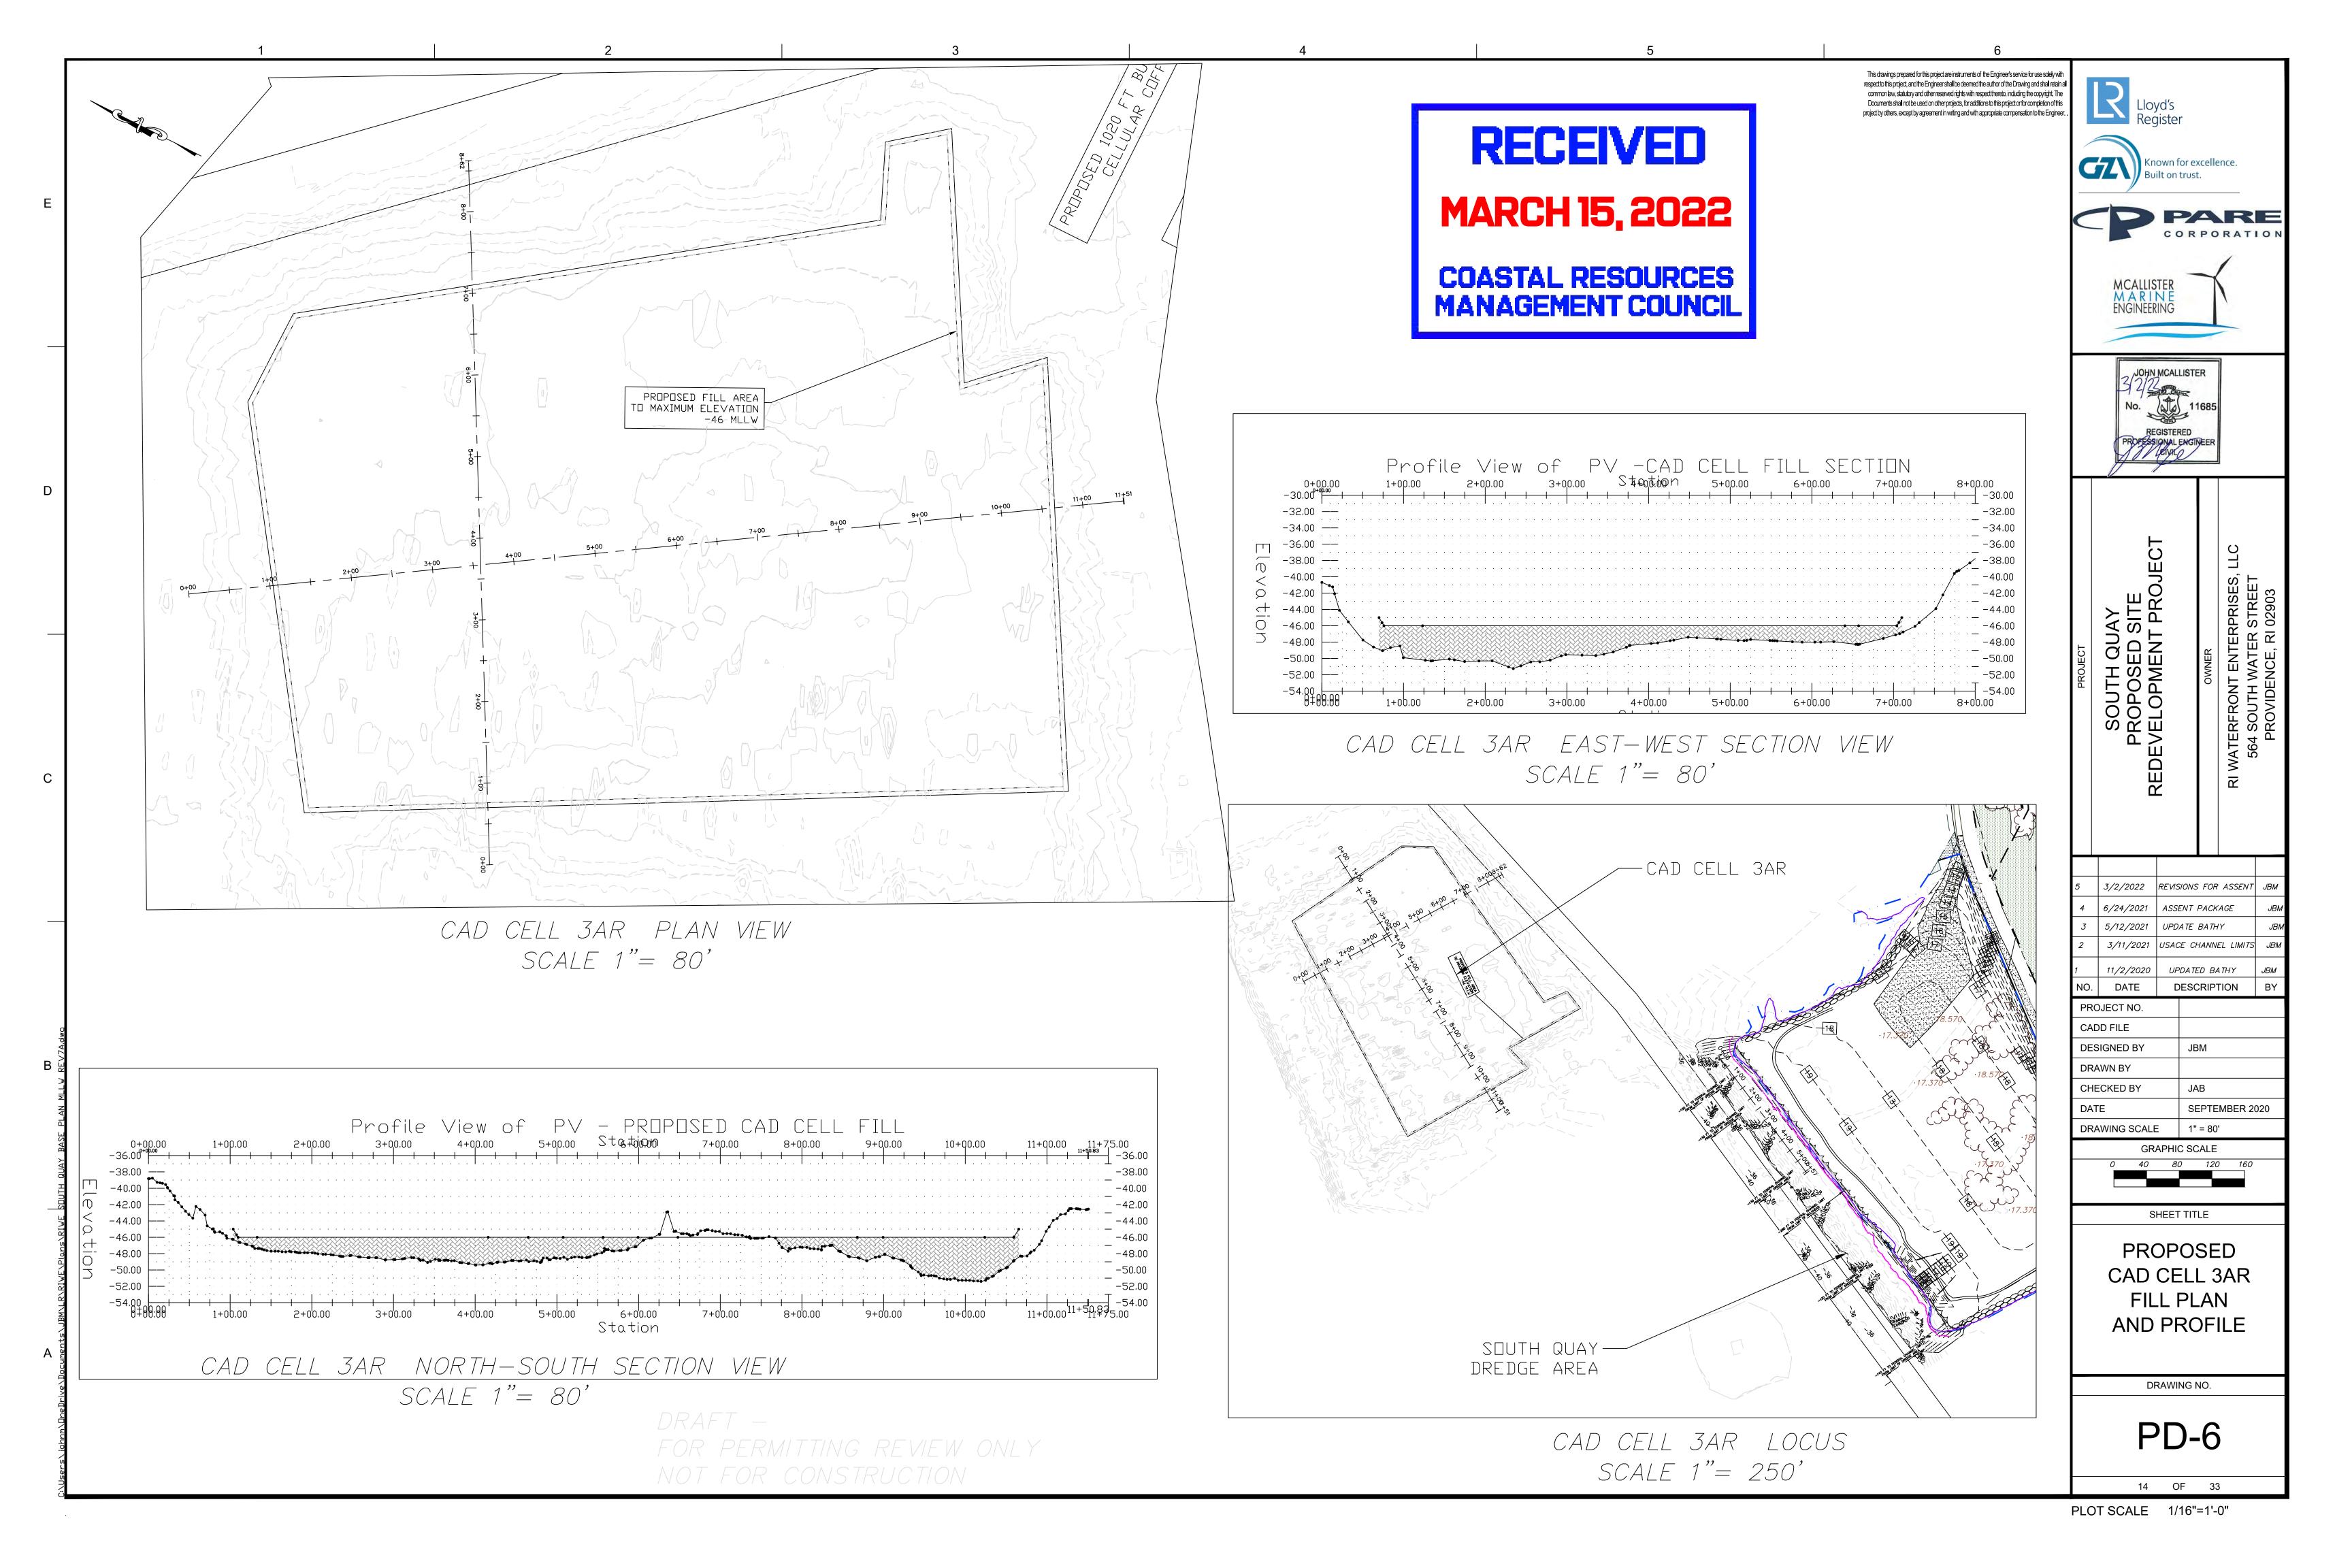


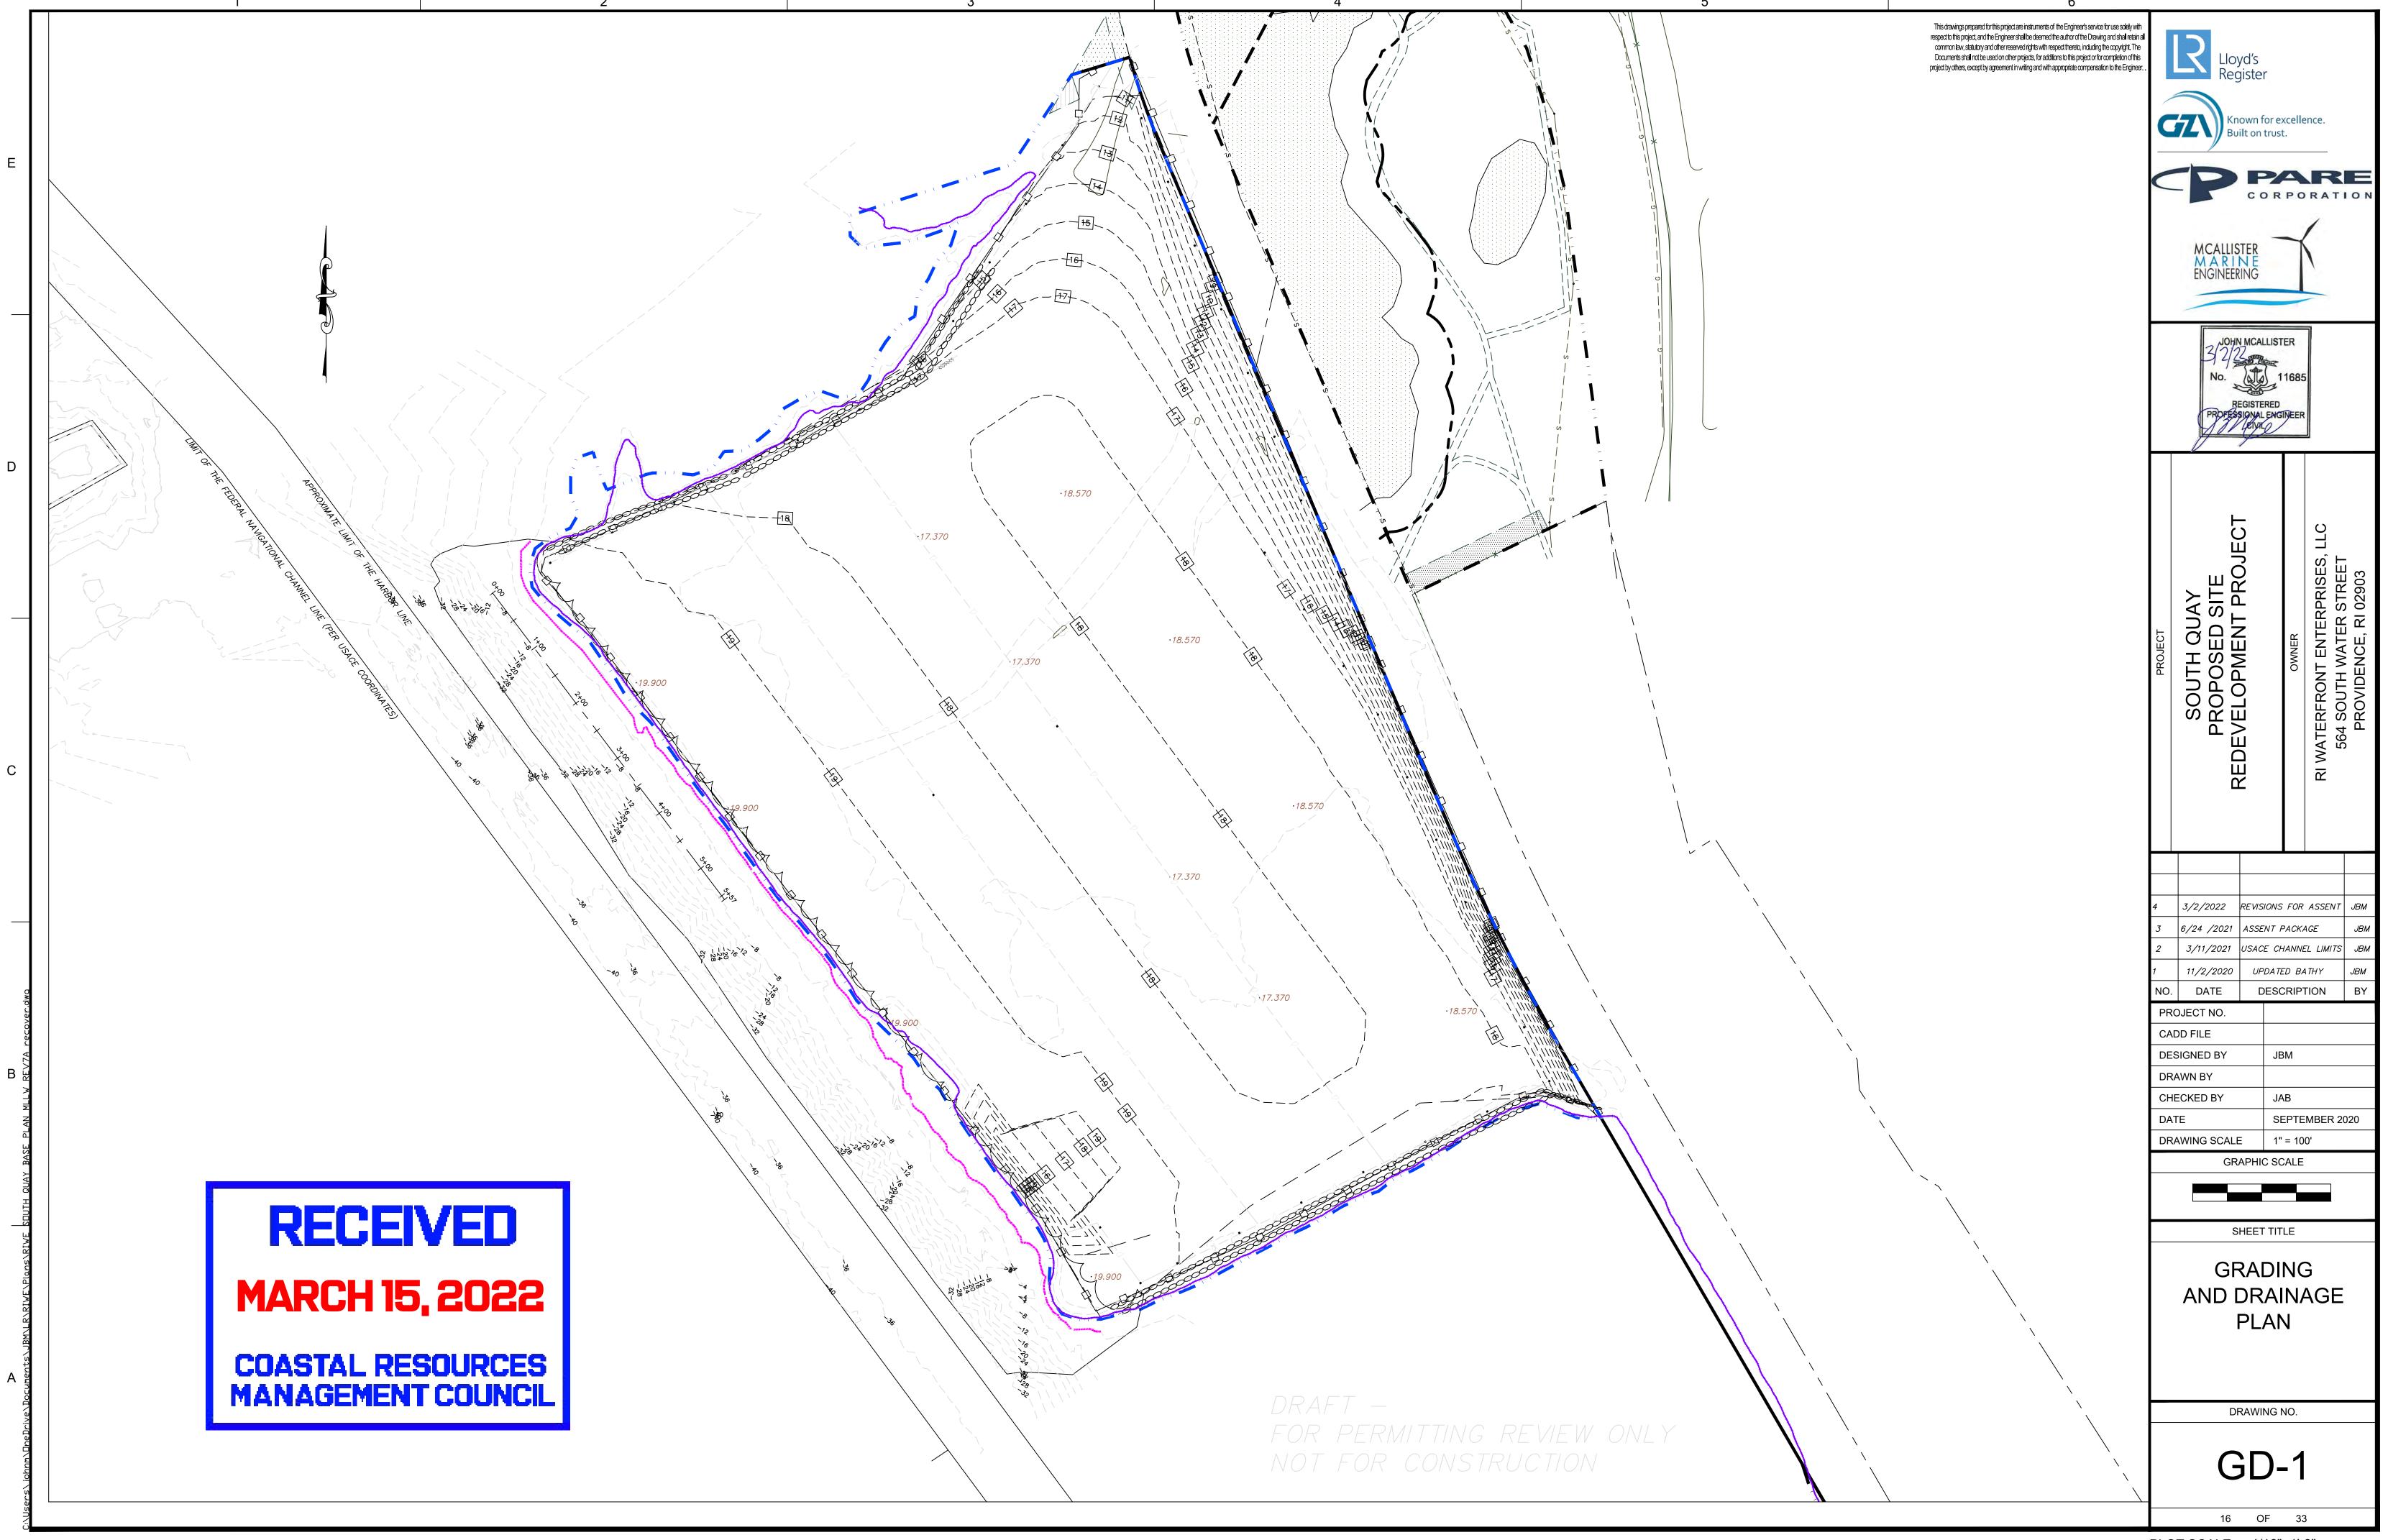


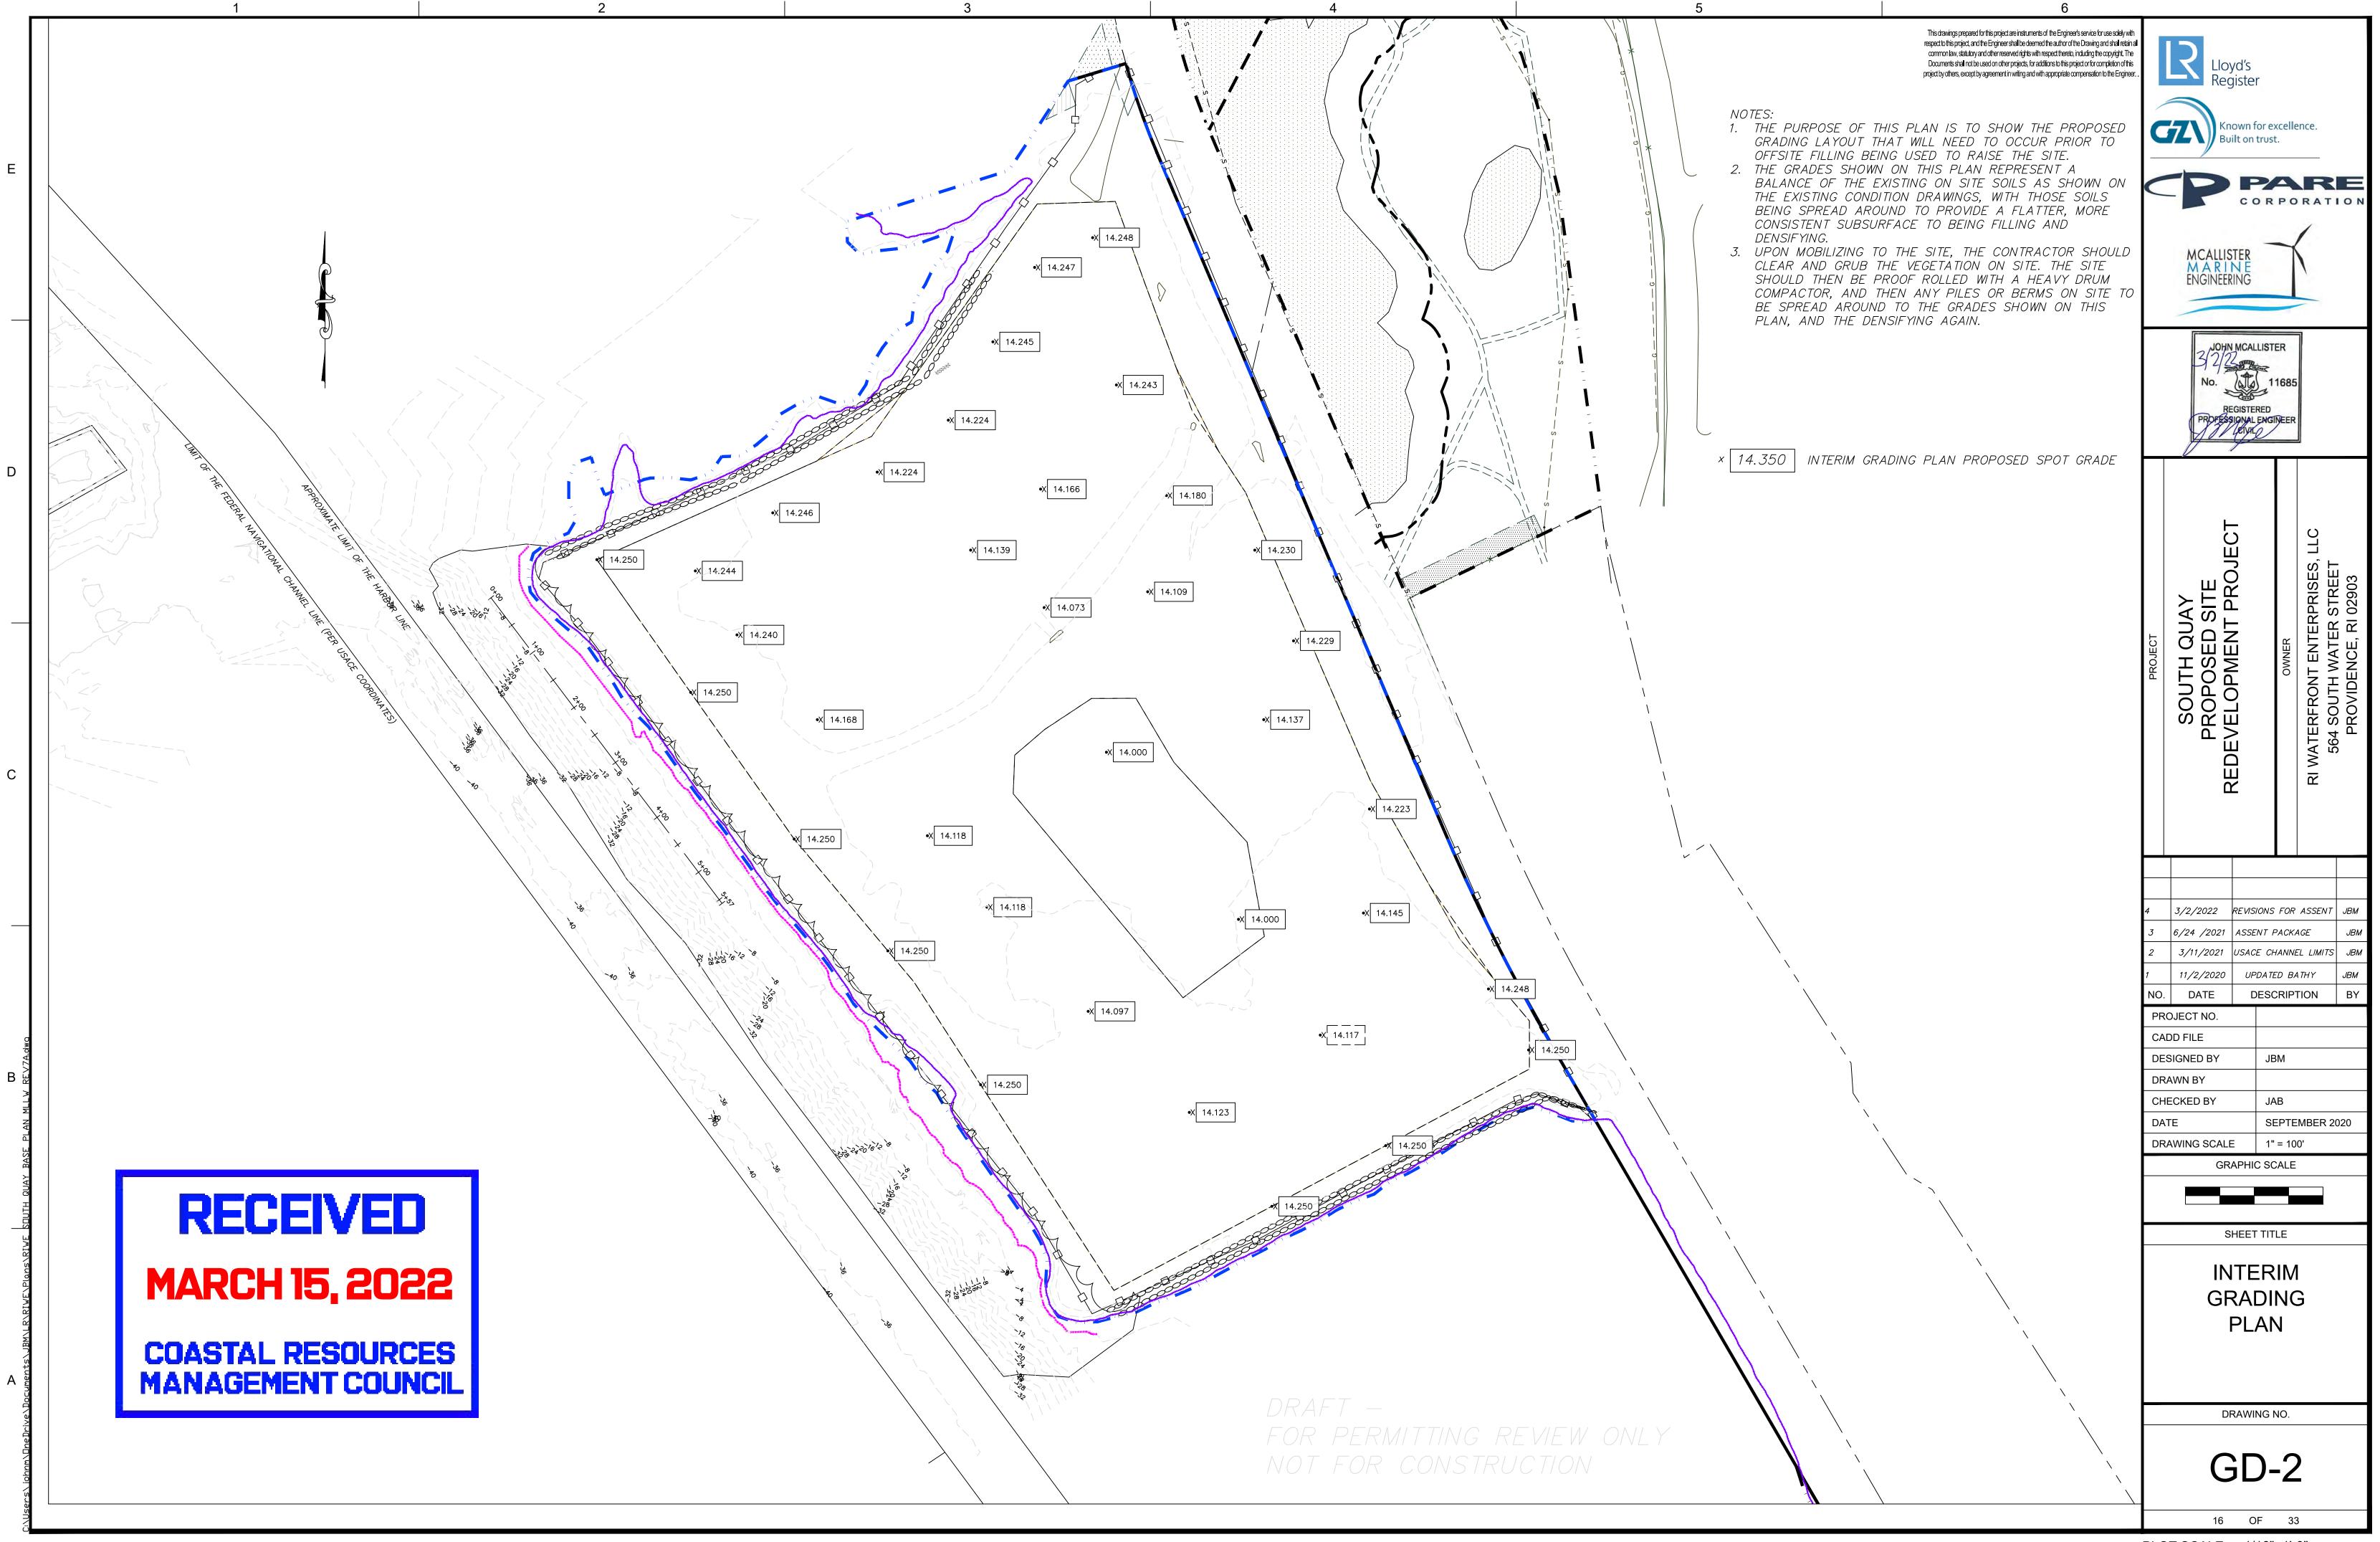


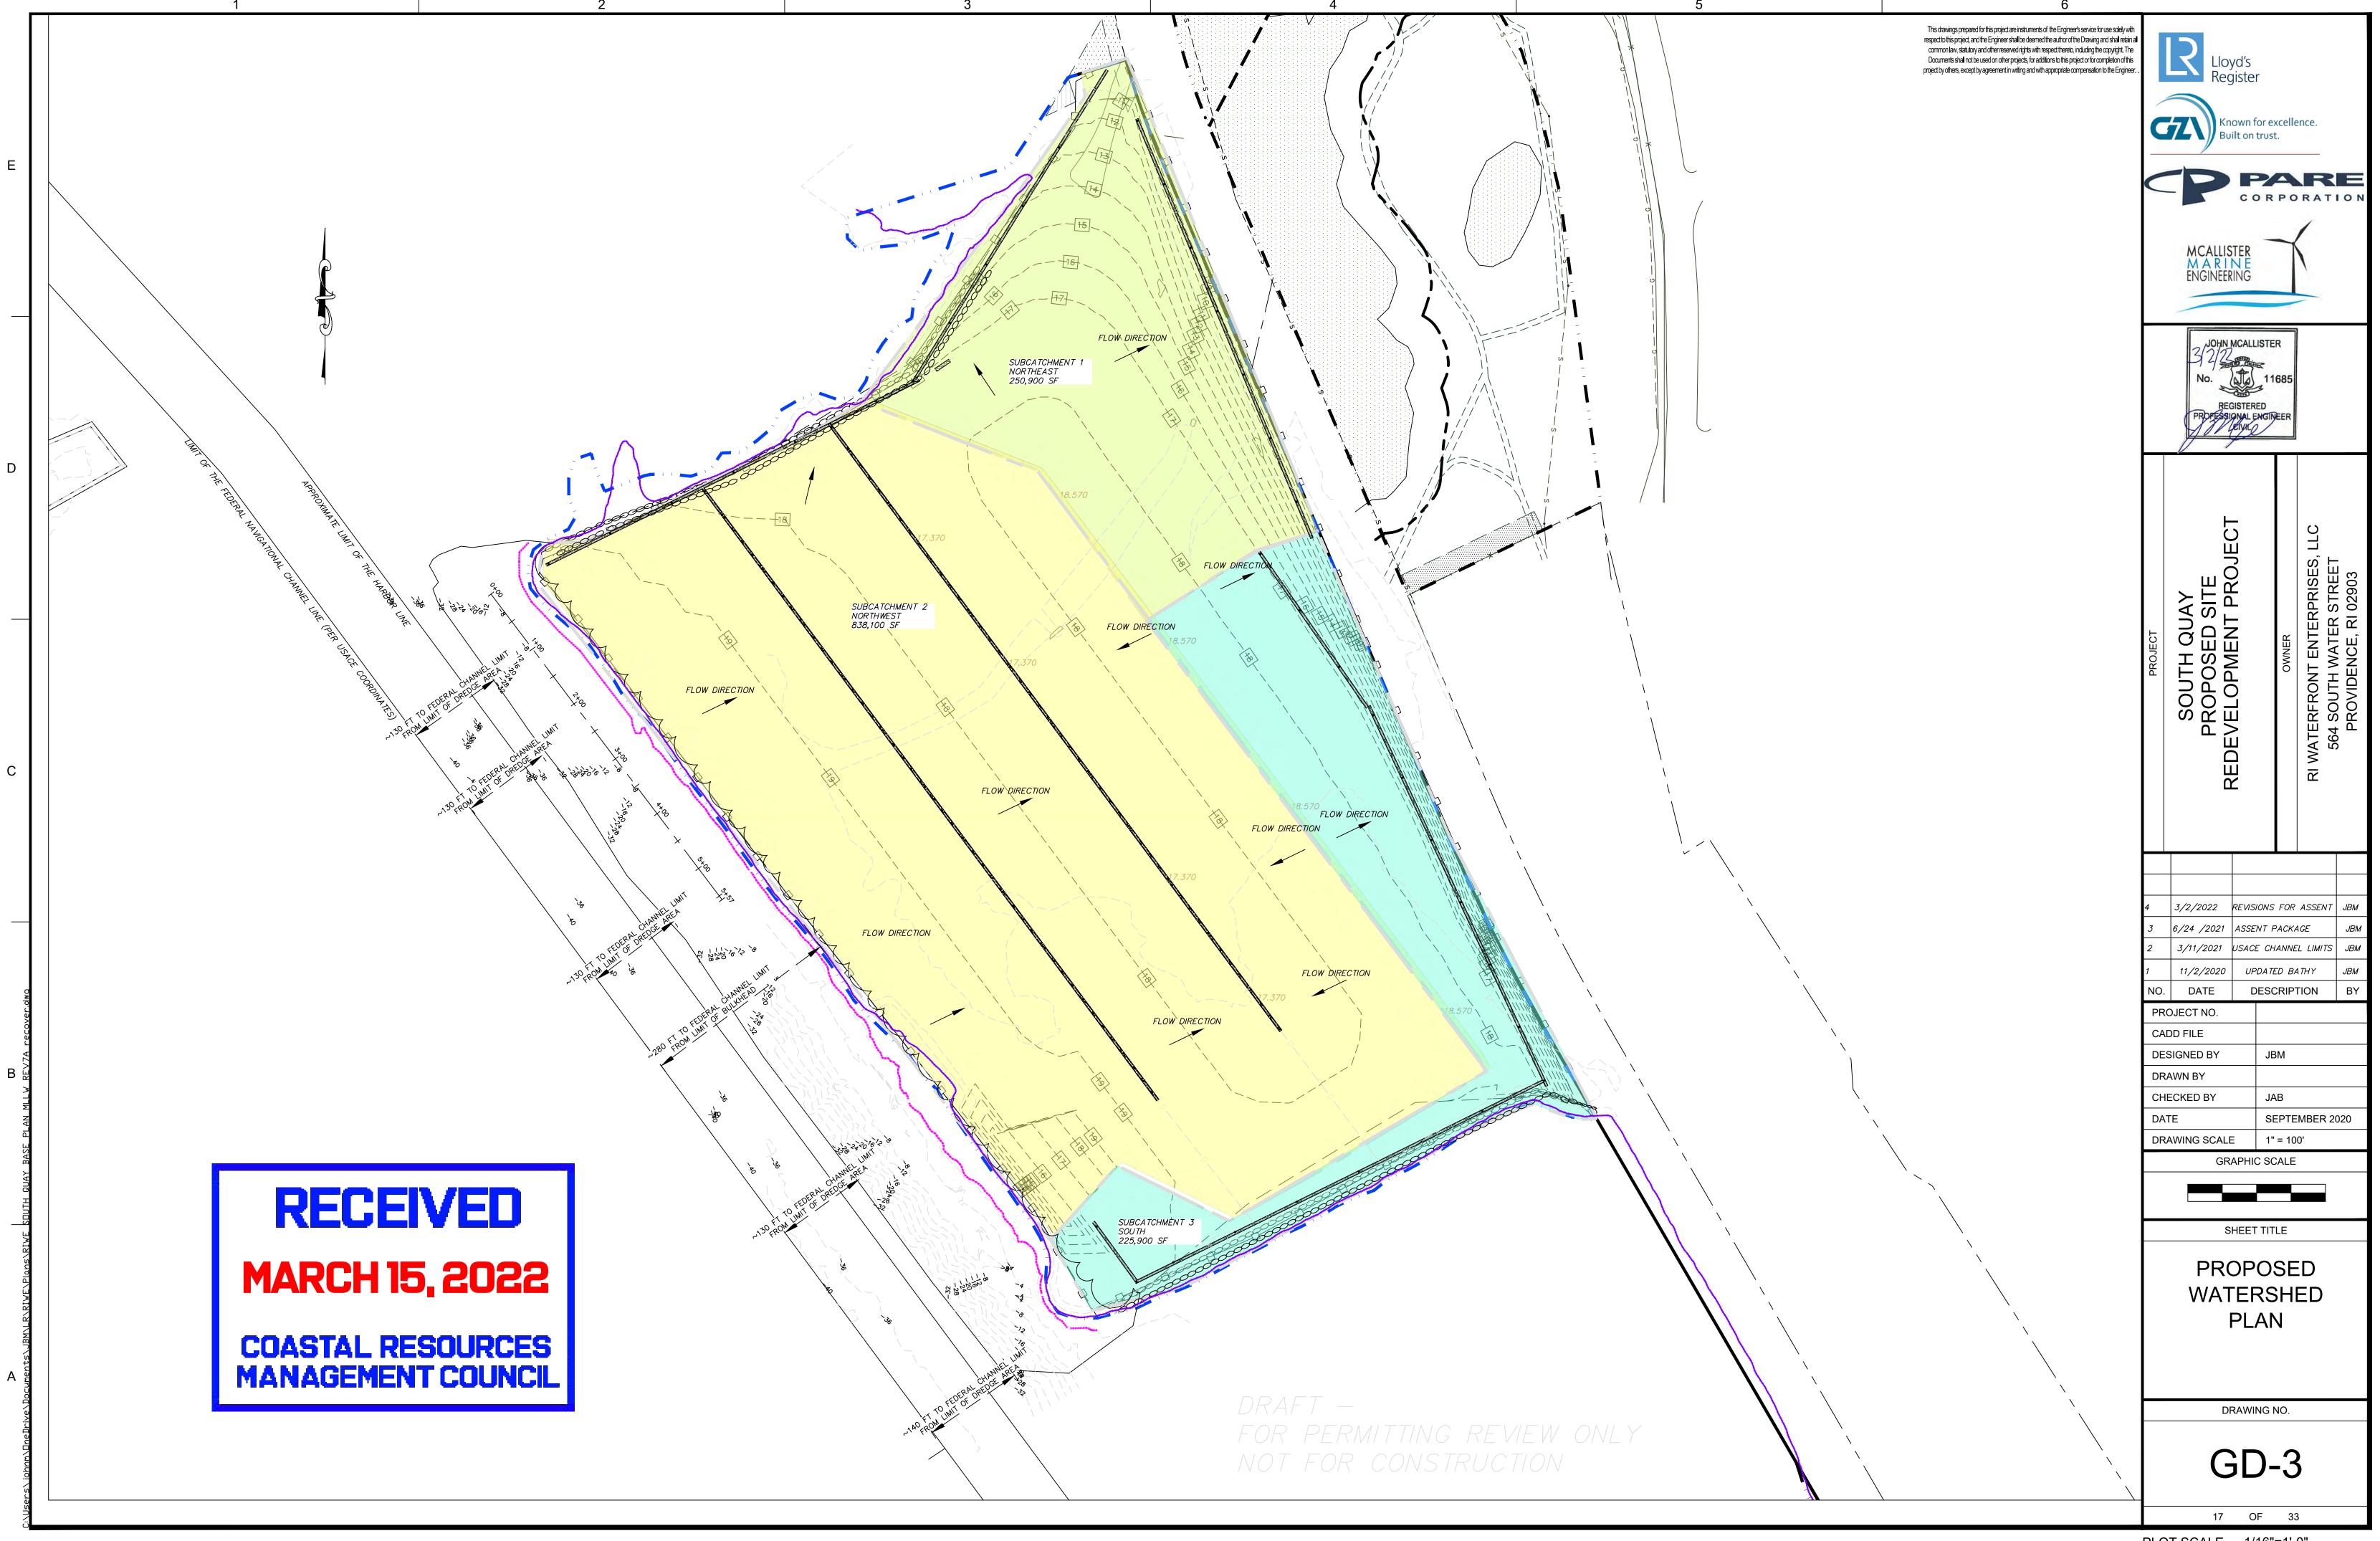


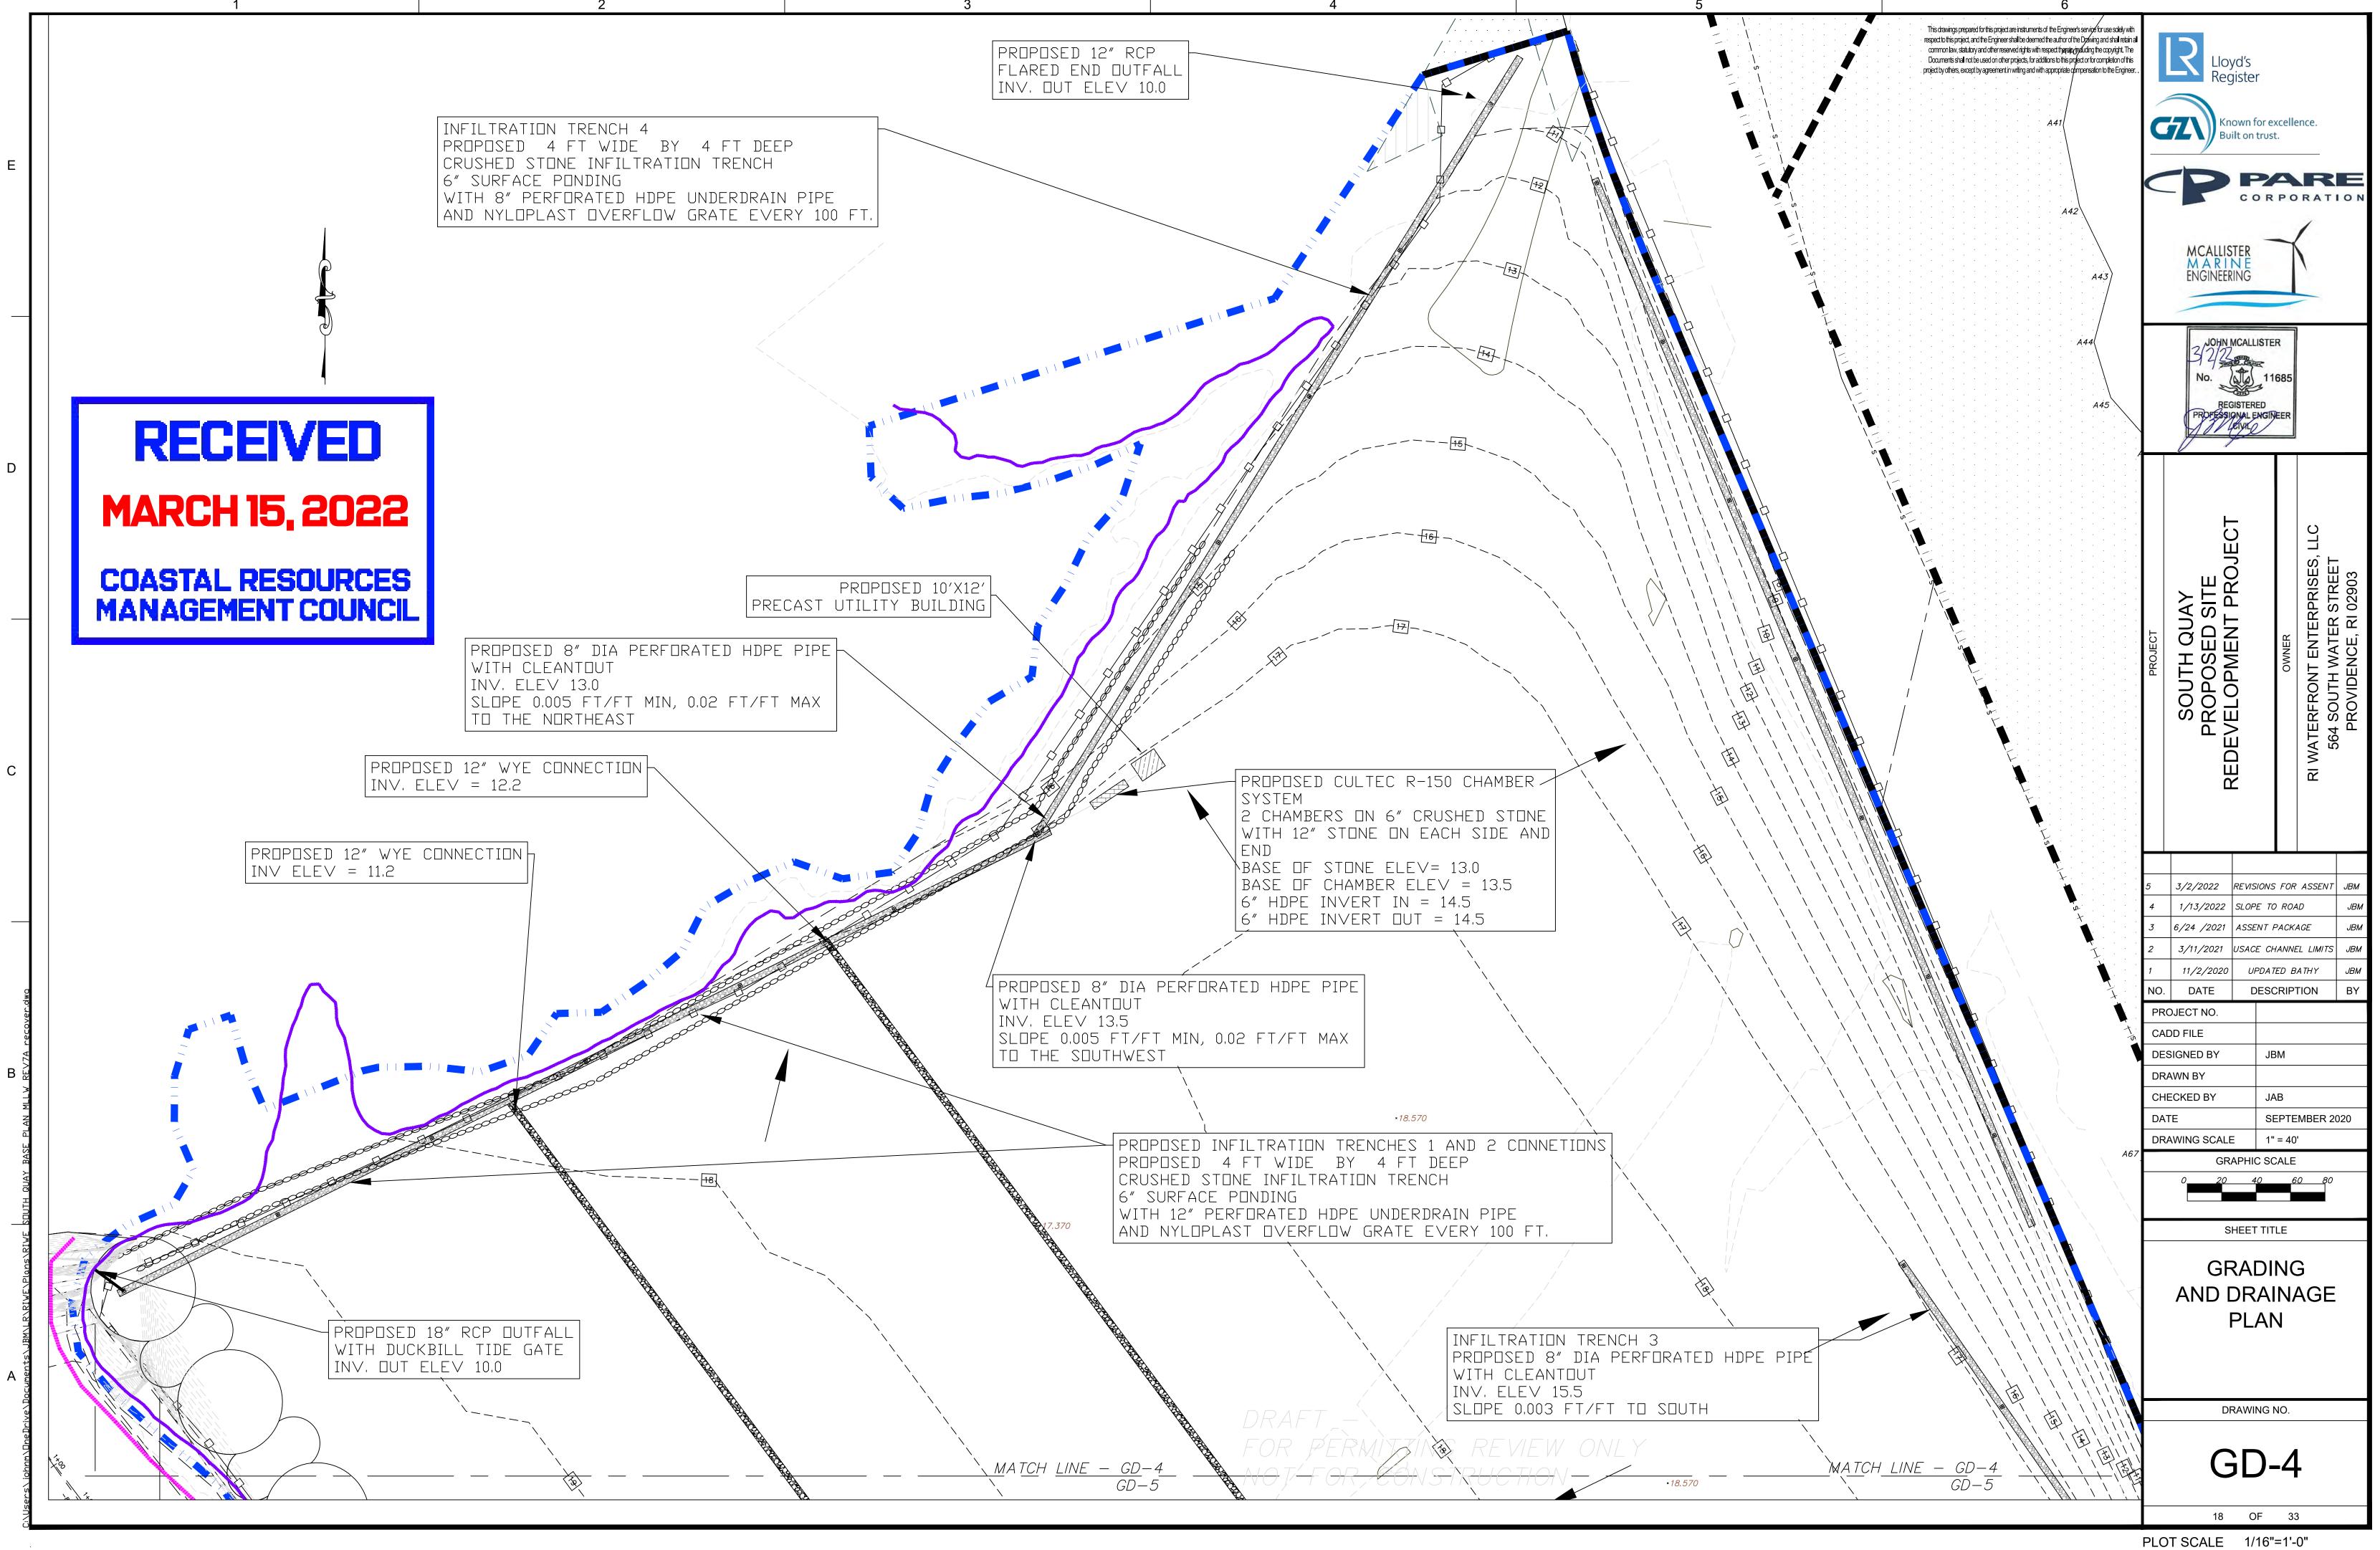

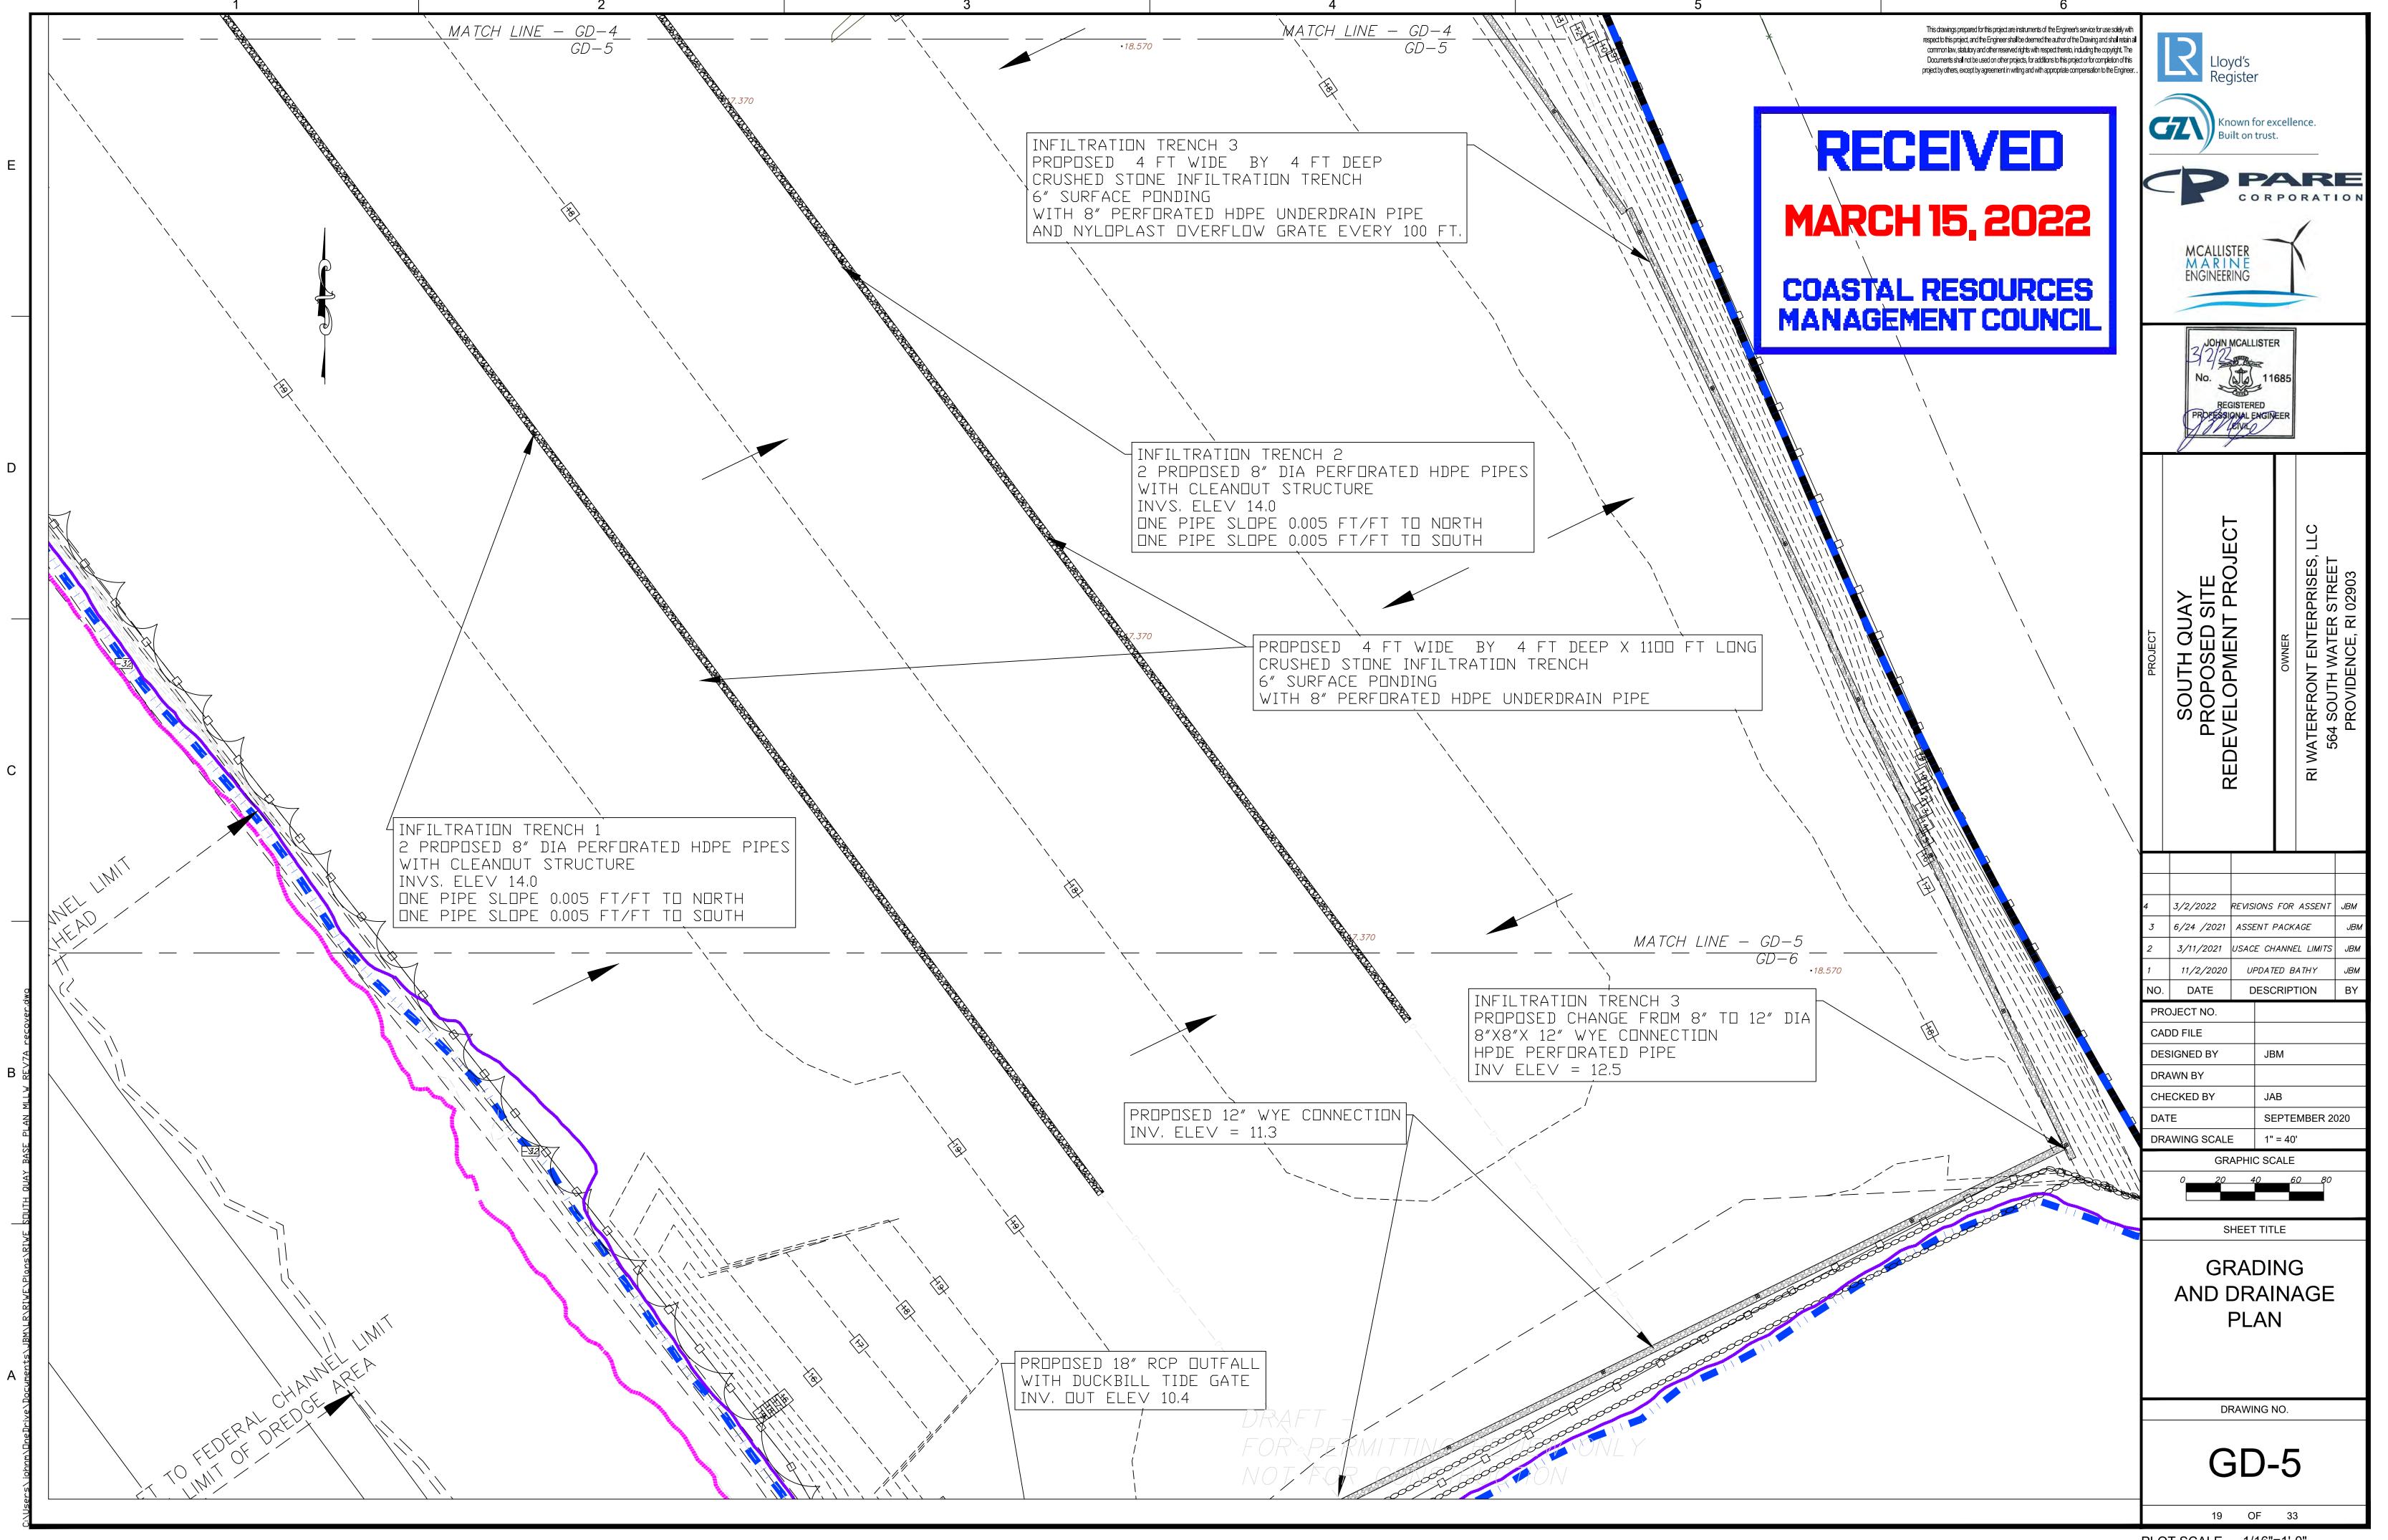

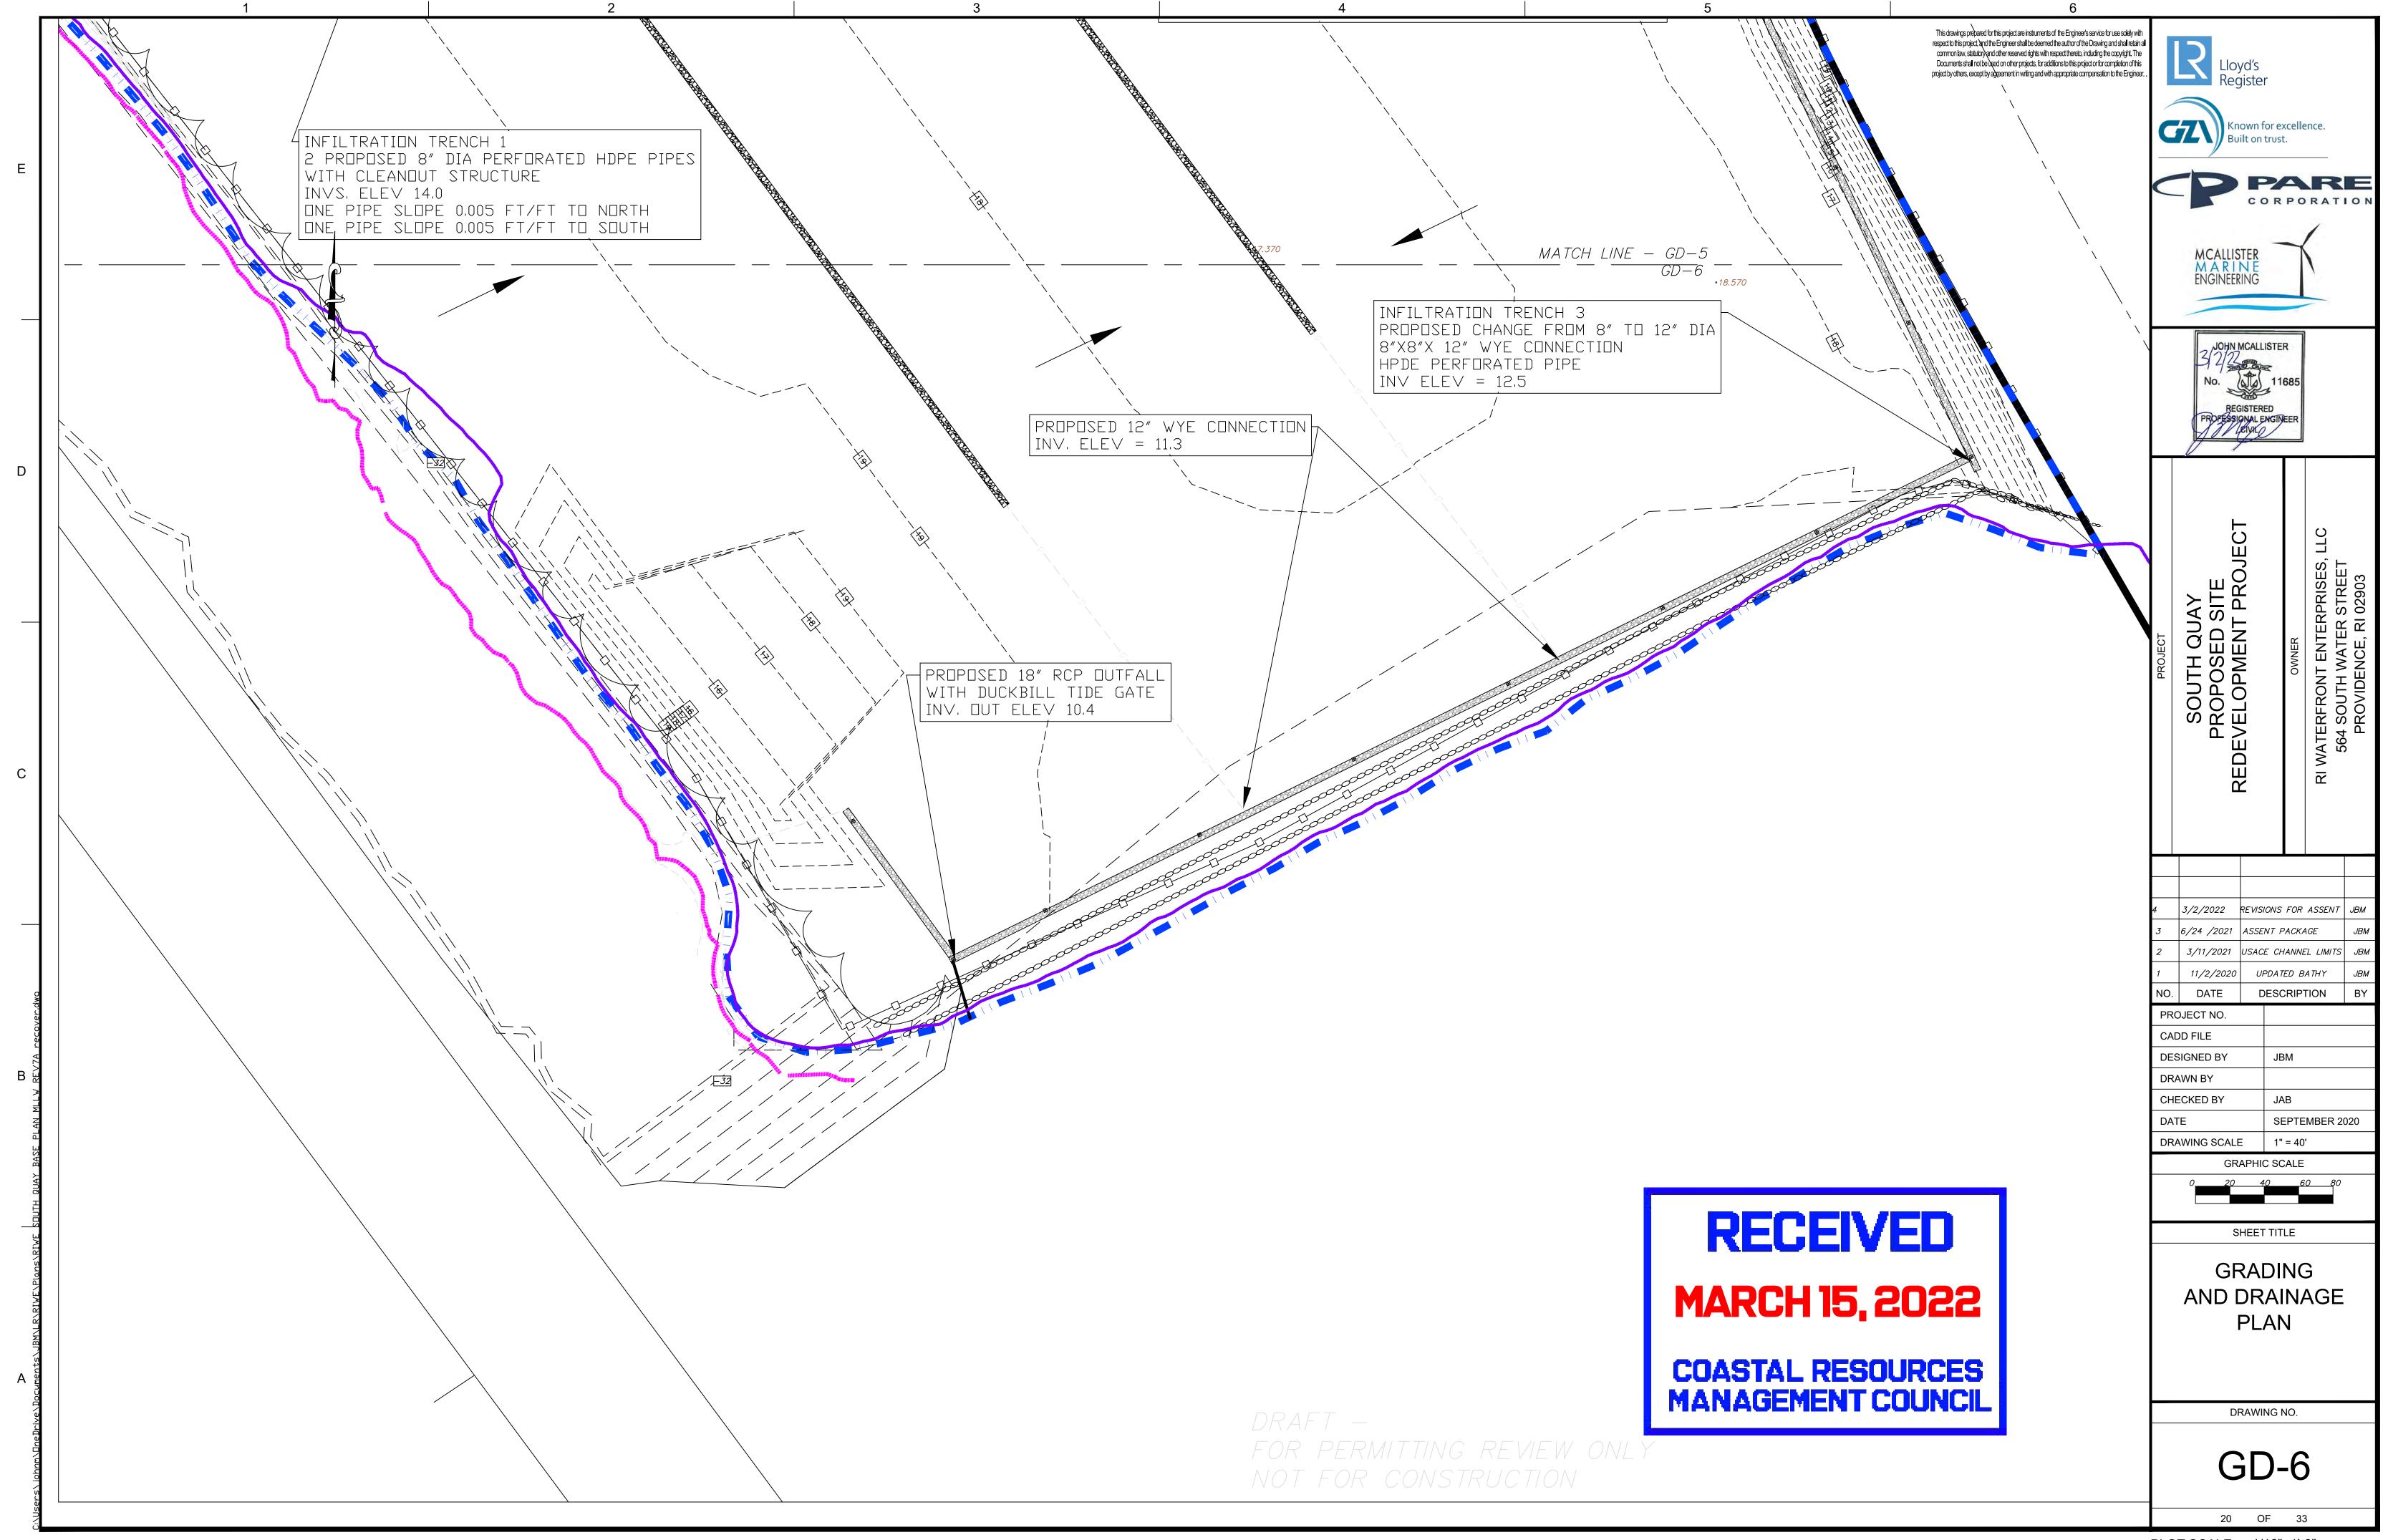


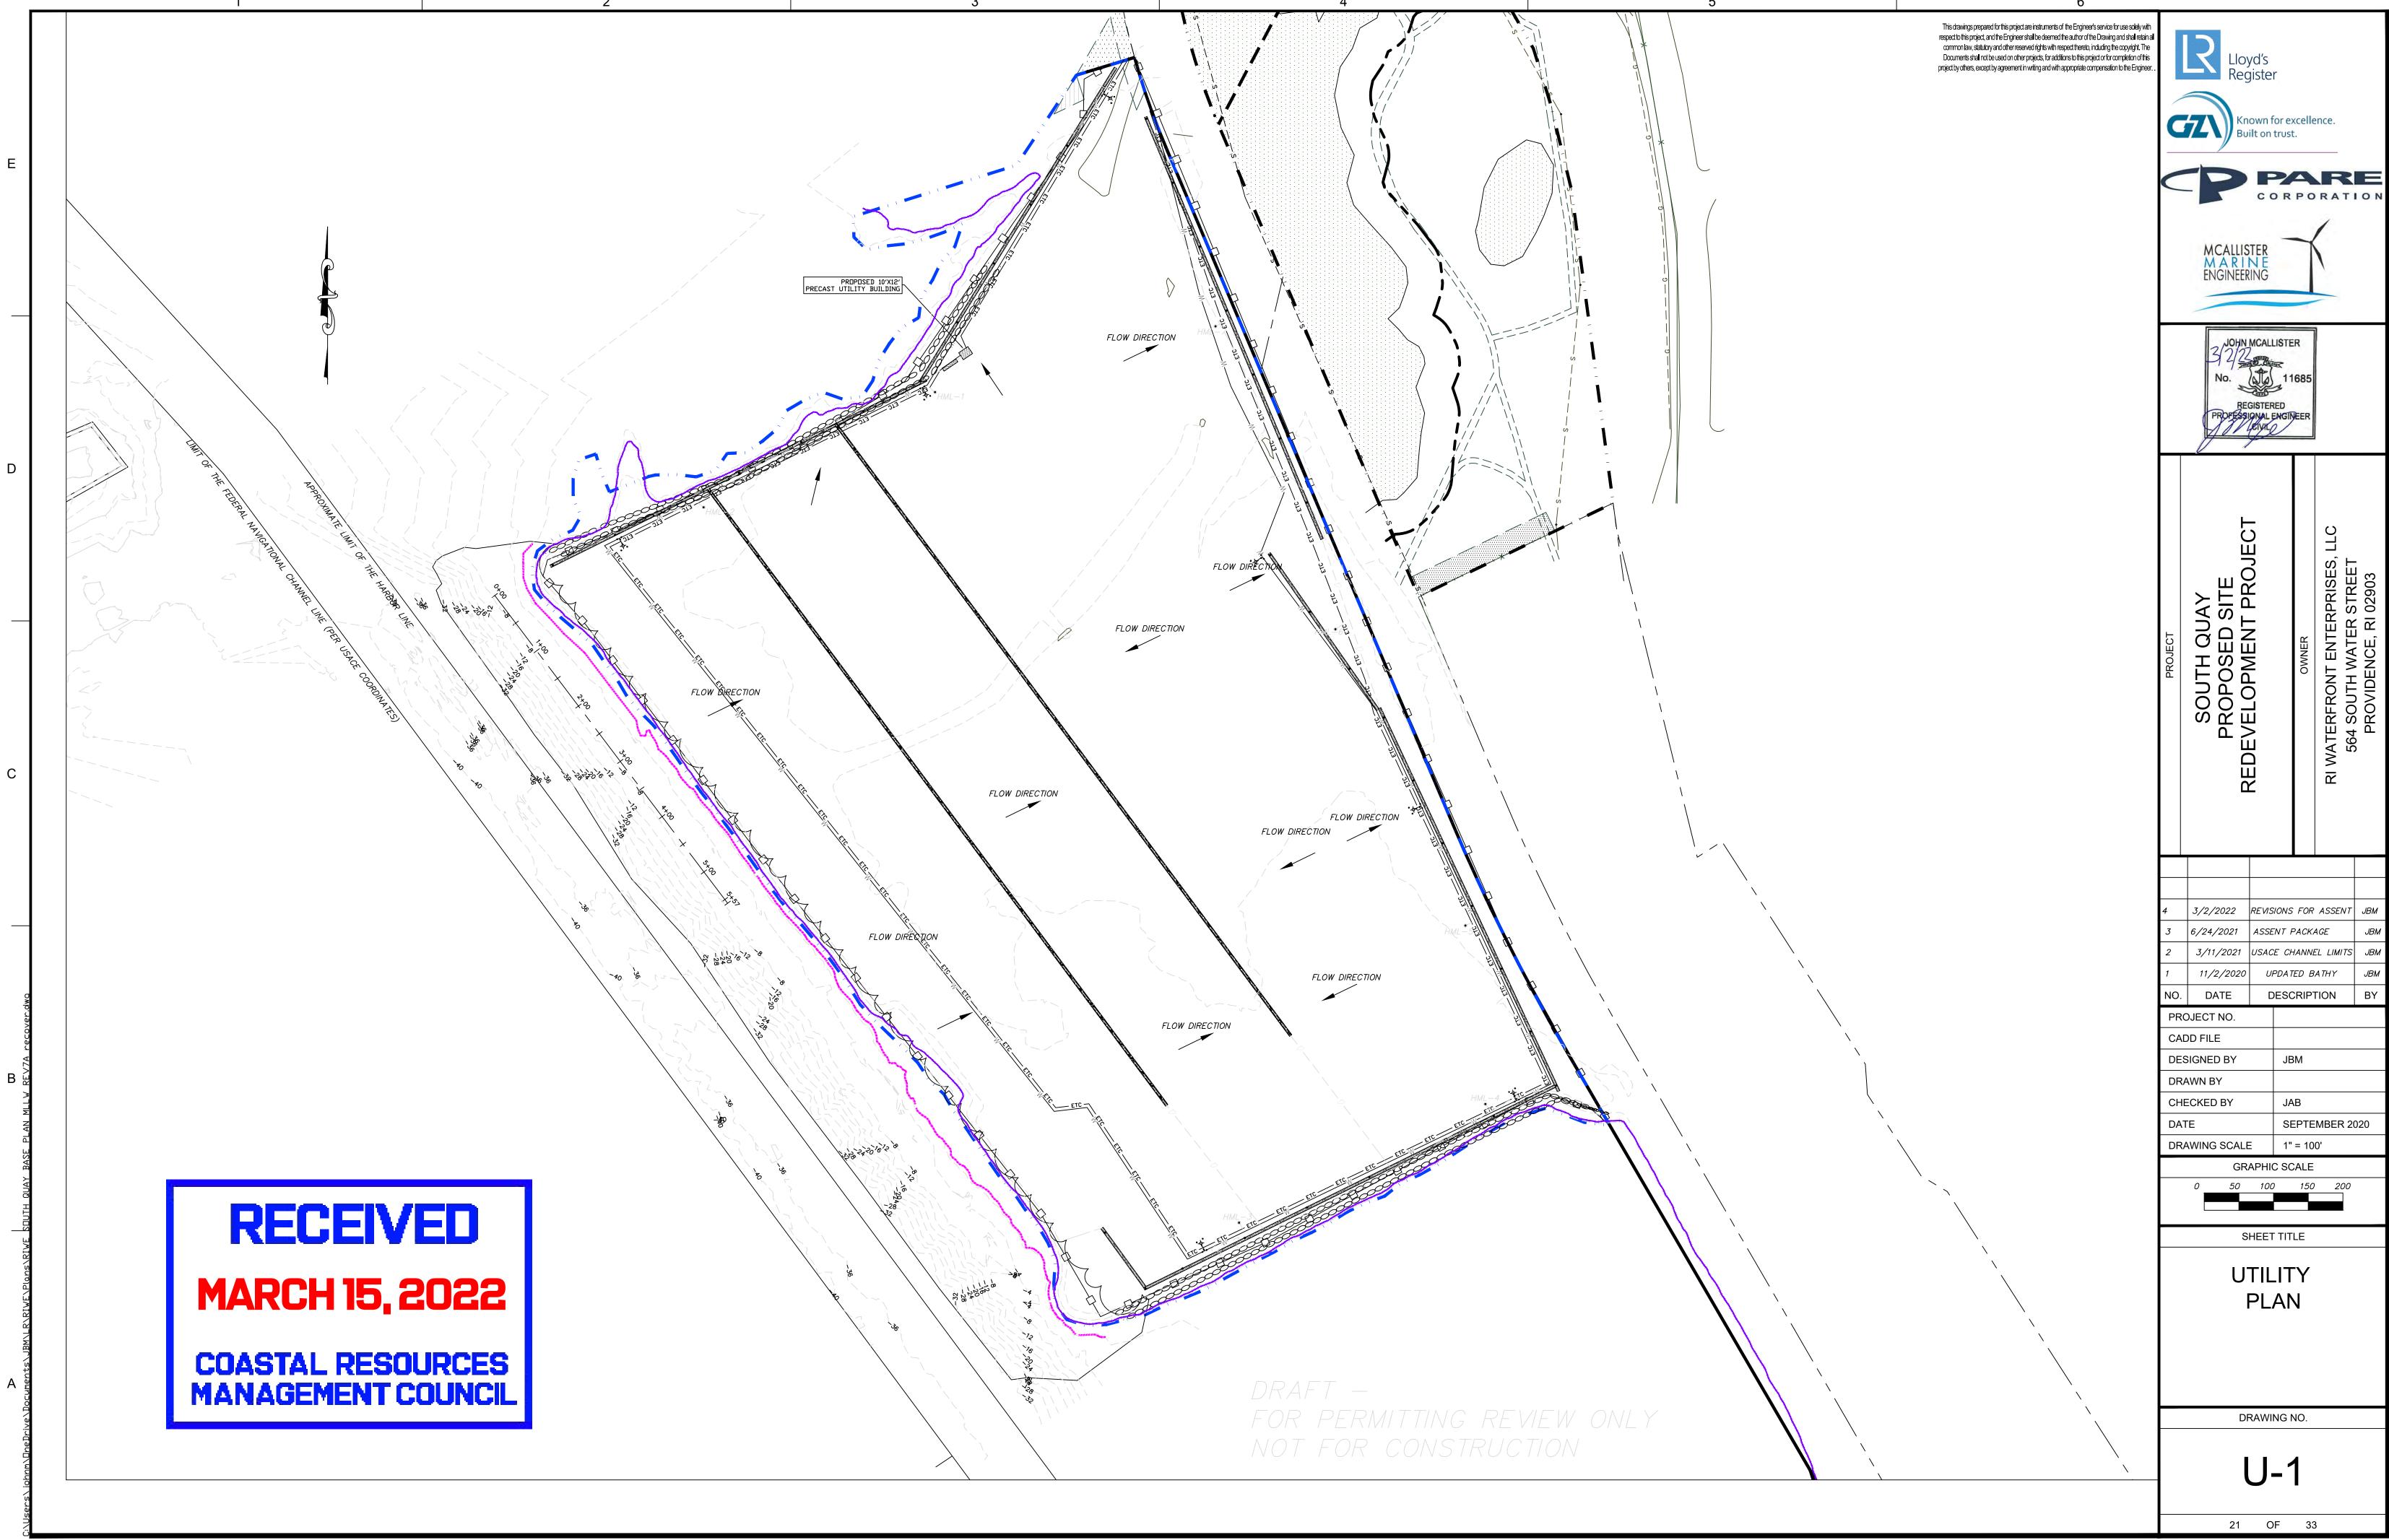


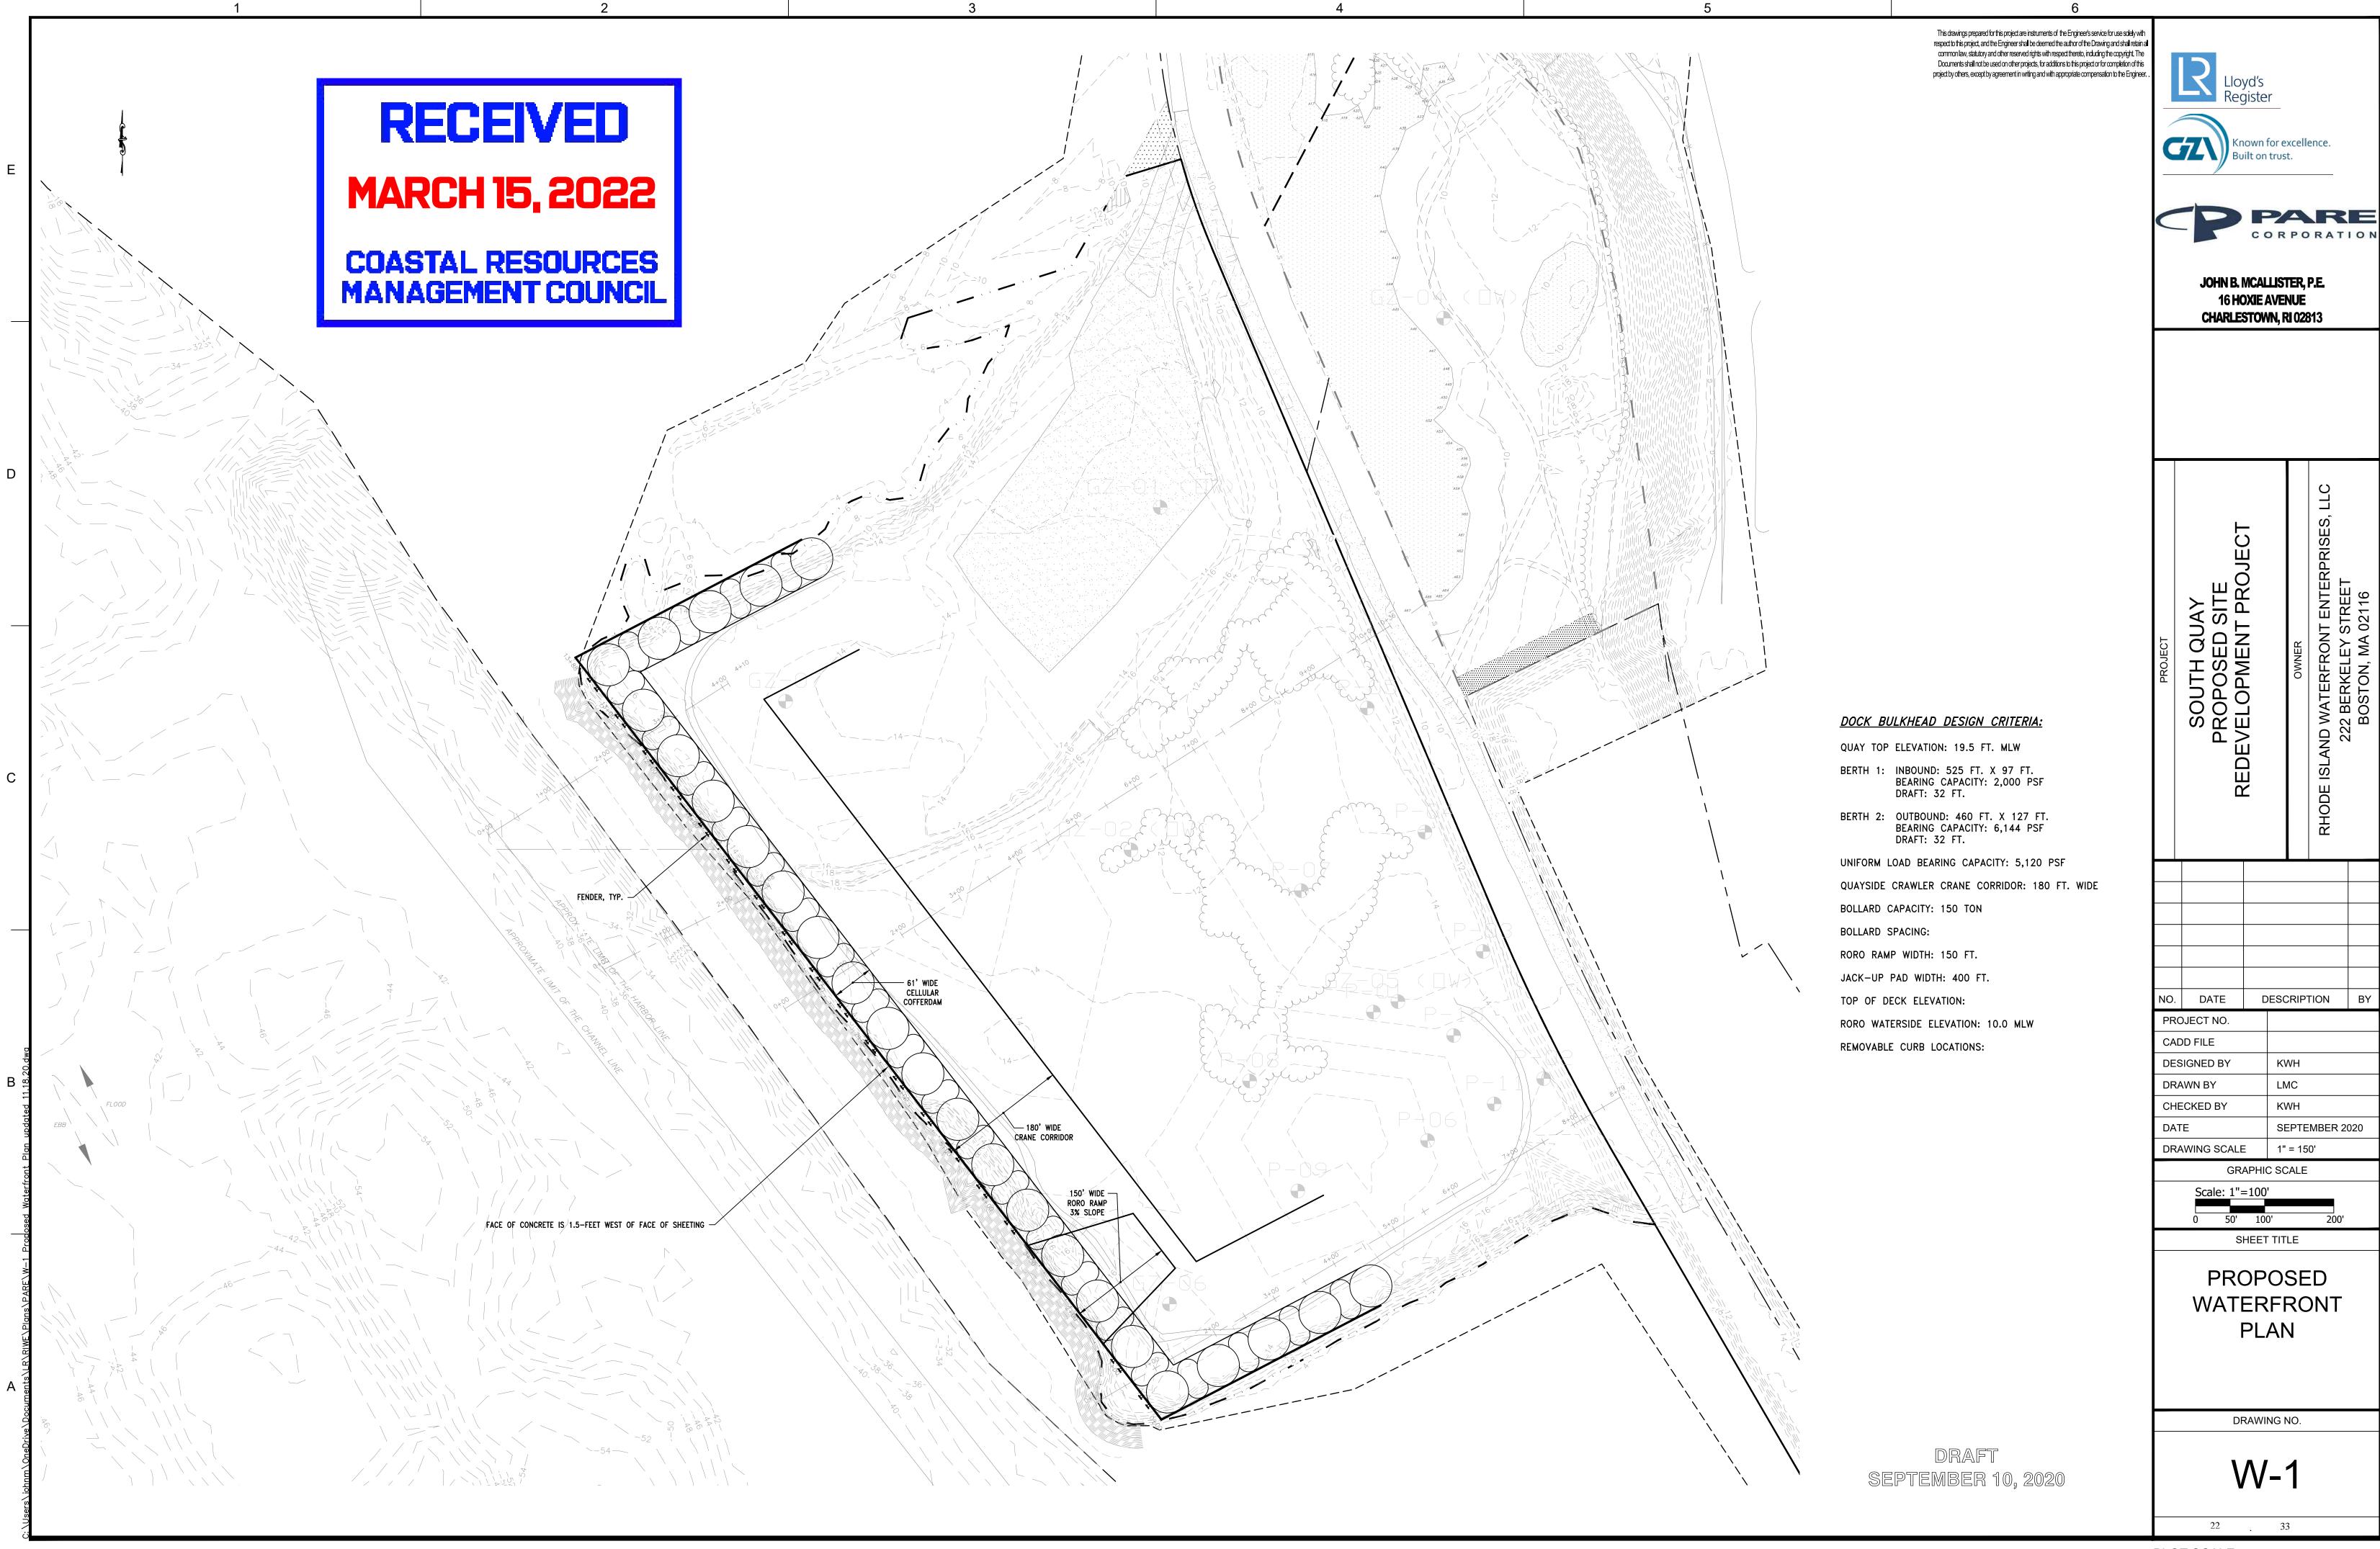



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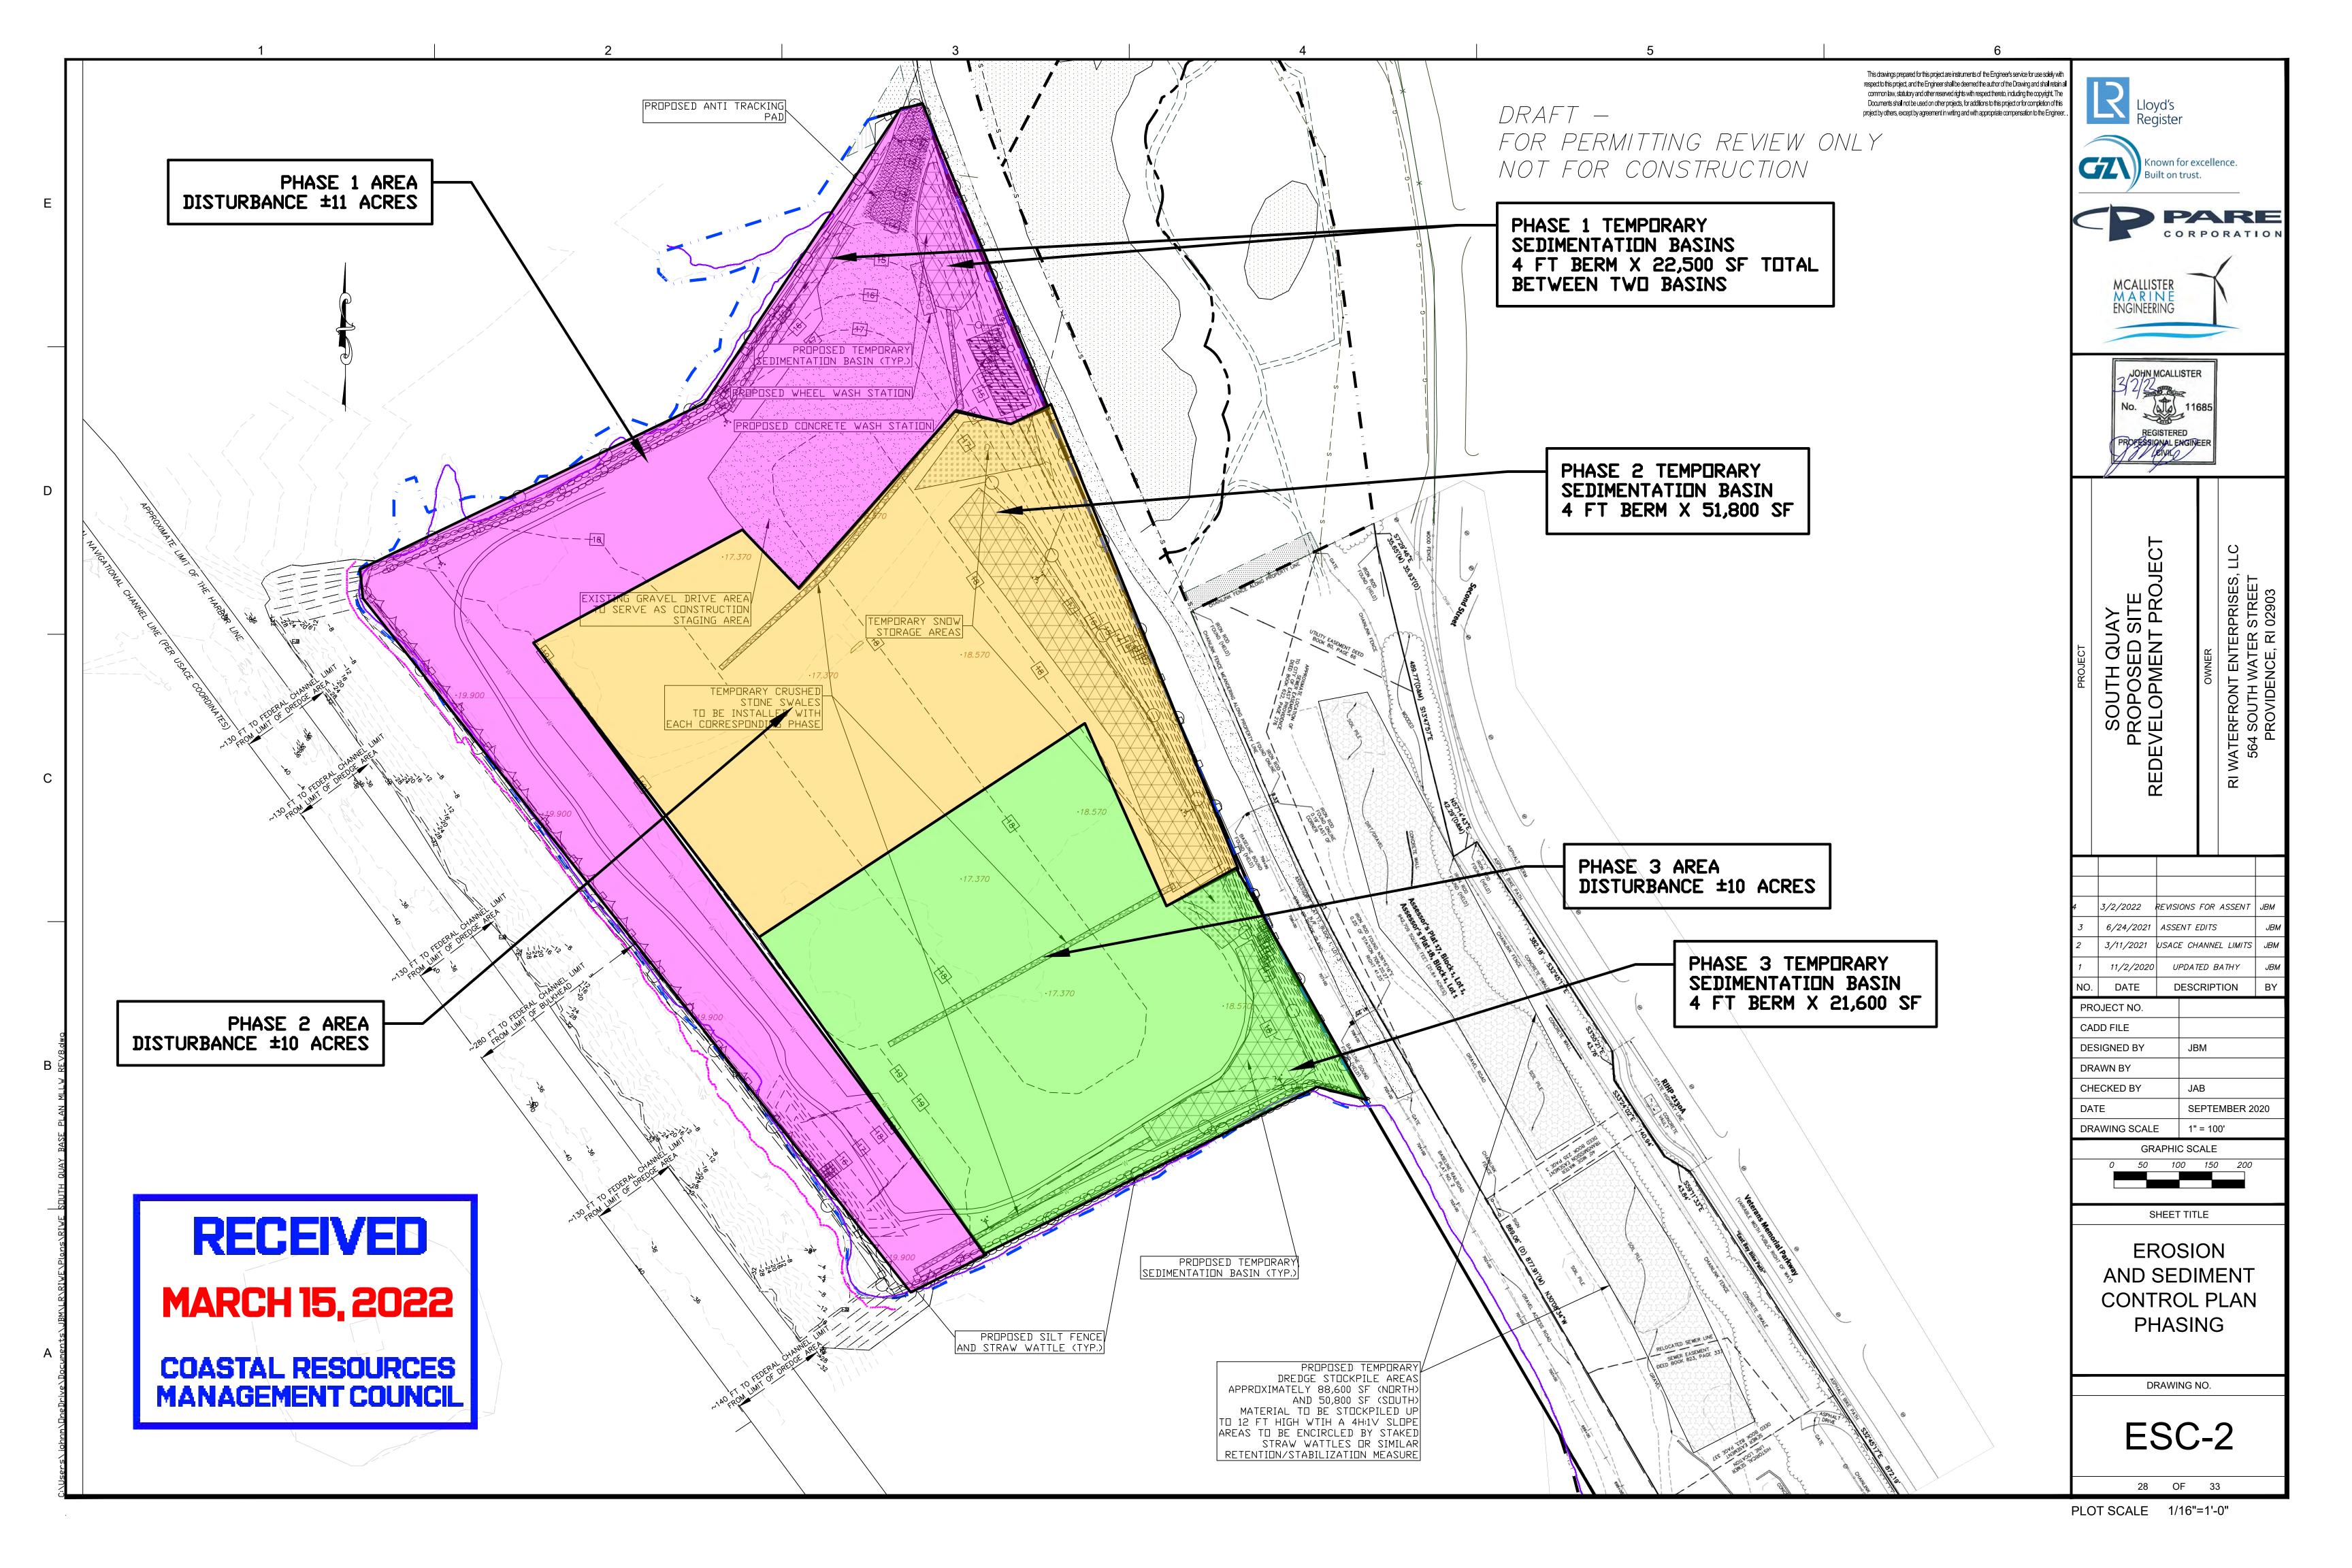
EL. 15.0 MLLW EL. 0.0 QUAYSIDE TO HARBOR LINE = 300'± -10FACE OF STEEL SHEET PILE CELL -INSIDE FACE OF STEEL SHEET PILE CELL --30 DREDGE DEPTH EL. -34.0 (TO BE FURTHER EVALUATED AS DESIGN DEVELOPS) -40 DATE DESCRIPTION PROJECT NO. 60 200 60 CADD FILE **DESIGNED BY** KWH DRAWN BY LMC CHECKED BY DATE SEPTEMBER 2020 DRAWING SCALE 1" = 150' **GRAPHIC SCALE** RECEIVED MARCH 15, 2022 PROPOSED WATERFRONT SECTION COASTAL RESOURCES
MANAGEMENT COUNCIL DRAWING NO. W-2



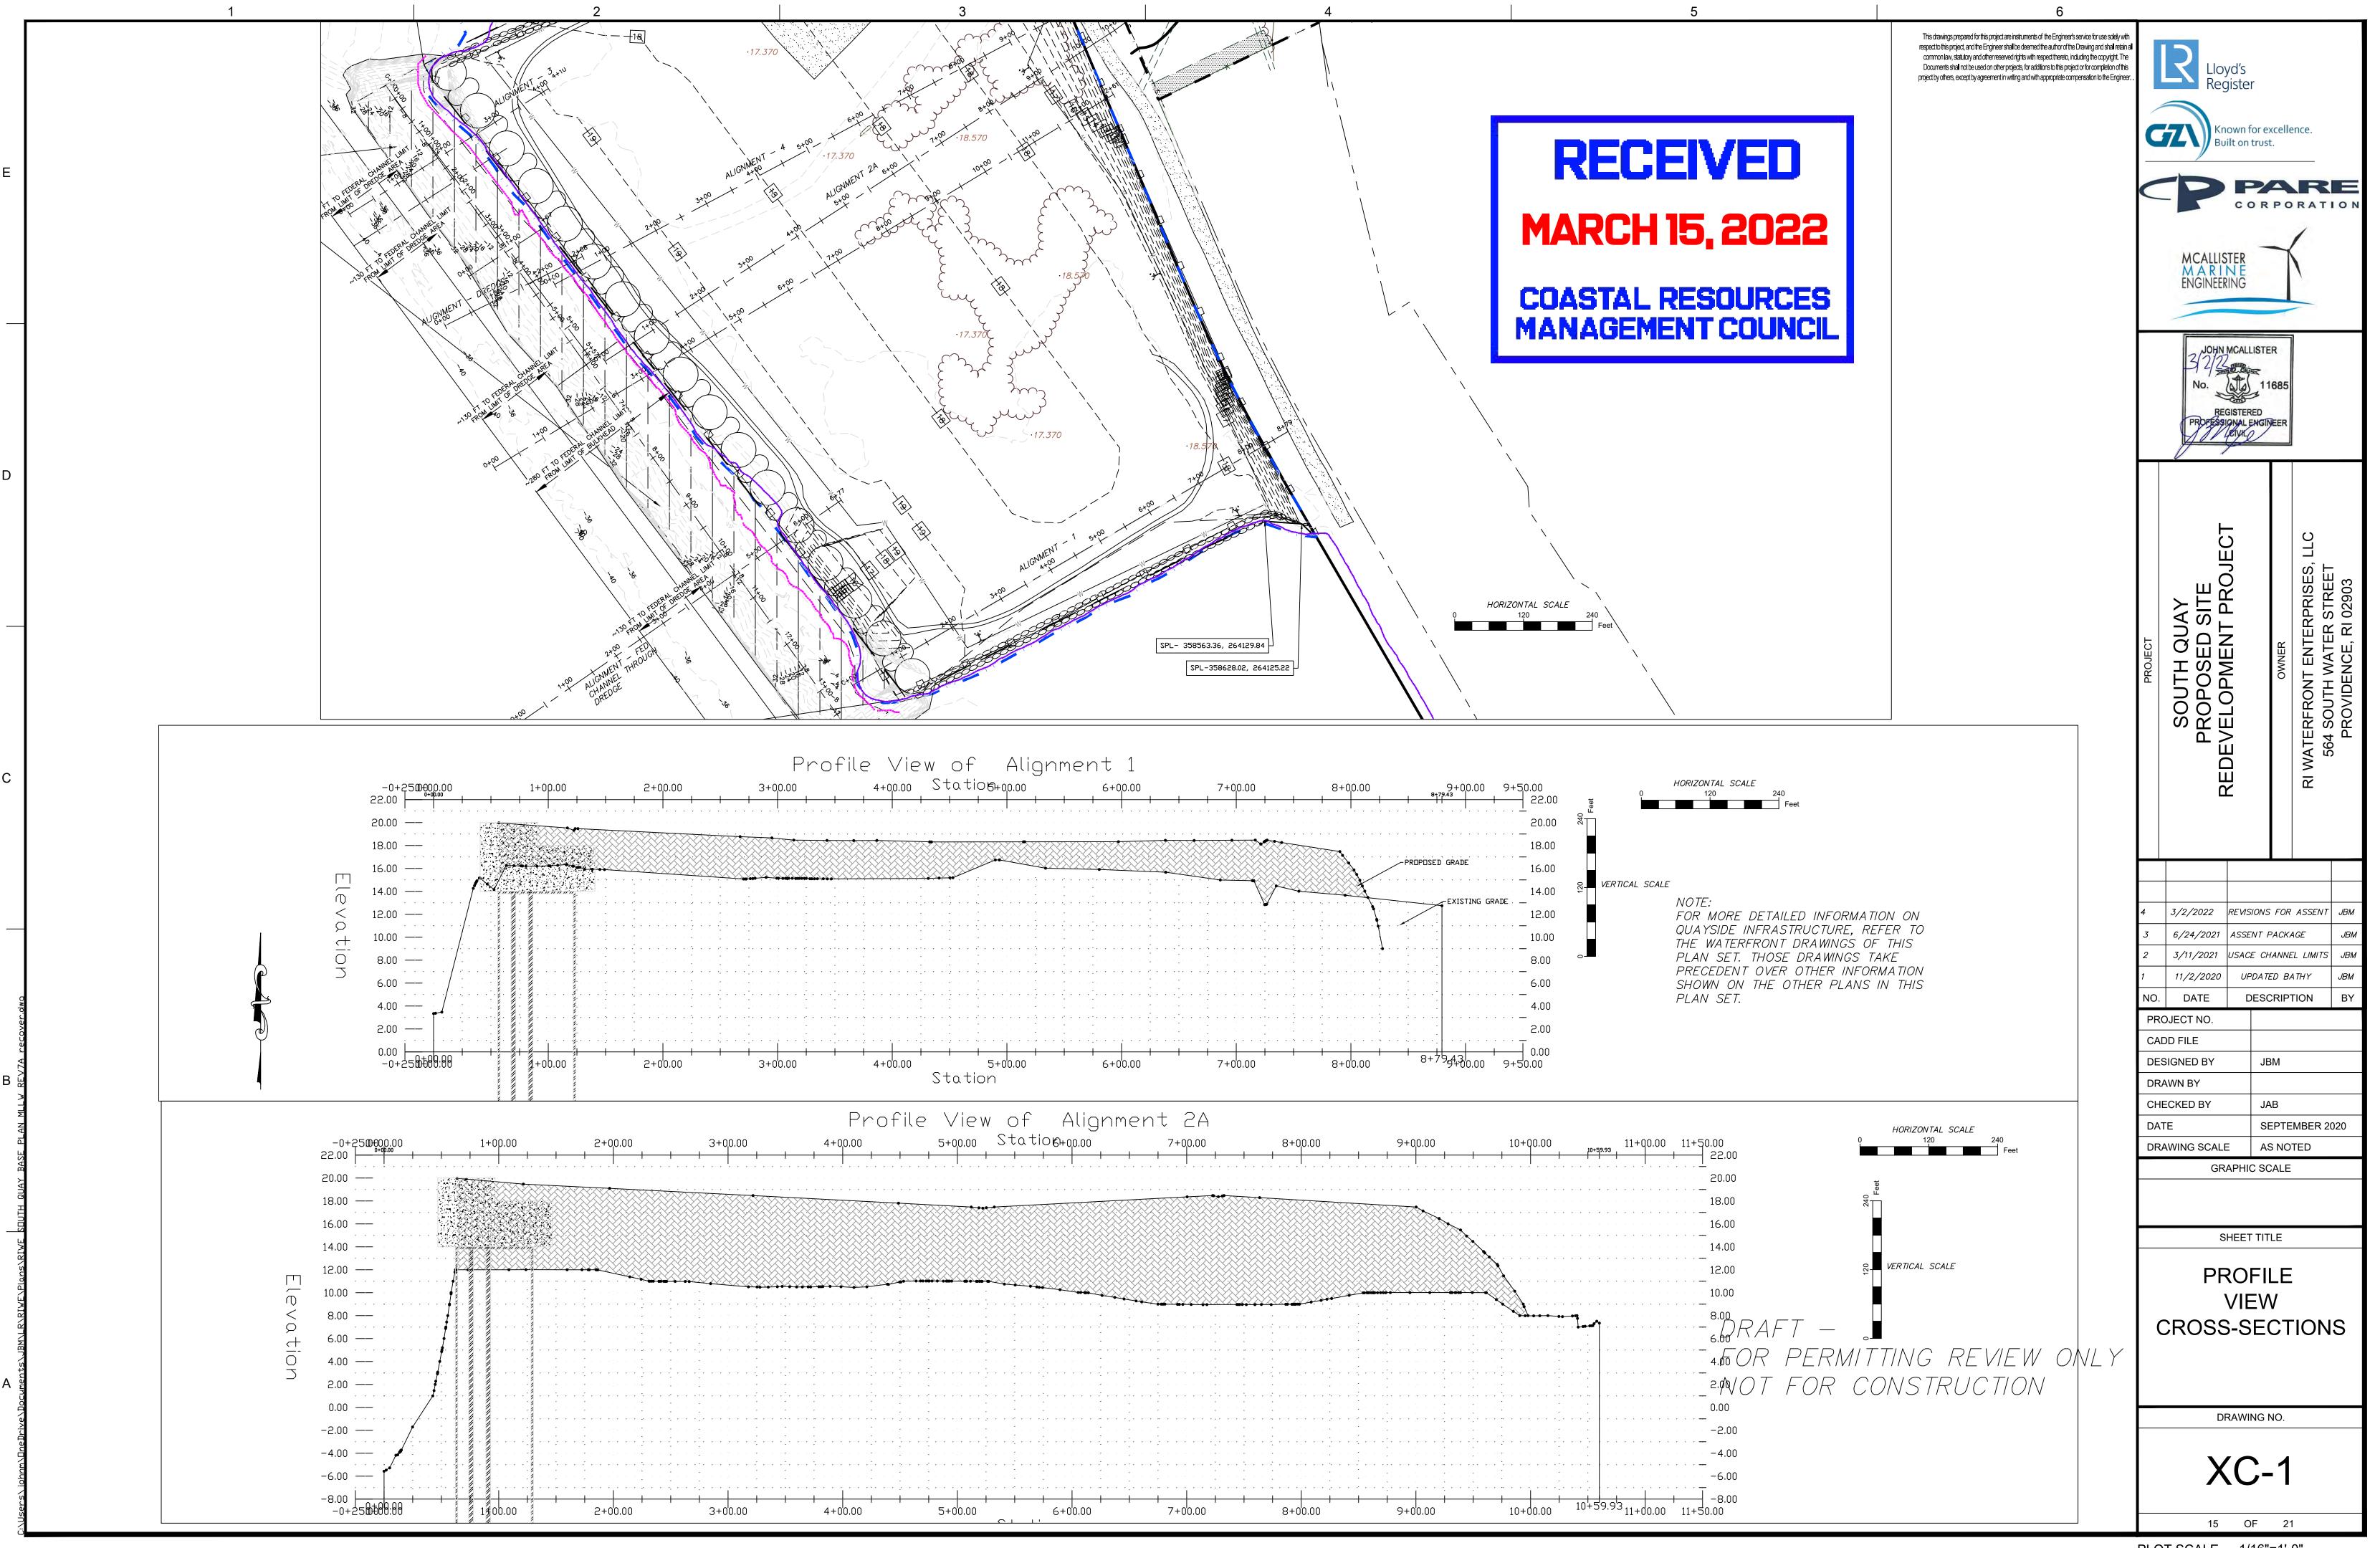

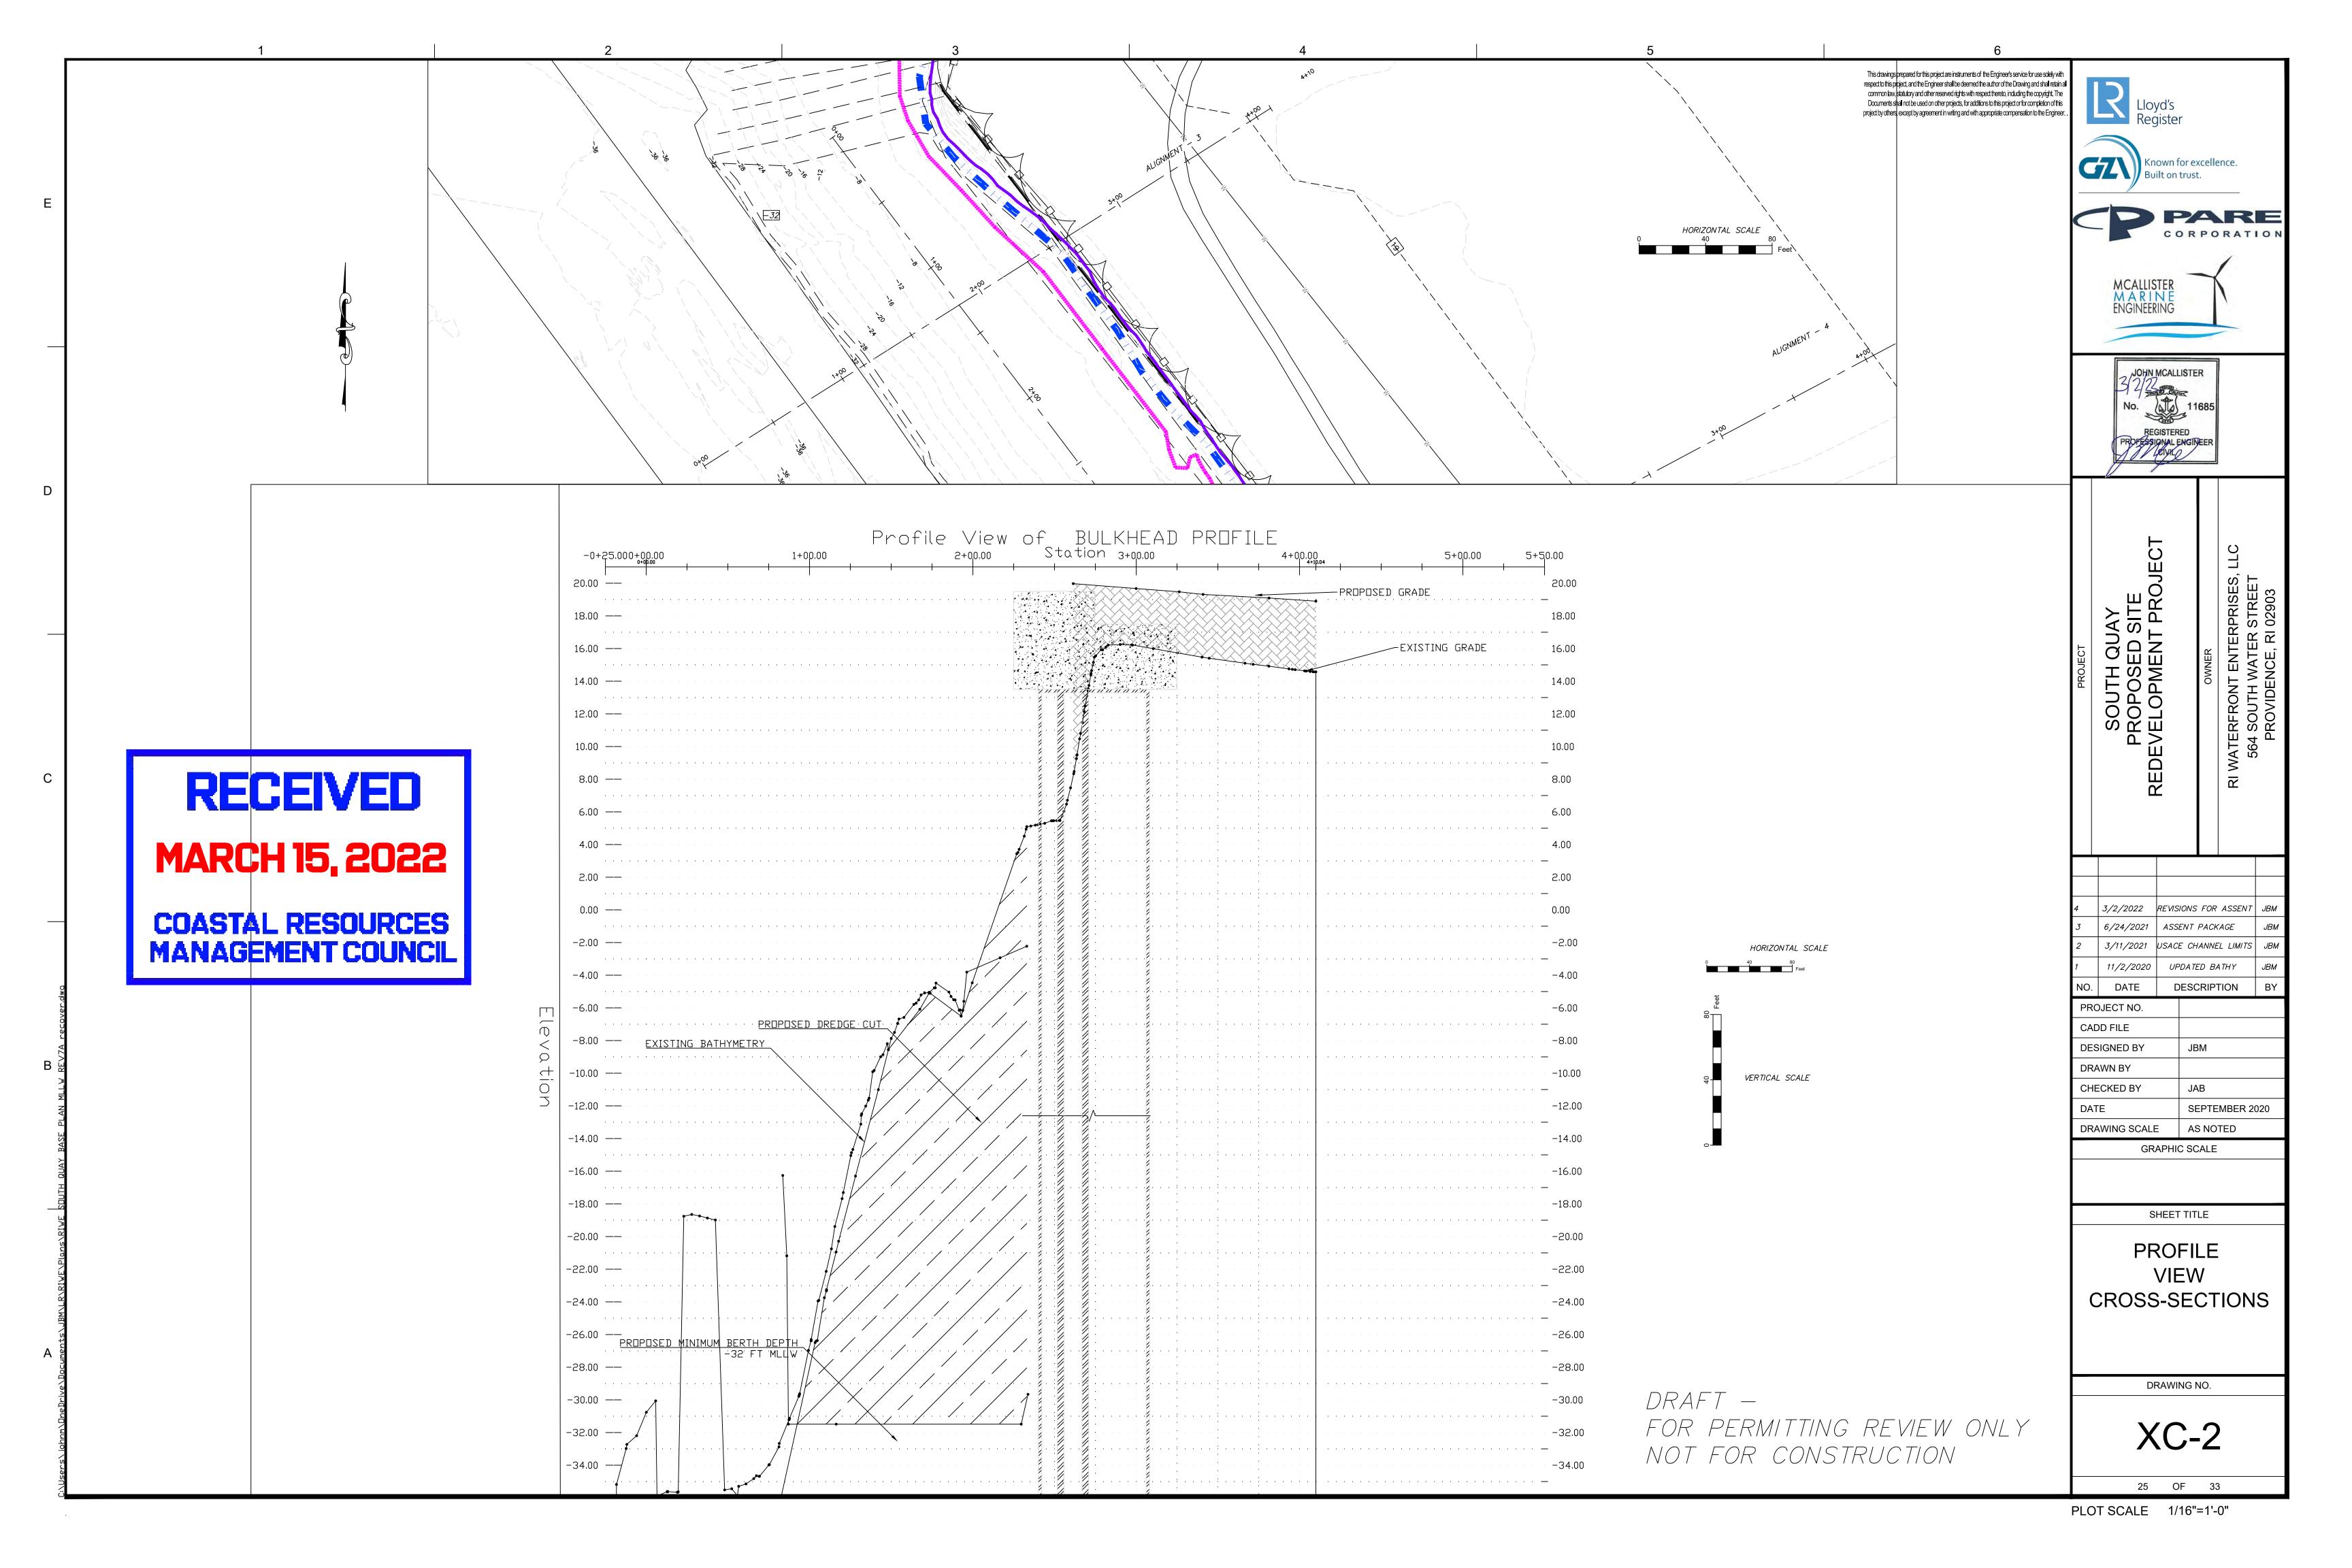


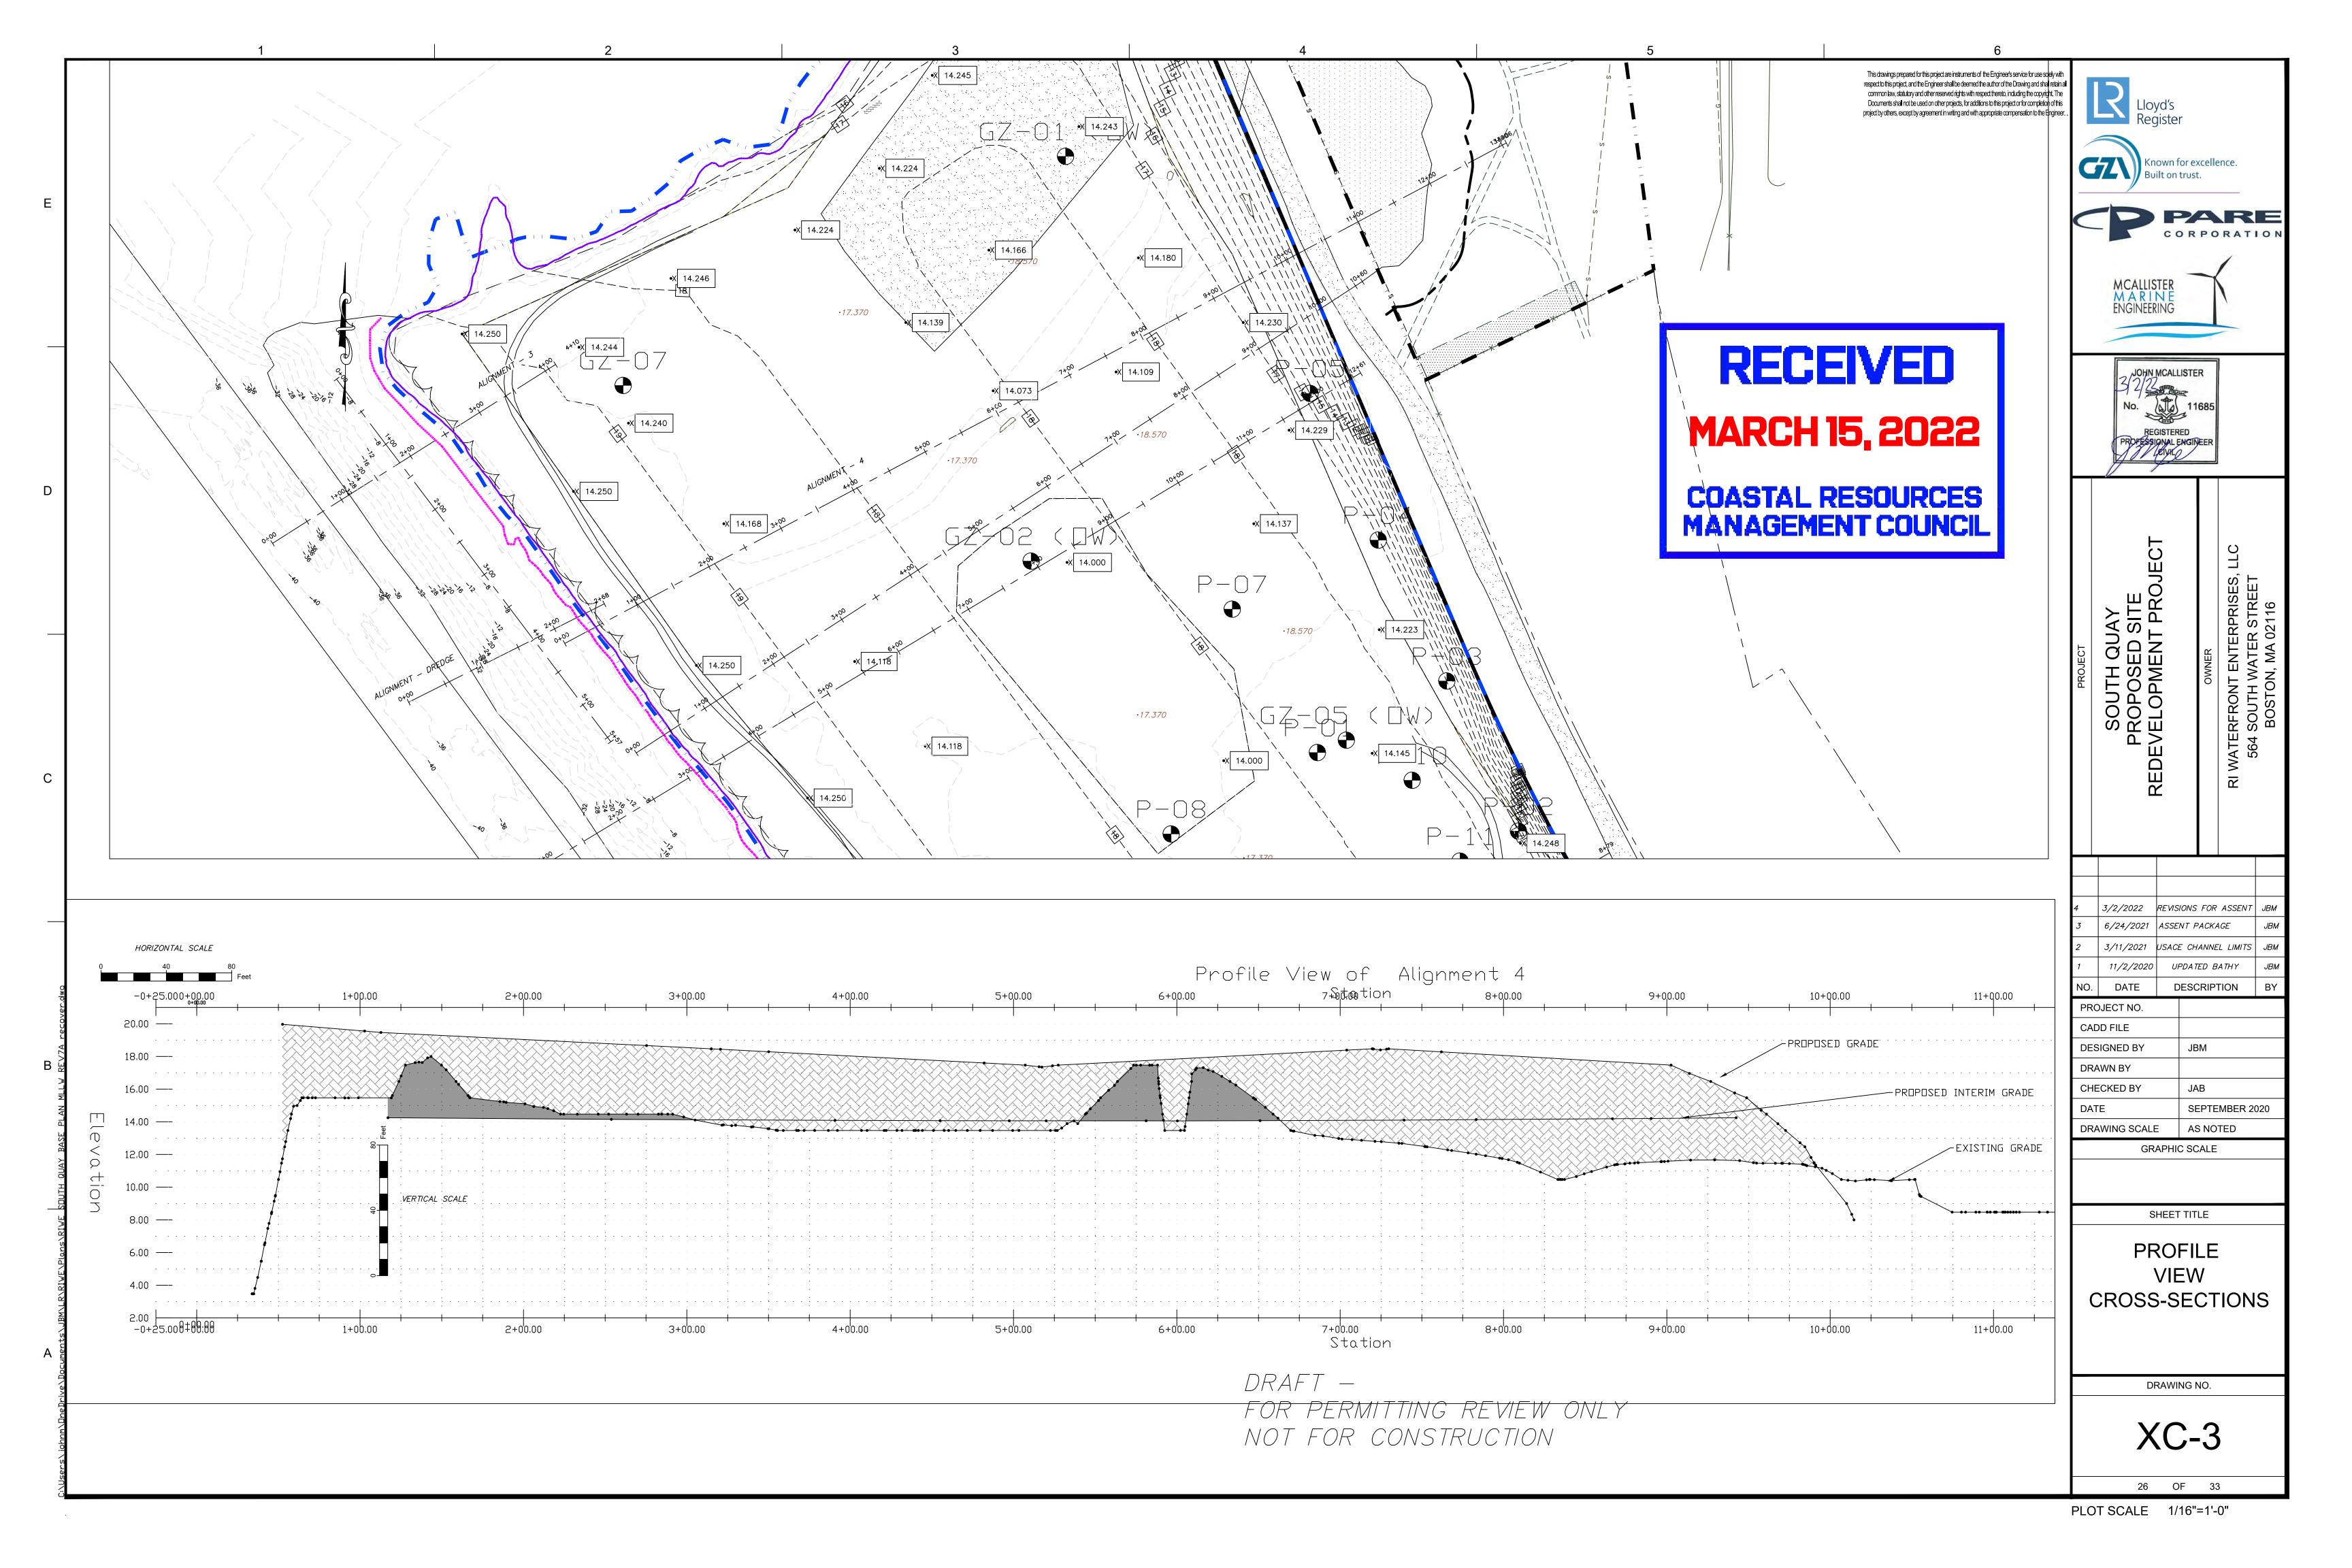

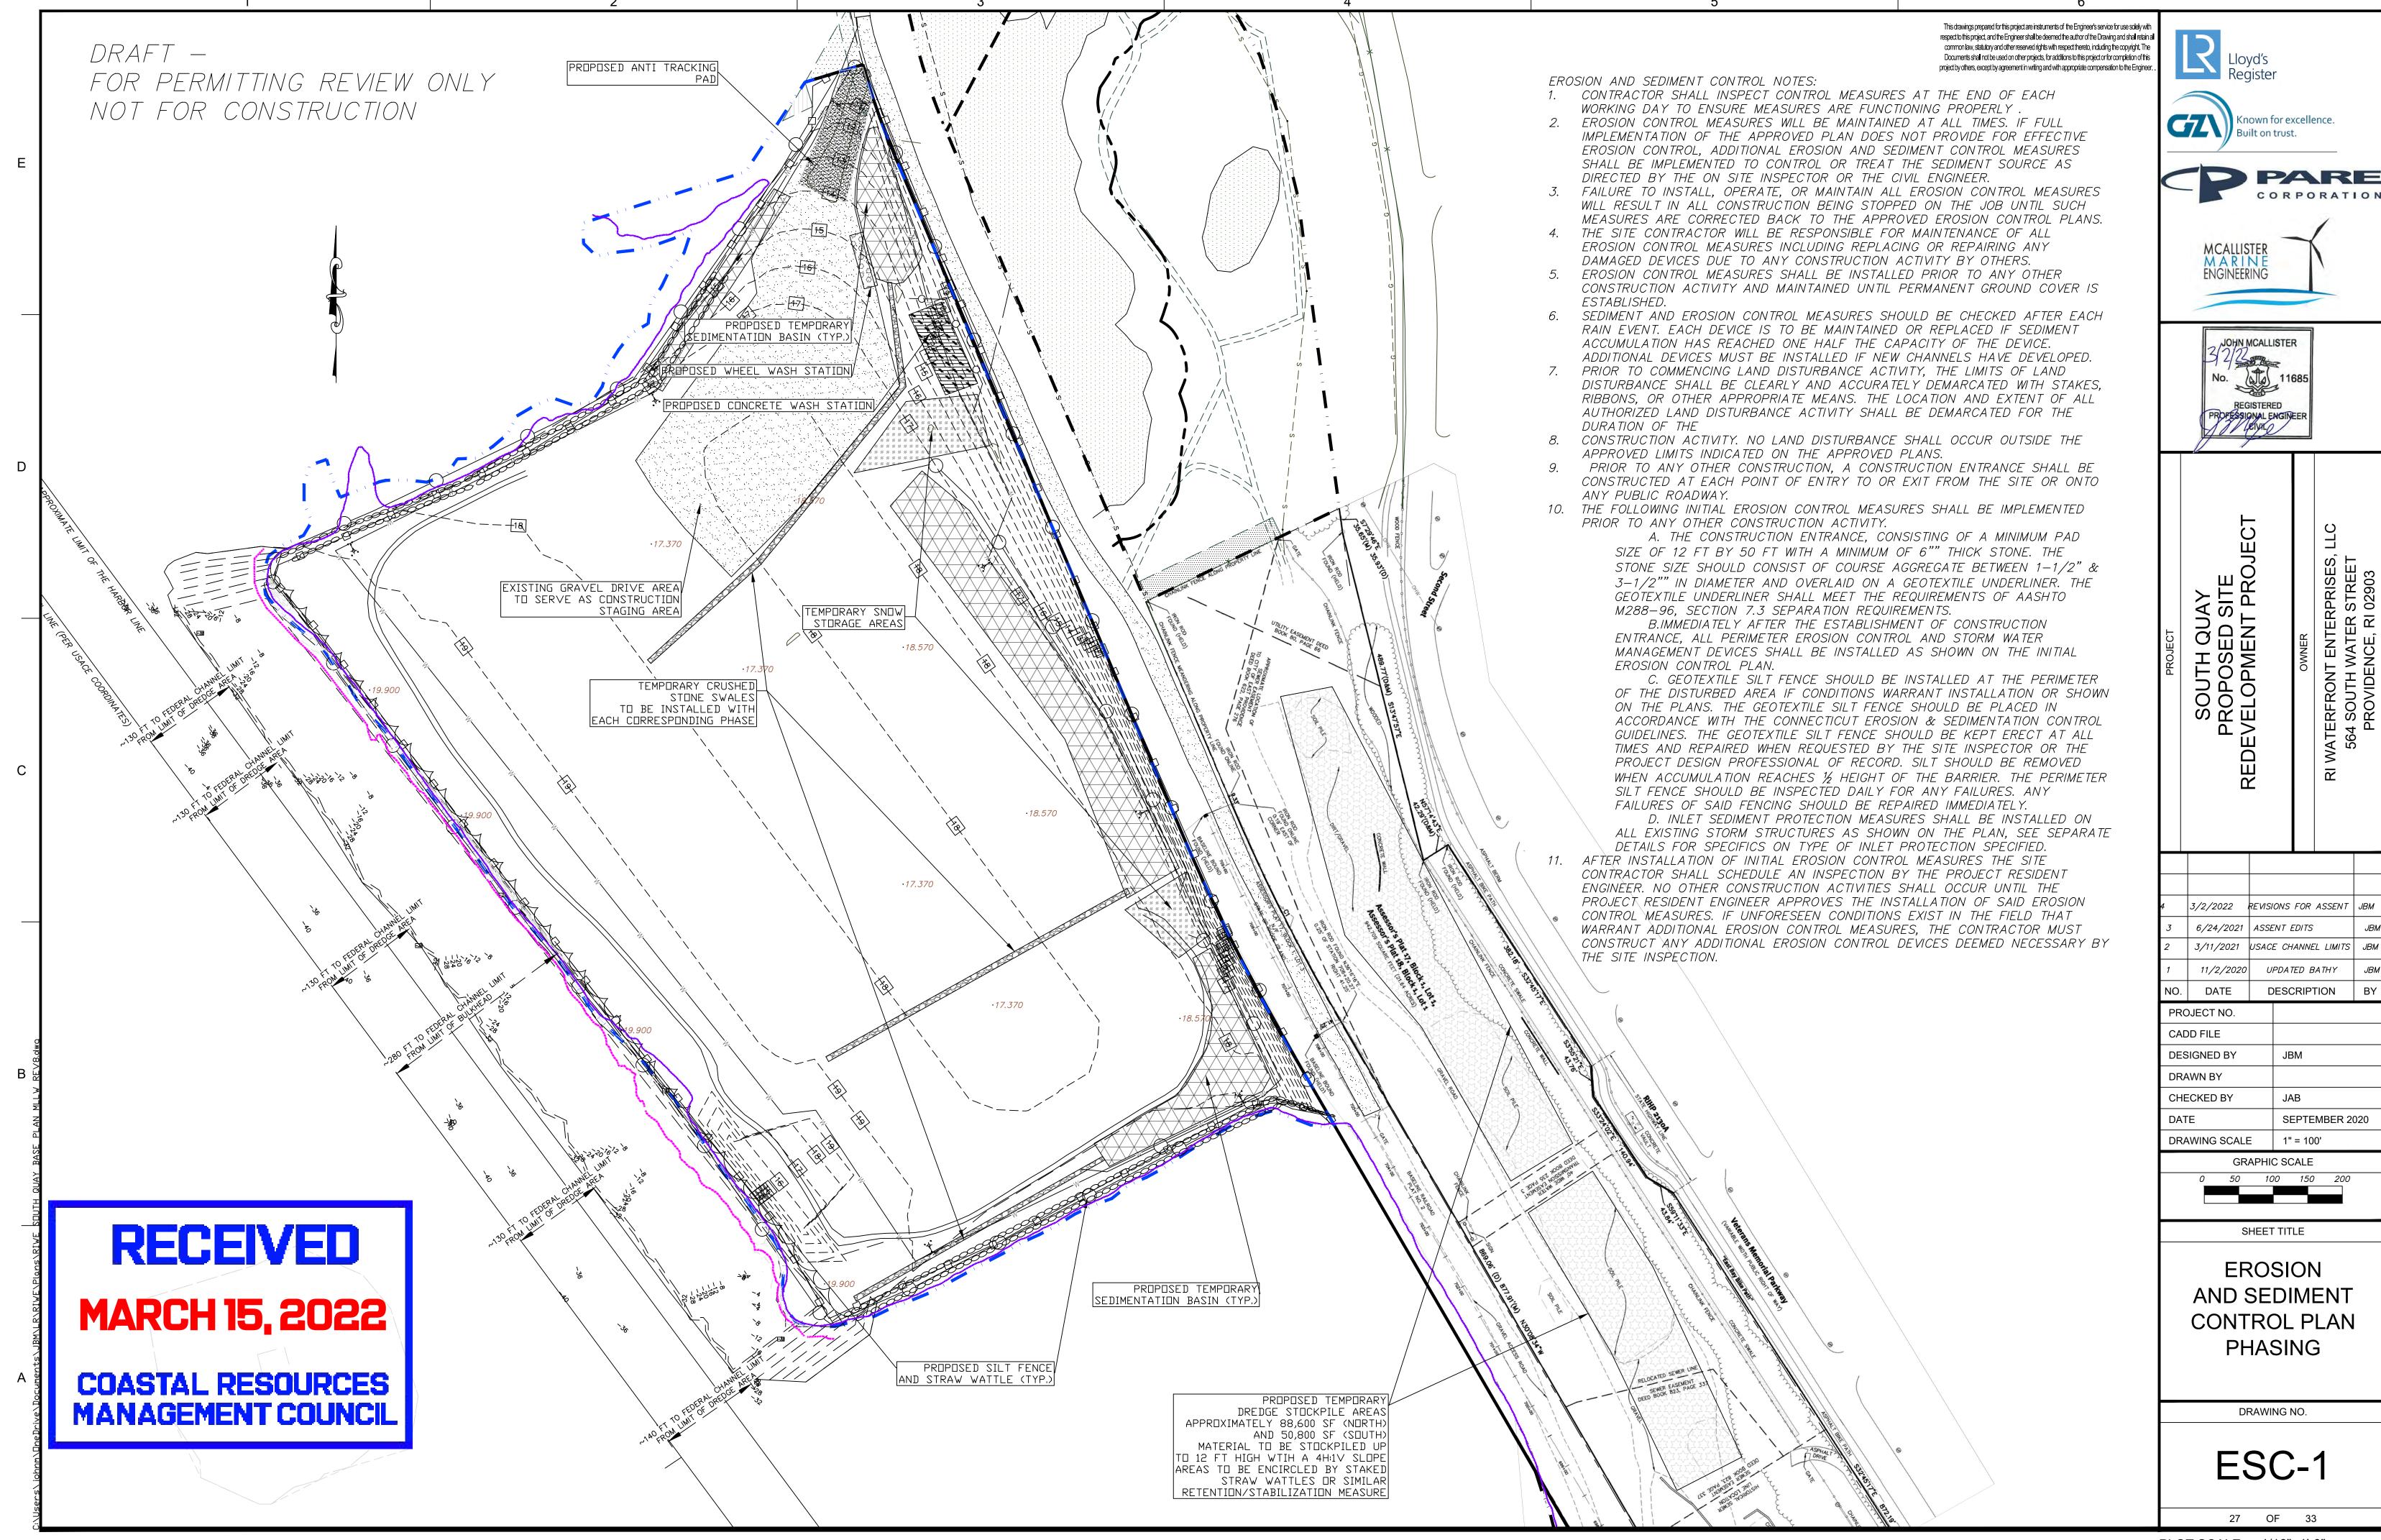

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3/2/2022 REVISIONS FOR ASSENT 6/24/2021 ASSENT EDITS 3/11/2021 USACE CHANNEL LIMITS JBN 11/2/2020 UPDATED BATHY DESCRIPTION DATE PROJECT NO. CADD FILE JBM **DESIGNED BY** DRAWN BY CHECKED BY SEPTEMBER 2020 DRAWING SCALE AS NOTED **GRAPHIC SCALE** 

SHEET TITLE

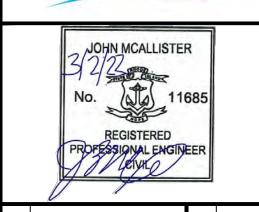**EROSION** AND SEDIMENT **CONTROL PLAN DETAILS** 


DRAWING NO.

ESC-3

29 OF 33



COASTAL RESOURCES **MANAGEMENT COUNCIL** 

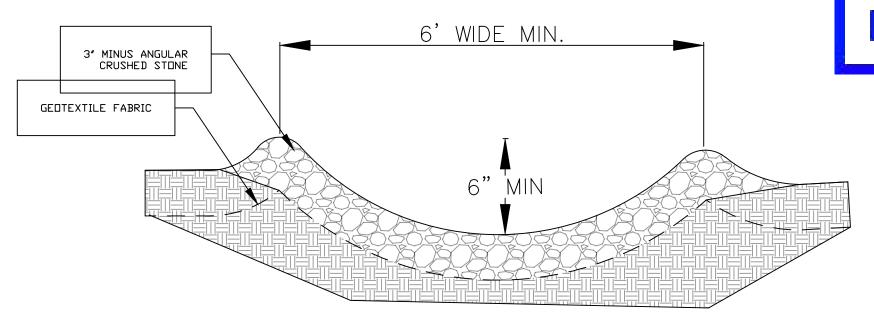

TEMPORARY CRUSHED STONE SWALE TYPICAL PROFILE DETAIL NOT TO SCALE

CRUSHED STONE CONSTRUCTION EXIT

**EXIT DIAGRAM** 


**ENTRANCE ELEVATION** 

- 3. AGGREGATE SIZE SHALL BE IN ACCORDANCE WITH NATIONAL STONE ASSOCIATION R-2 (1.5"-3.5" STONE).
  4. GRAVEL PAD SHALL HAVE A MINIMUM THICKNESS OF 6".
- 5. PAD WIDTH SHALL BE EQUAL FULL WIDTH AT ALL POINTS OF VEHICULAR EGRESS, BUT NO LESS THAN 20'. 6. A DIVERSION RIDGE SHOULD BE CONSTRUCTED WHEN GRADE TOWARD PAVED AREA IS GREATER THAN 2%.. 7. INSTALL PIPE UNDER THE ENTRANCE IF NEEDED TO MAINTAIN DRAINAGE DITCHES.
- 8. WHEN WASHING IS REQUIRED, IT SHOULD BE DONE ON AN AREA STABILIZED WITH CRUSHED STONE THAT DRAINS INTO AN APPROVED SEDIMENT TRAP OR SEDIMENT BASIN (DIVERT ALL SURFACE RUNOFF AND DRAINAGE FROM THE ENTRANCE TO A SEDIMENT CONTROL DEVICE).
- 9. WASHRACKS AND/OR TIRE WASHERS MAY BE REQUIRED DEPENDING ON SCALE AND CIRCUMSTANCE. IF NECESSARY, WASHRACK DESIGN MAY CONSIST OF ANY MATERIAL <u>SUITABLE</u> FOR TRUCK TRAFFIC THAT
- 10.MAINTAIN AREA IN A WAY THAT PREVENTS TRACKING AND/OR FLOW OF MUD ONTO PUBLIC RIGHTS-OF-WAYS. THIS MAY REQUIRE TOP DRESSING, REPAIR AND/OR CLEANOUT OF ANY MEASURES USED TO TRAP SEDIMENT.

## GEOTEXTILE FABRIC 2' WET BASIN DEPTH

TEMPORARY SEDIMENTATION TRAP TYPICAL PROFILE DETAIL NOT TO SCALE

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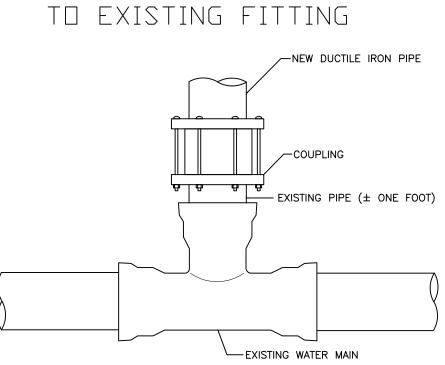


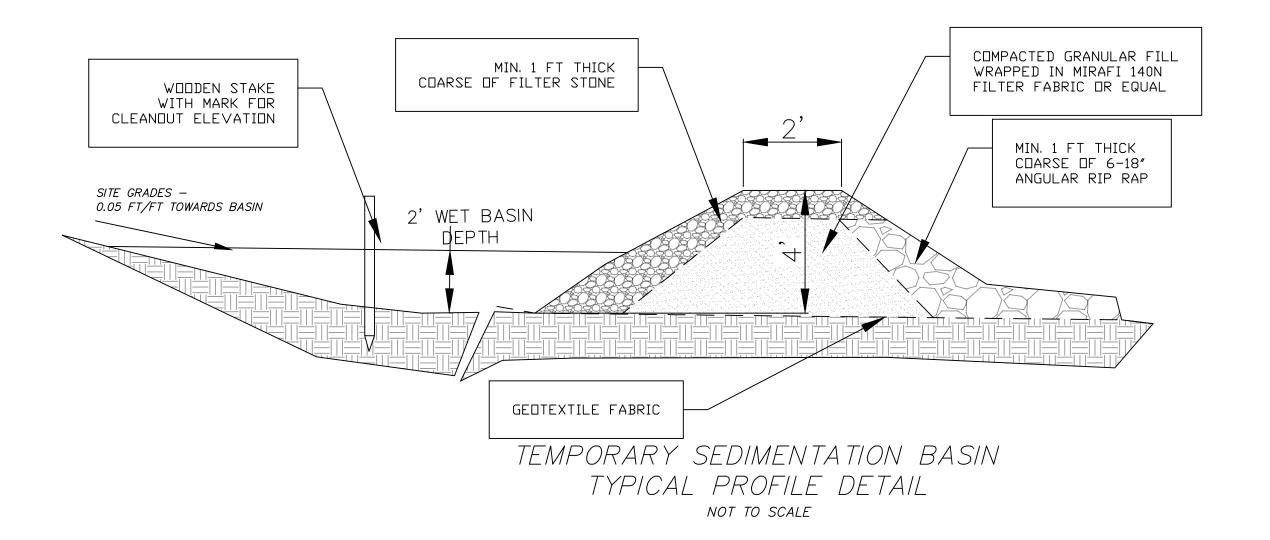PLOT SCALE 1/16"=1'-0"


CITY OF EAST PROVIDENCE DEPARTMENT OF PUBLIC WORKS ENGINEERING DIVISION STANDARD DETAIL TYPICAL HYDRANT DETAIL HY ALT FROM ENE OF DAVED HOAT CHADE WAY FACE VALVE UDX SATURATED, # HUT WITH DUVEN \* J. J. JALYE PAYMENT UMULSTURBED EARTH

THE STUTE


FLANCES TO BE CONNECTED W/ WEGALLOS




TYPICAL CONNECTION

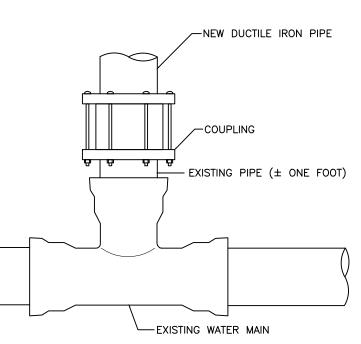


TYPICAL TRENCH DETAIL OF WATER MAIN IN FIRM GROUND

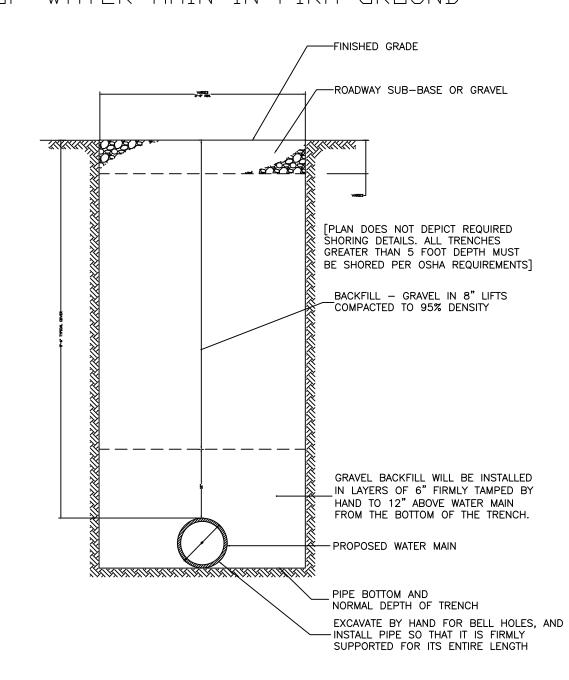

TRENCH FOR SIZES 20-INCH AND SMALLER

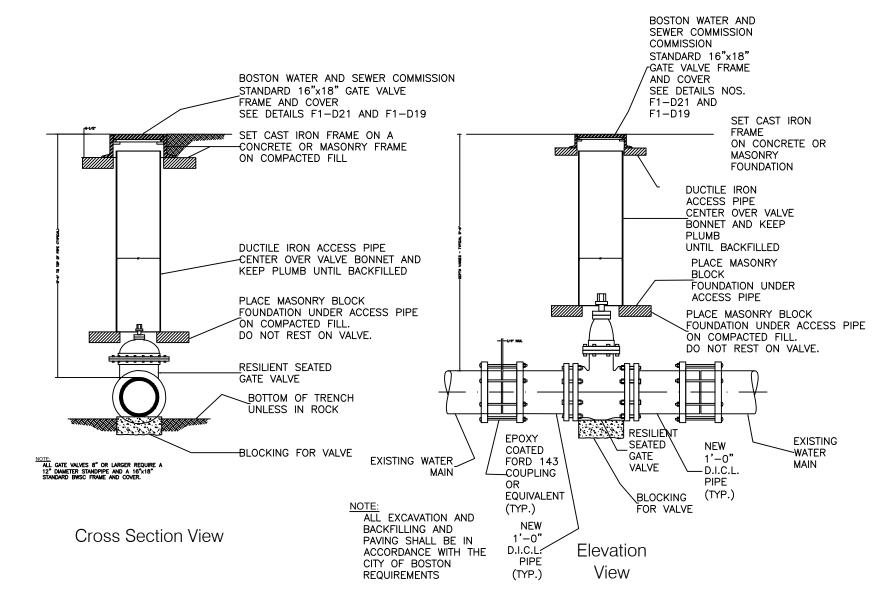

TYPICAL THRUST RESTRAINT

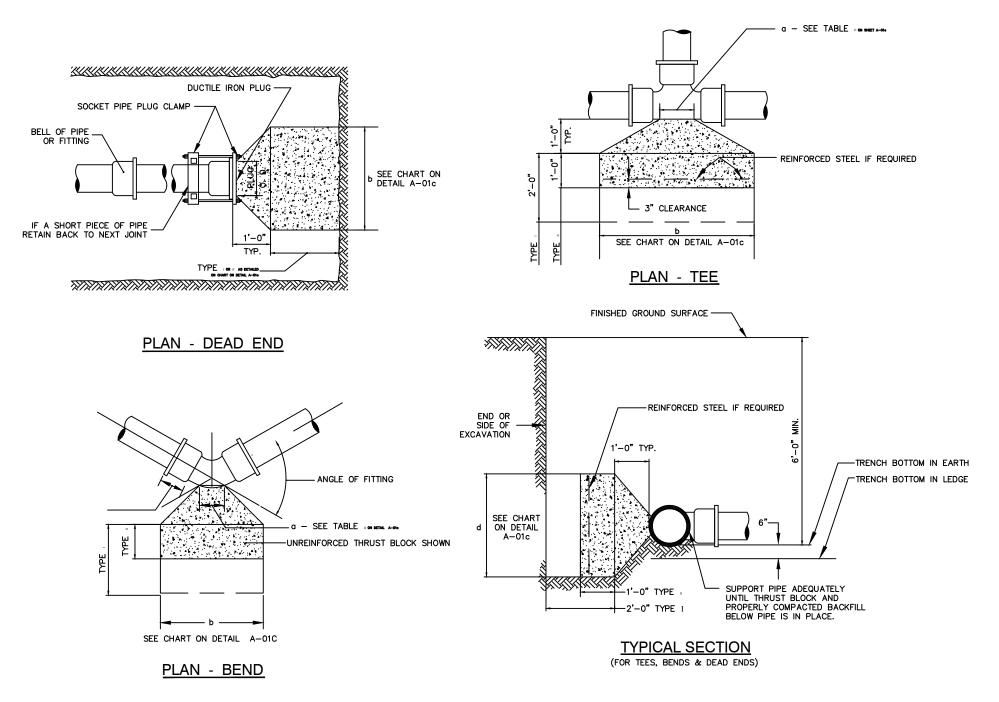

RECEIVED

MARCH 15, 2022

COASTAL RESOURCES MANAGEMENT COUNCIL

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**DRAWN BY** CHECKED BY JAB DATE SEPTEMBER 2020 DRAWING SCALE AS NOTED **GRAPHIC SCALE** 


DETAIL

SHEET TITLE

DRAWING NO.

30 OF 33

PLOT SCALE 1/16"=1'-0"

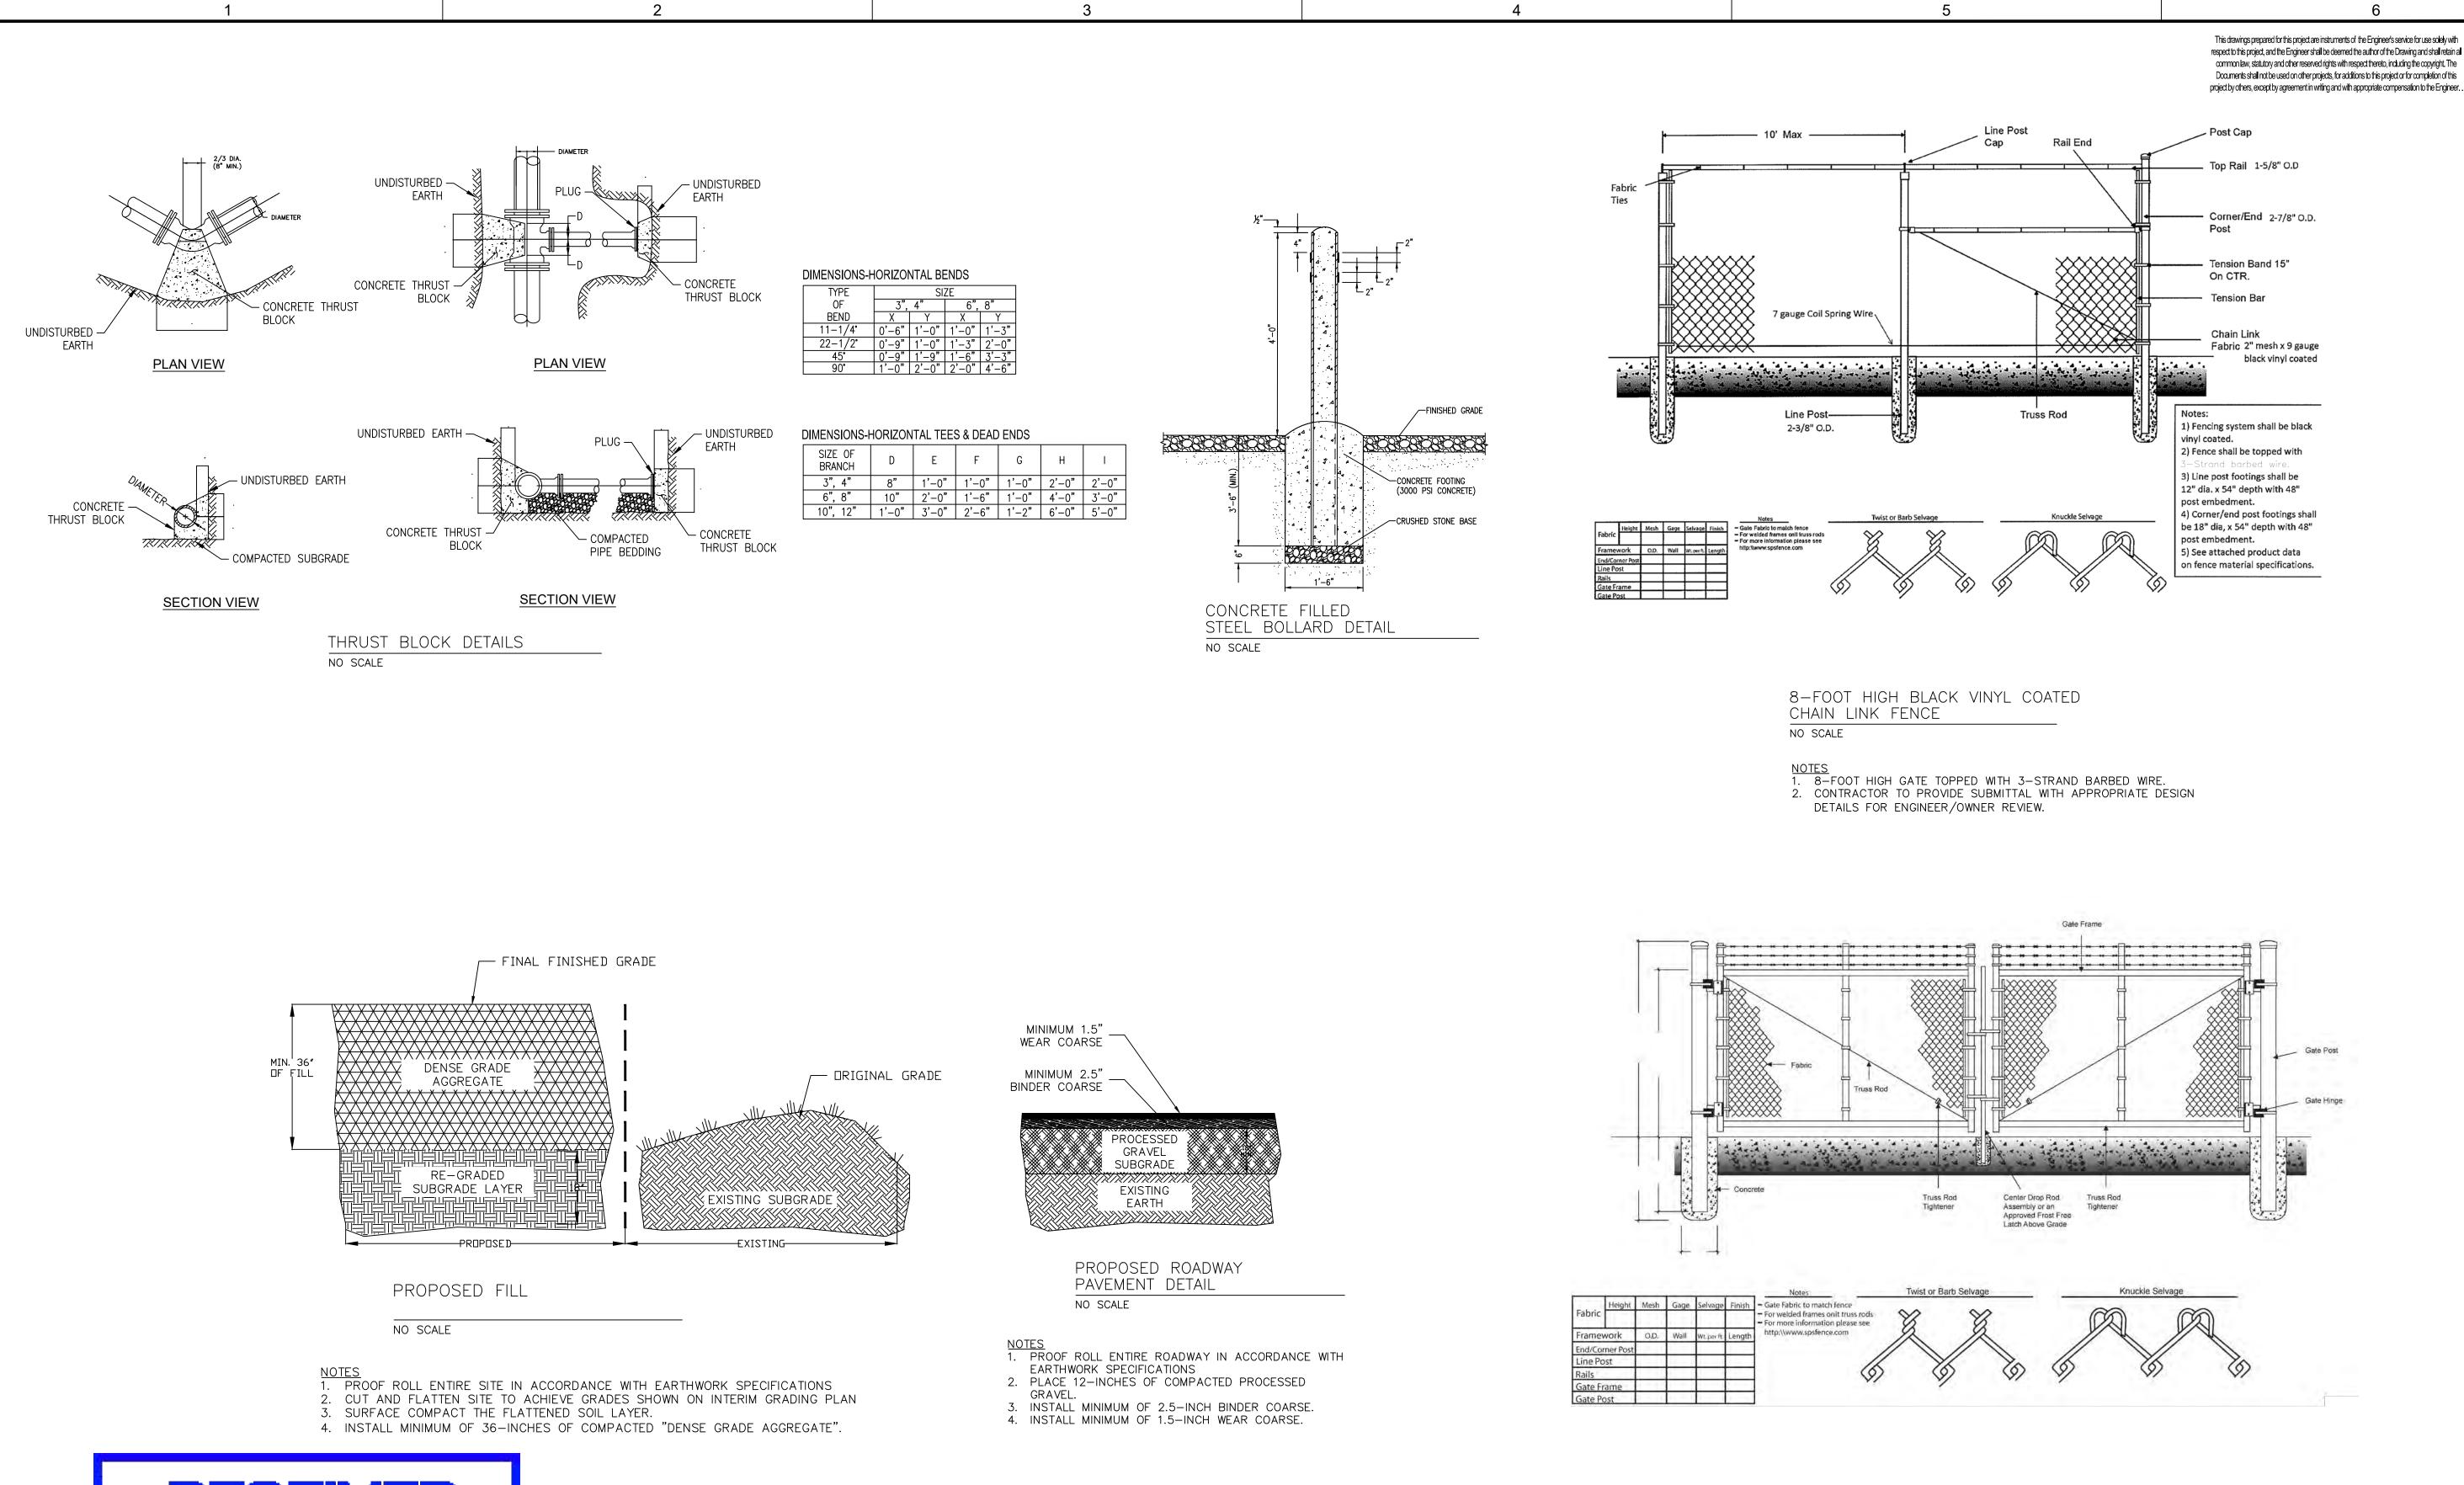

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14-FOOT WIDE INDUSTRIAL

GRADE DOUBLE GATE

NO SCALE

Known for excellence.


MARINI


ENGINEERING

REGISTERED

PROPESSIONAL ENGINEER

CORPORATIO

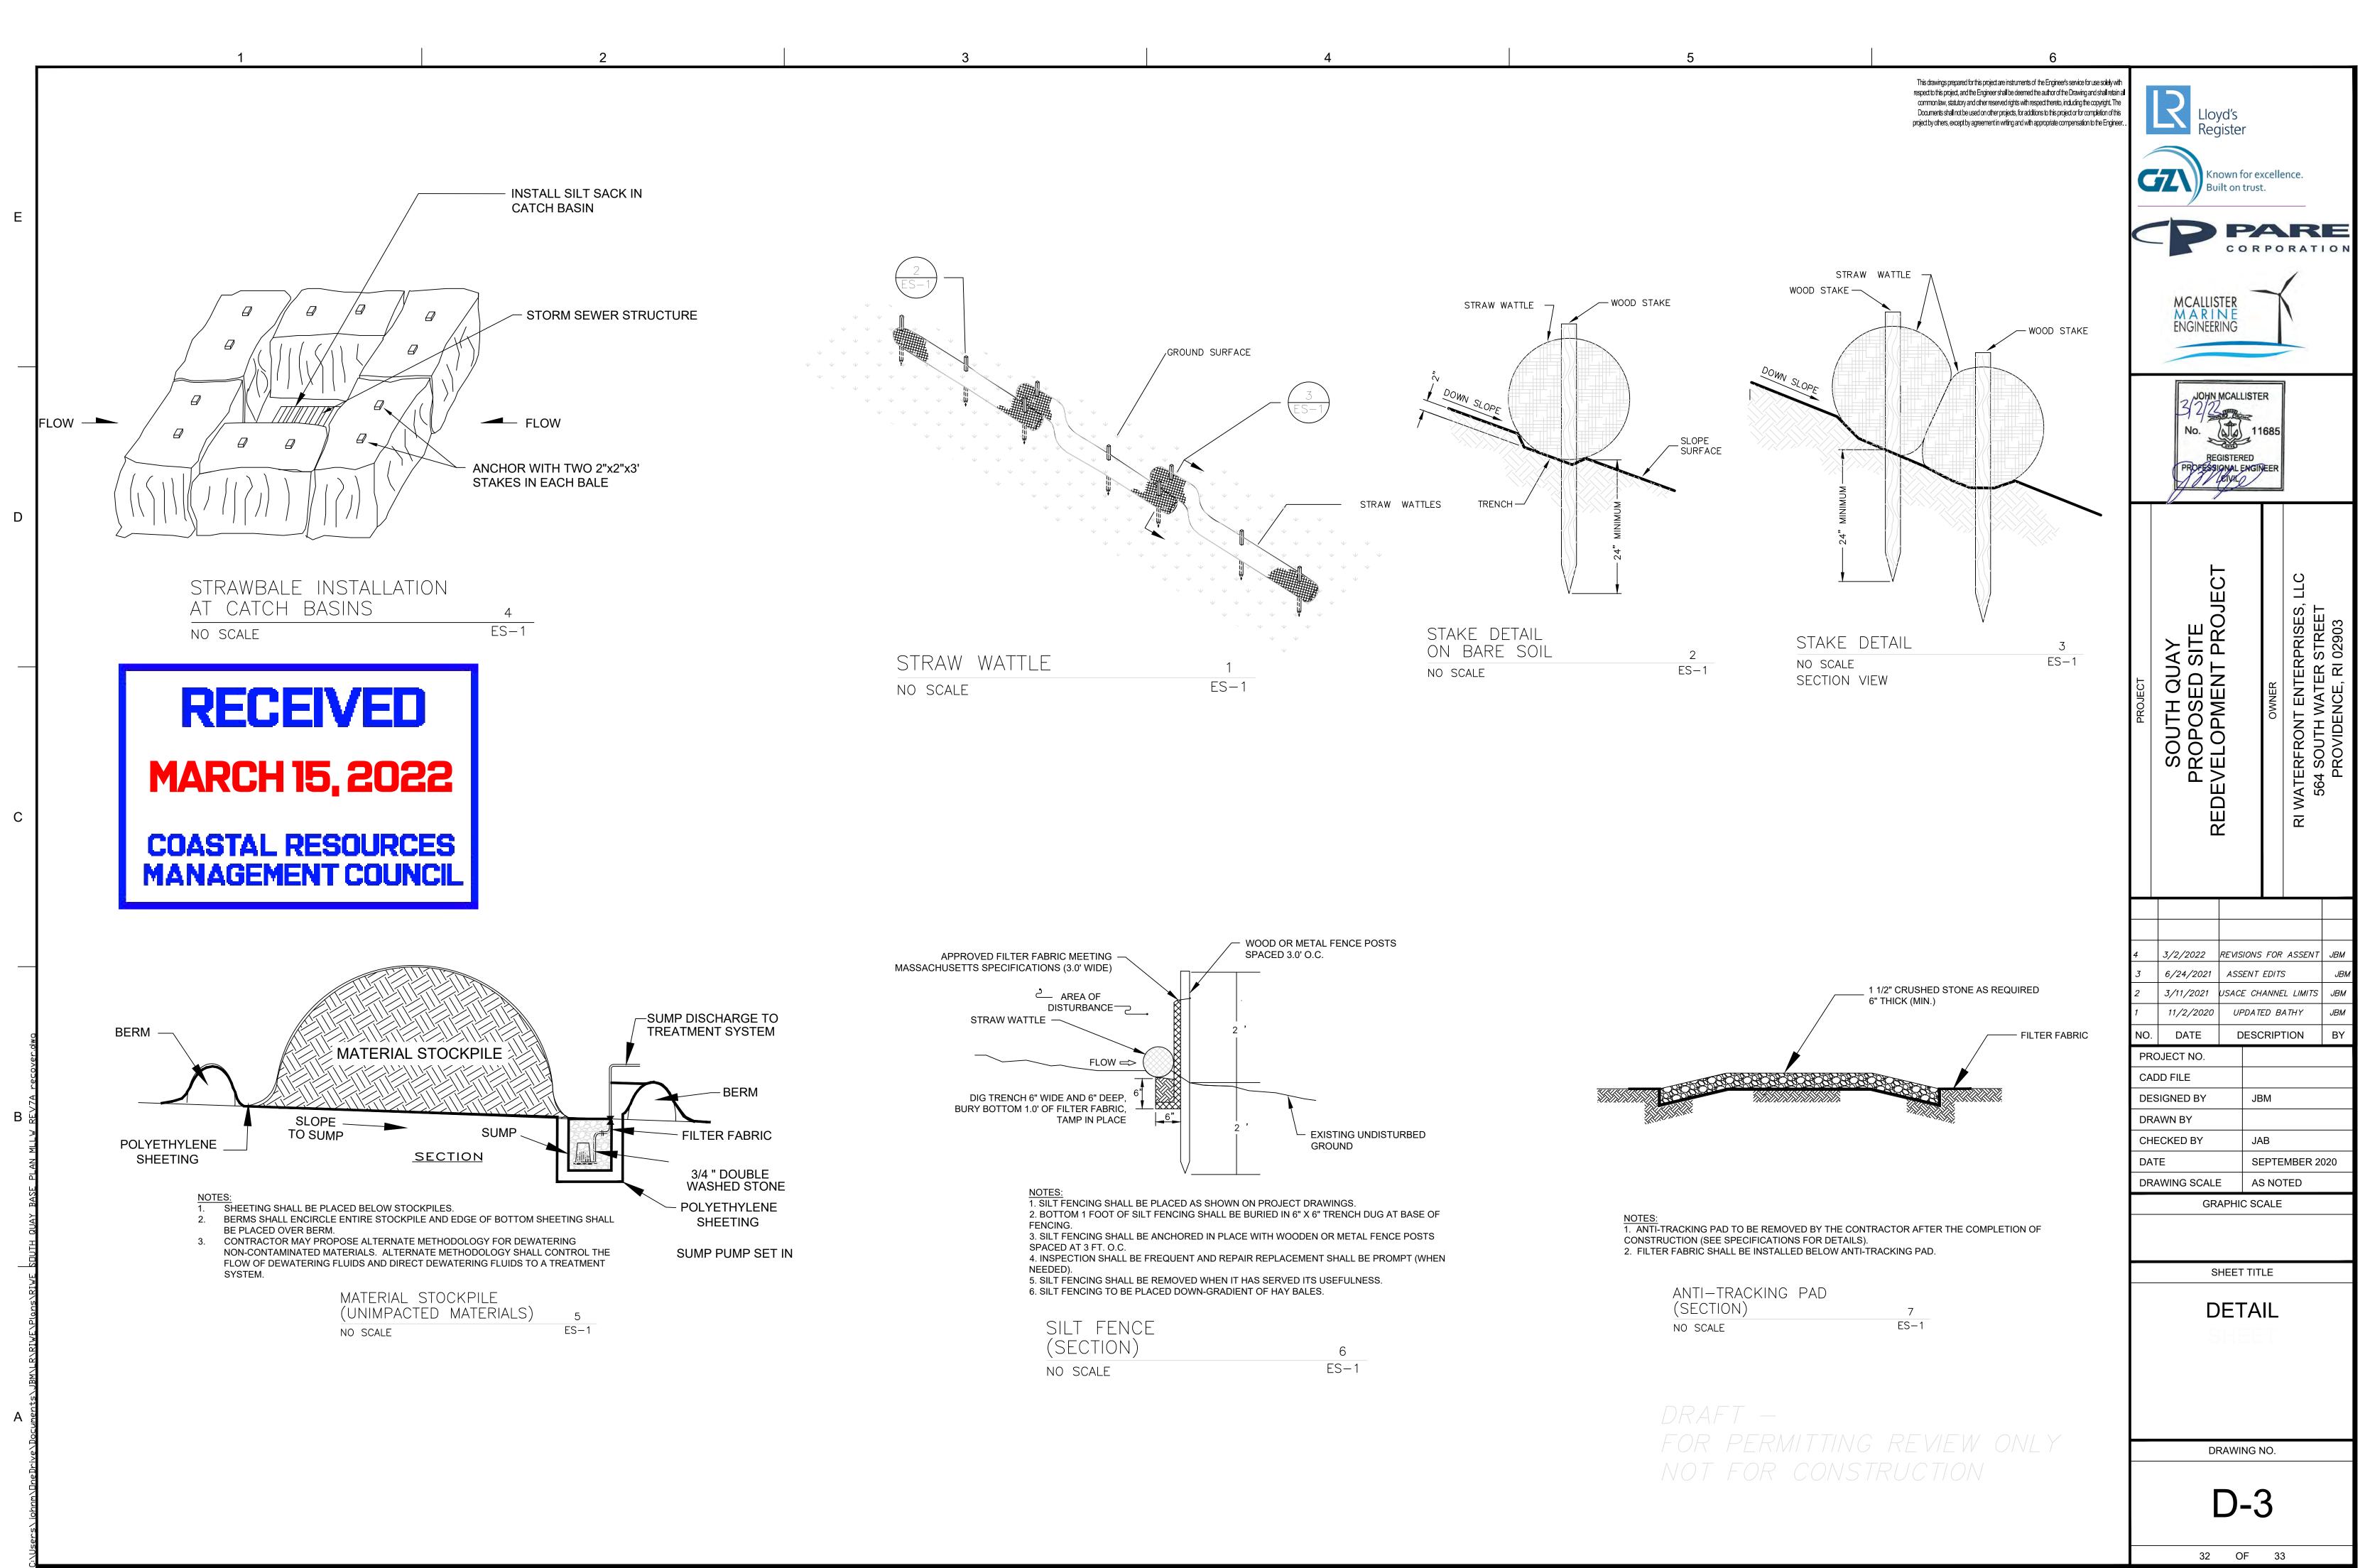

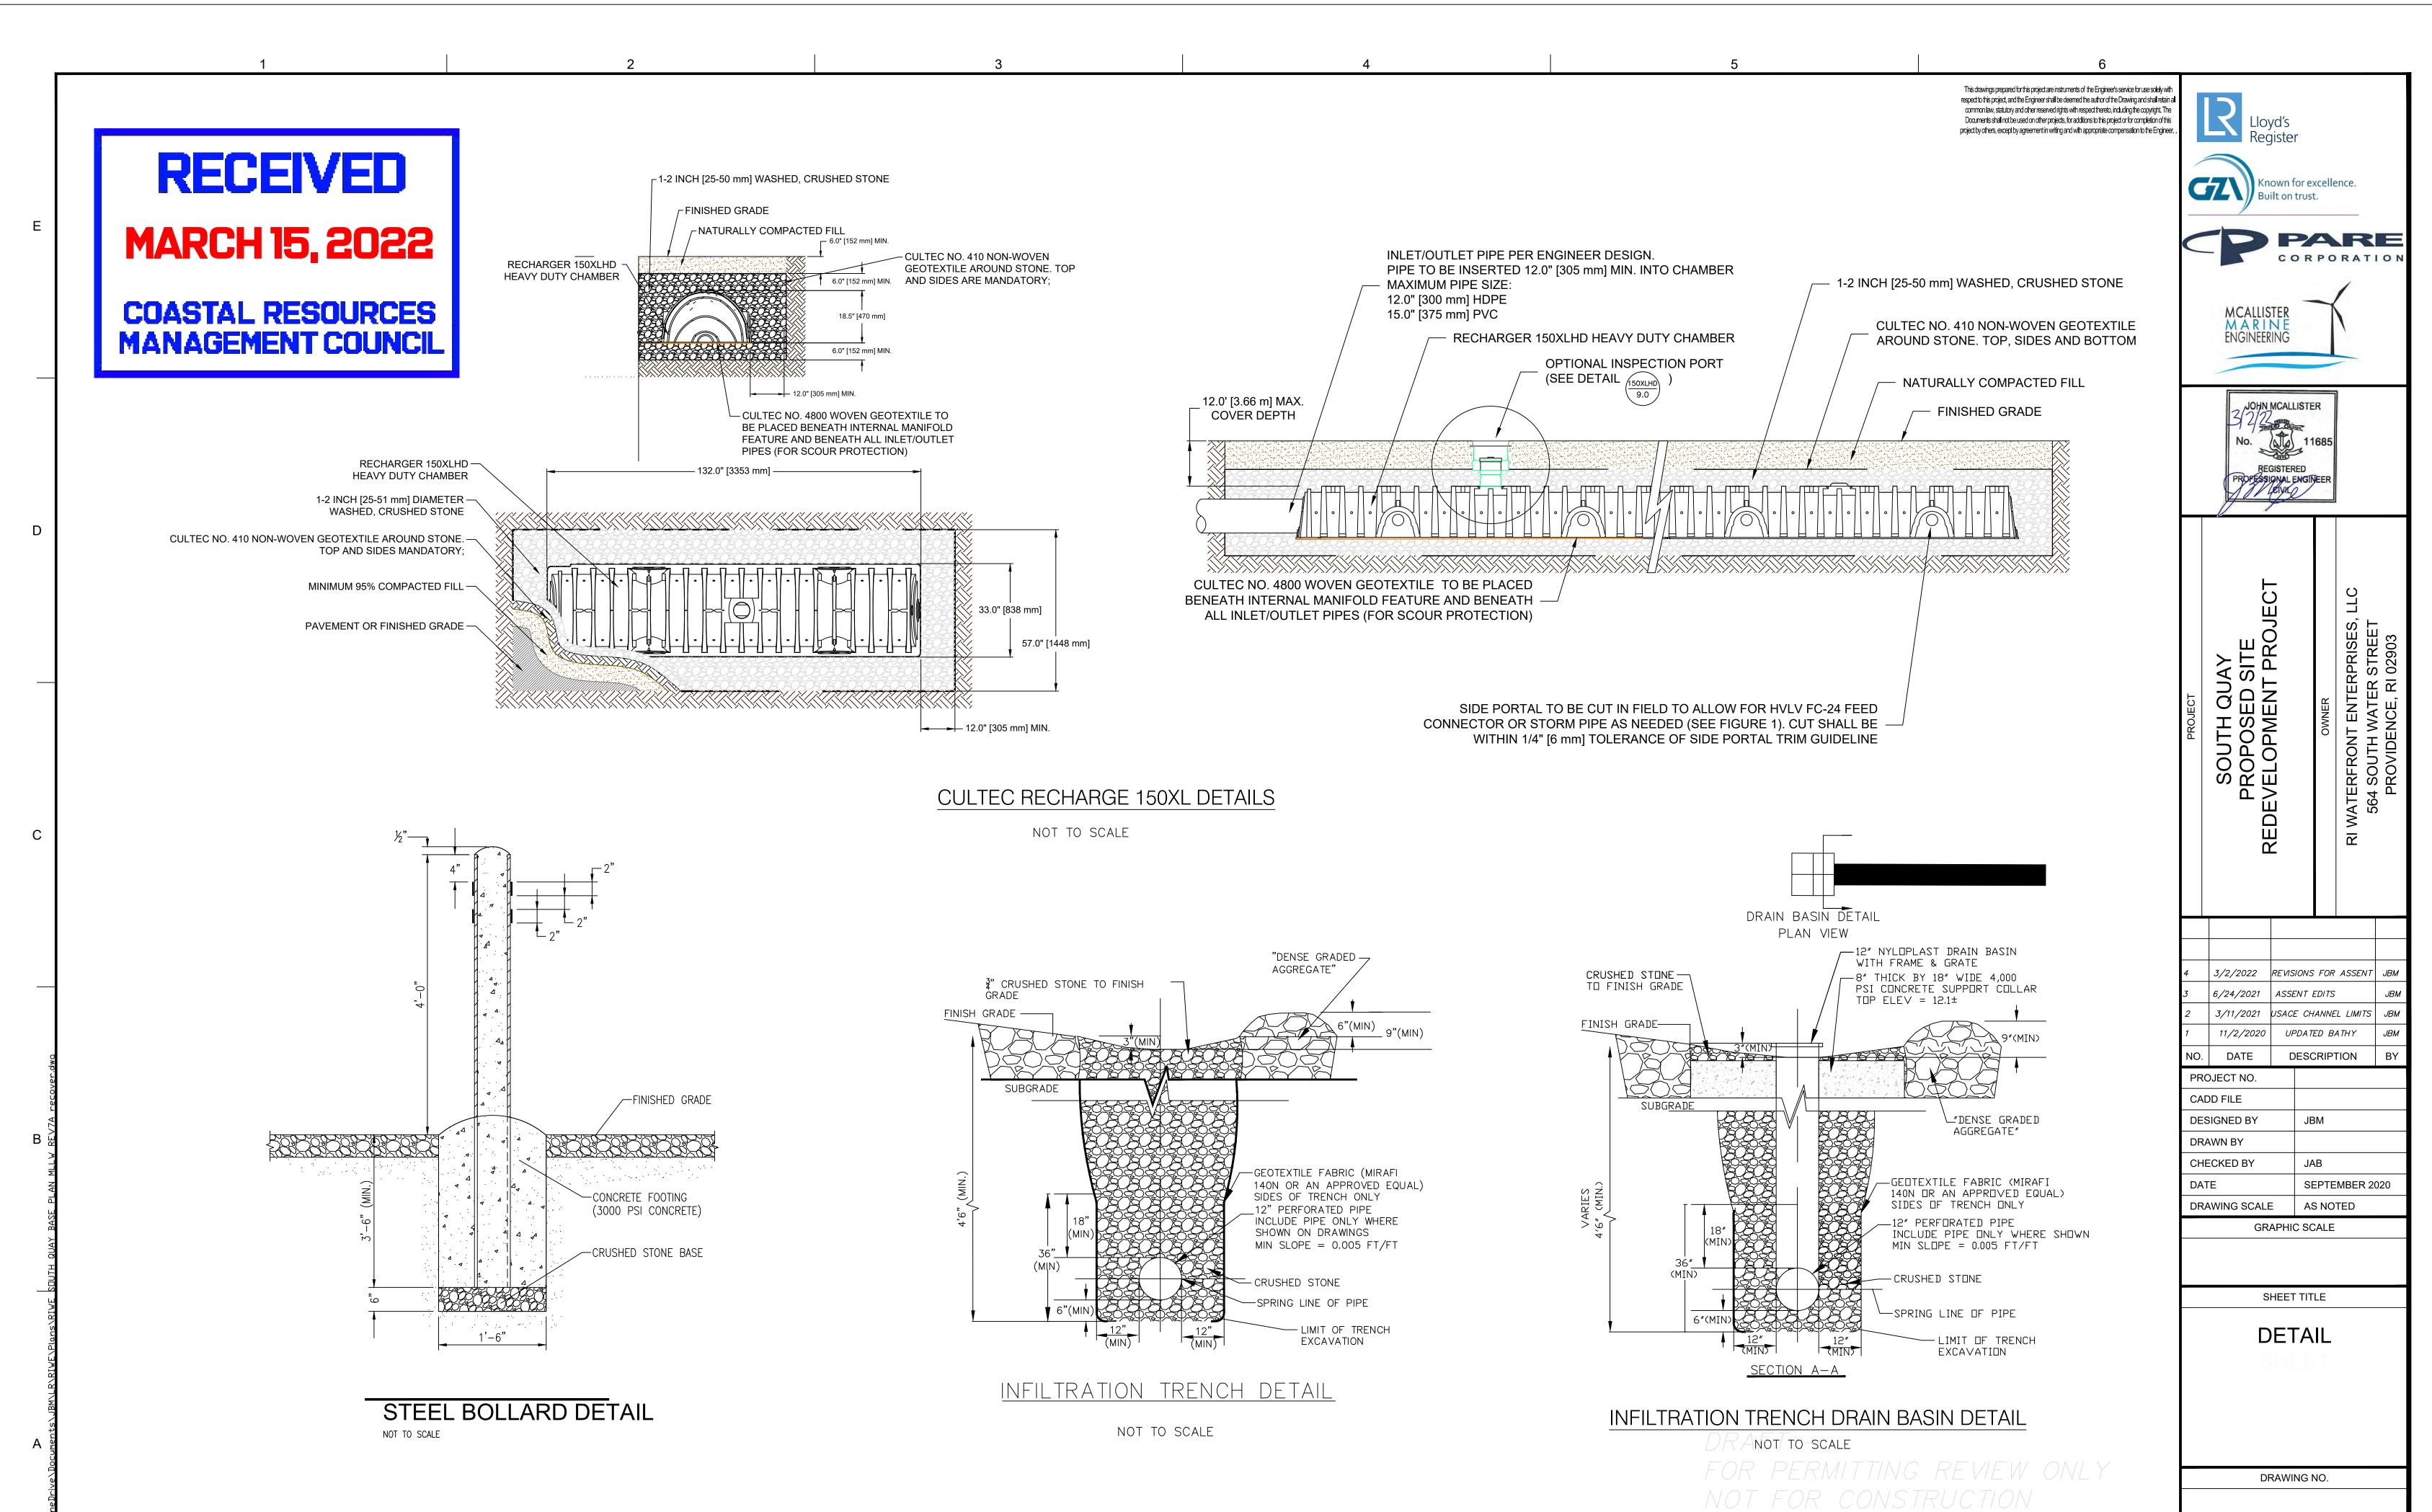

33 OF 33