

Letter of Transmittal

Attention:	Rich Lucia				Dat	e:	2/1/2024		Project No.: 13981
Address:	Stedman Gov 4808 Tower H Wakefield, RI	lill Ro	oad	er, Suite 3	Re:		East Provide	nce Bo	oth Avenue Slope Stabilization
Item(s) acc	companying th	nis tro	ansmittal;						
☐ Agreer	ment		Plans			Spe	cifications		Prints
☐ Shop □)rawings		Change	e Order		San	nples		Copy of Letter
Other:Copies	Date		No.	Description				2	2 °
1	2/1/2024			8 ½"x 11" Pla	n Set				
1	2/1/2024			24" x 36" Plar	ı Set				
Purpose:								se _e	
☐ For app	roval		Approve	d as submitted			Resubmit		copies for approval
☐ For sign	ature		Approve	d as noted	8		Submit		copies for distribution
☐ For your	use		Returned	for corrections			Return		corrected prints
✓ As requent	ested		For review	w and commen	t		Prints returne	d after	loan to us
☐ Other:							FOR BIDS DUI	E	
Remarks:	As per your		FEB (EIVED 0 2 2024	the s	ubm	itted hard co		the project plans.
Сору То:	file	N	ANAGEME	NT COUNCIL			Signed:	L.	with Epkins

CITY OF EAST PROVIDENCE, RHODE ISLAND


BOOTH AVENUE SLOPE STABILIZATION


Septmeber 2023


RICRMC PERMIT SUBMISSION

FOR REGULATORY REVIEW ONLY

REV. Jan. 3, 2024

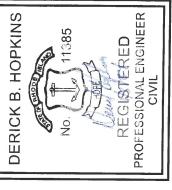

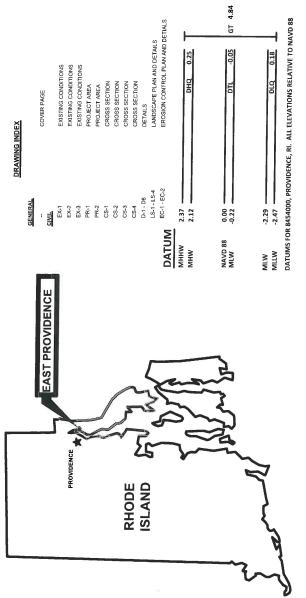


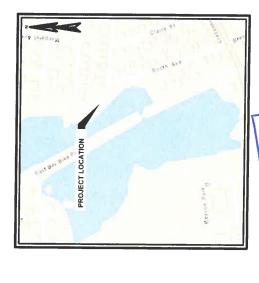


Engineering a Better Environment Wright-Pierce 🝣

888.621.8156 | www.wright-pierce.com


WP PROJECT No. 13981 COASTAL RESOURCES FOR REVIEW MANAGEMENT COUNCIL FOR BIDDING RECEIVED FEB 0 2 2024

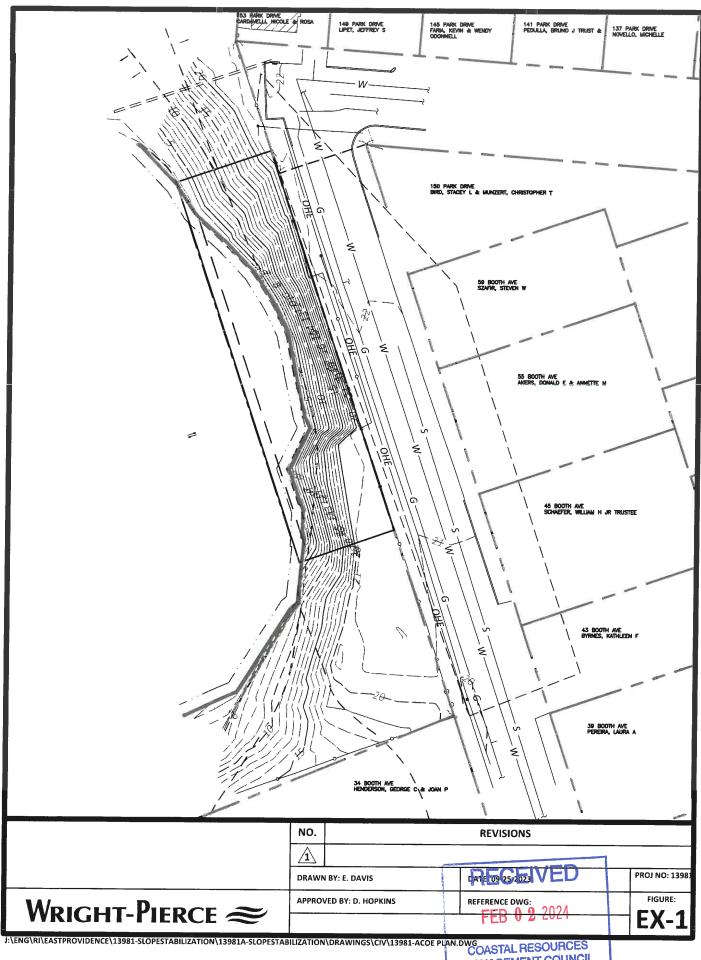



MANAGEMENT COUNCIL

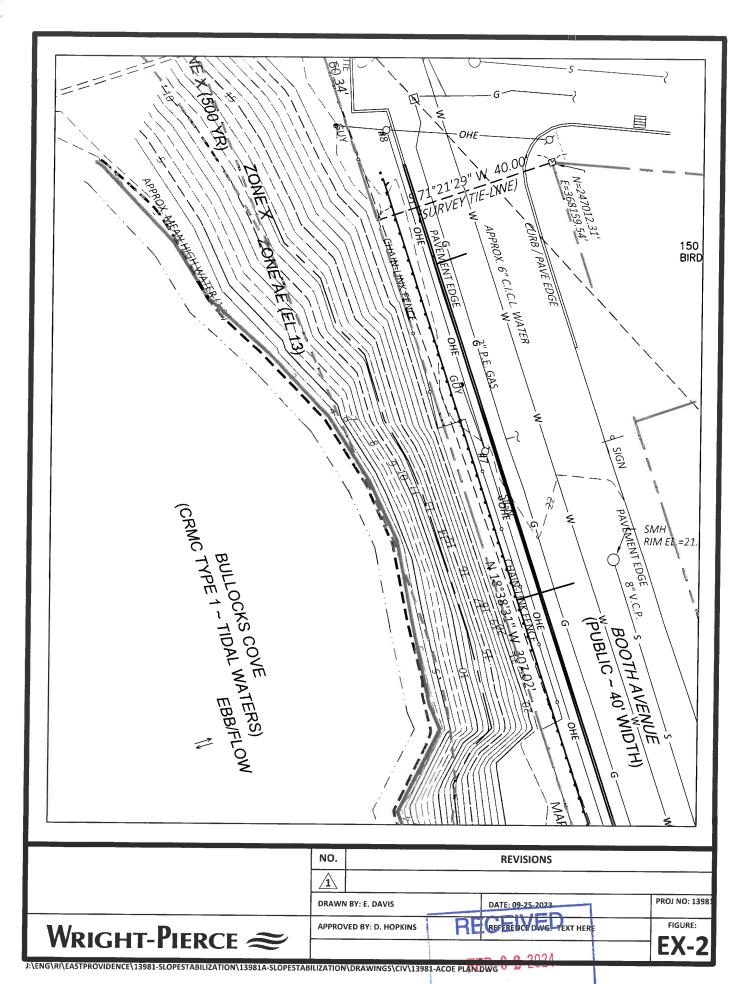



COASTAL RESOURCES
MANAGEMENT COUNCIL

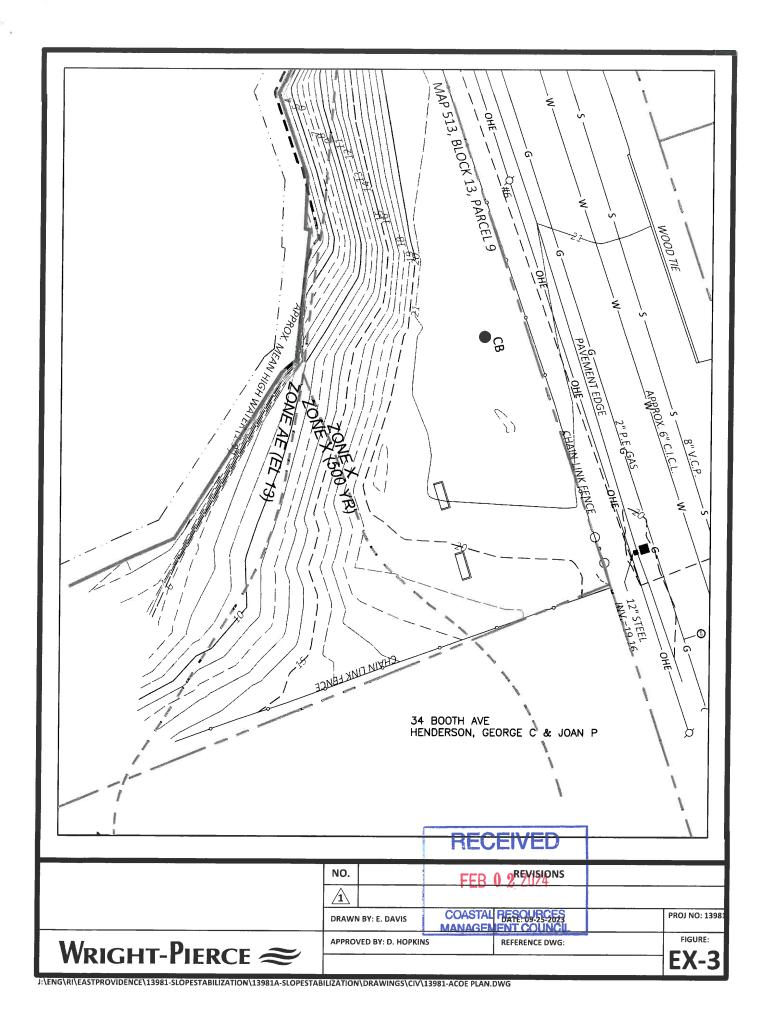


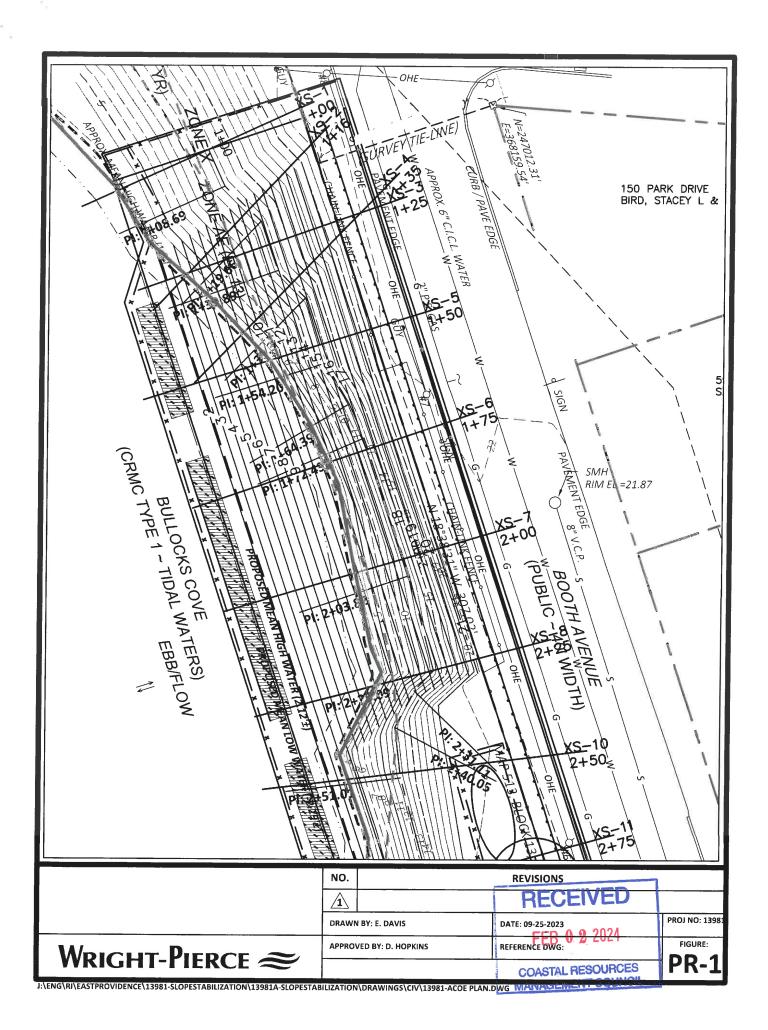


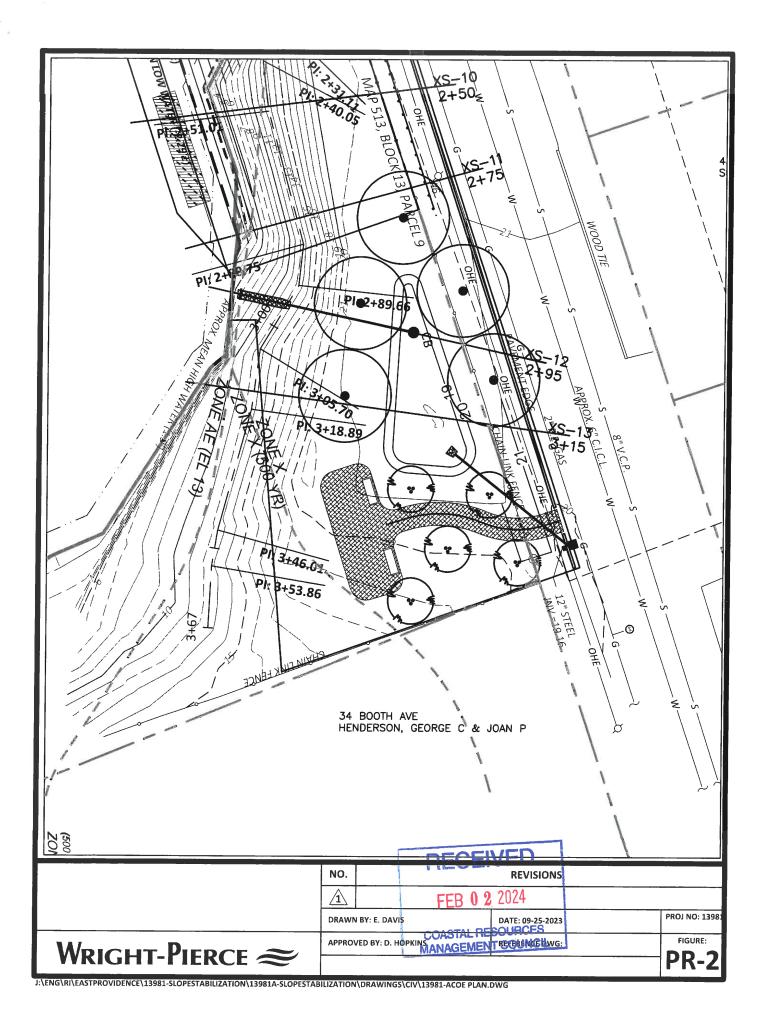


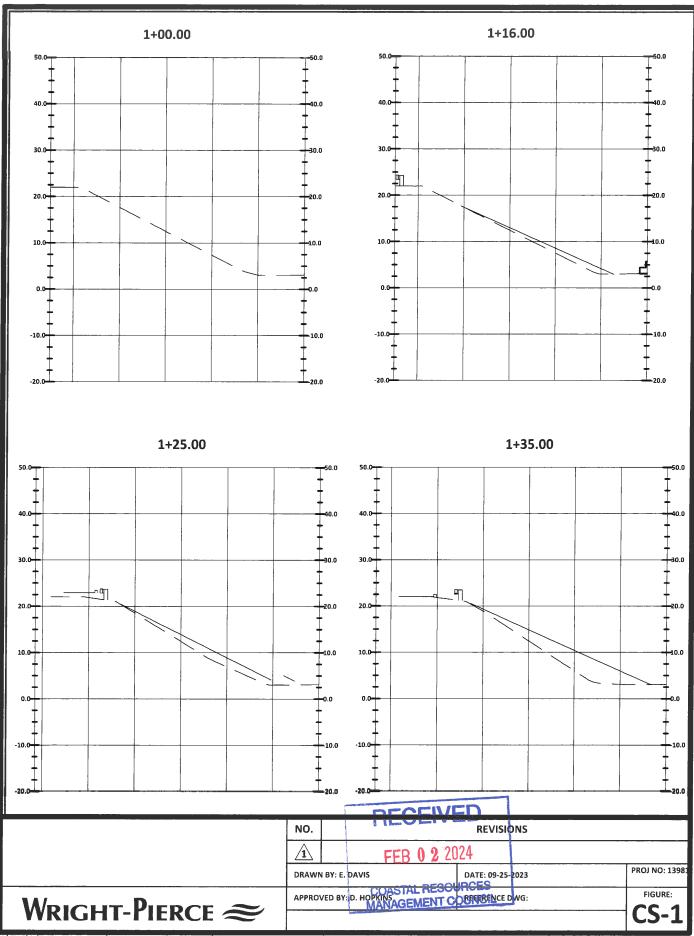


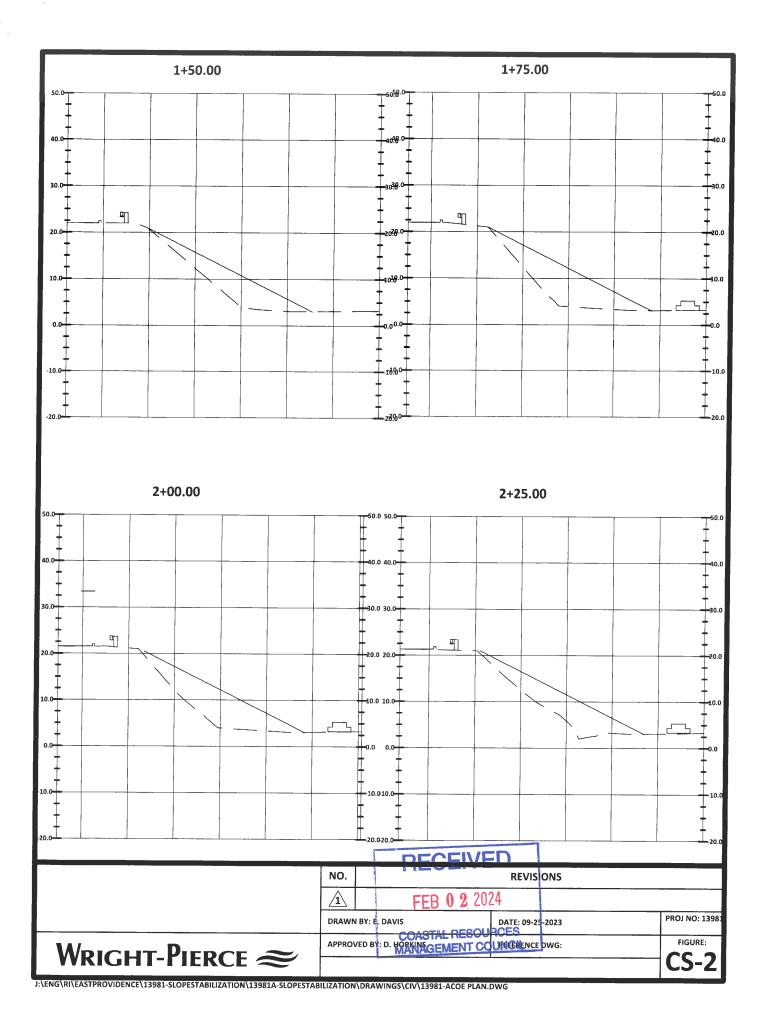


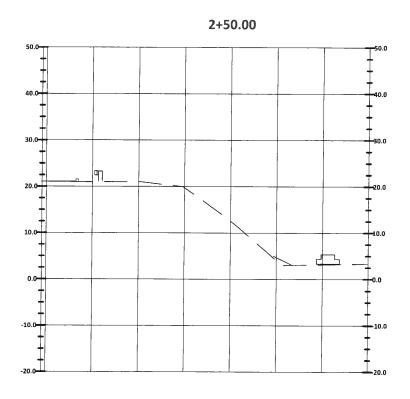

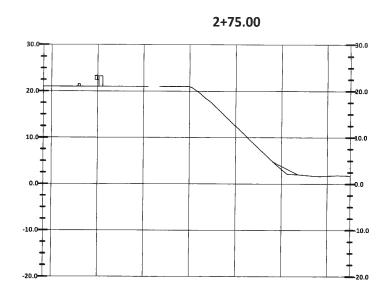


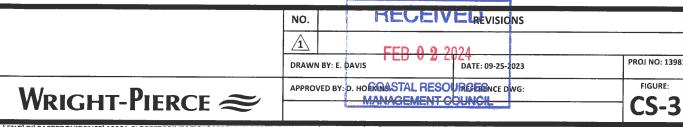


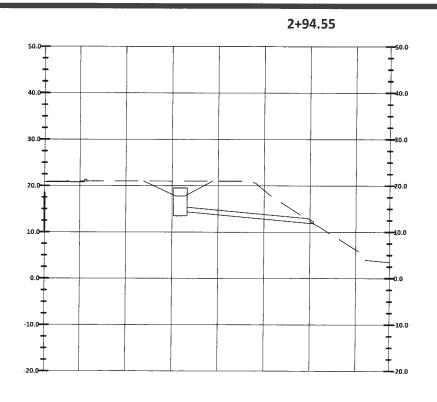


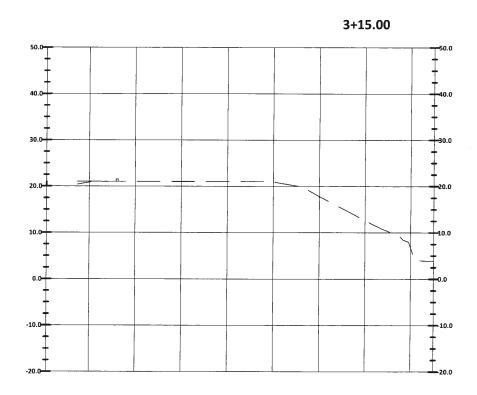

	NO. RECEIVELREVISIONS	
	<u>A</u> 0.0.2024	
	DRAWN BY: E. DAVIS FEB U Z Z DATE: 09-25-2023	PROJ NO: 1398
WRIGHT-PIERCE \approx	APPROVED BY: D. HOPKINSASTAL RESOURCE DWG: MANAGEMENT COUNCIL	CS-4

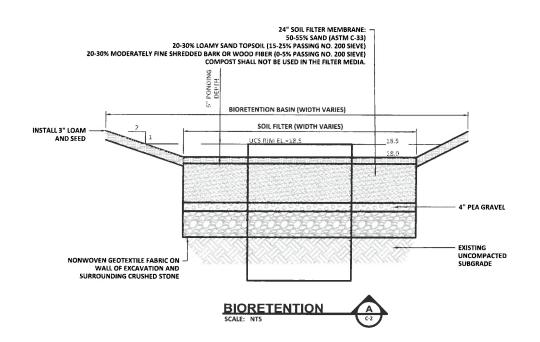


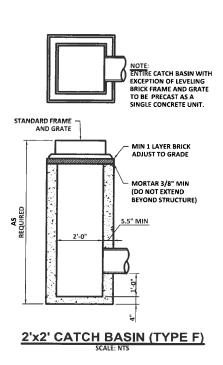

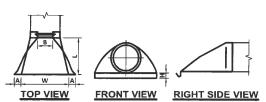


PIPE DIAN	METER (in)
DIAMETER (in)	12.0
A (in)	7.0
B(max) (in)	15.0
H (in)	6.0
L (in)	21.0
W (in)	24.0

HDPE FLARED END SECTION SCALE: NTS

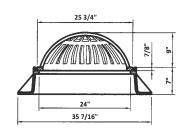


HIGH BEEHIVE GRATE & FRAME

RECEIVED	NO.		REVISIONS	
FEB 0 2 2024				PROJ NO: 13981
COASTAL RESOURCES	DRAWN BY: E.	DAVIS	DATE: 09-25-2023	FIGURE:
WRIGHTANPIERCENCE	APPROVED BY:	D. HOPKINS	REFERENCE DWG:	D-1

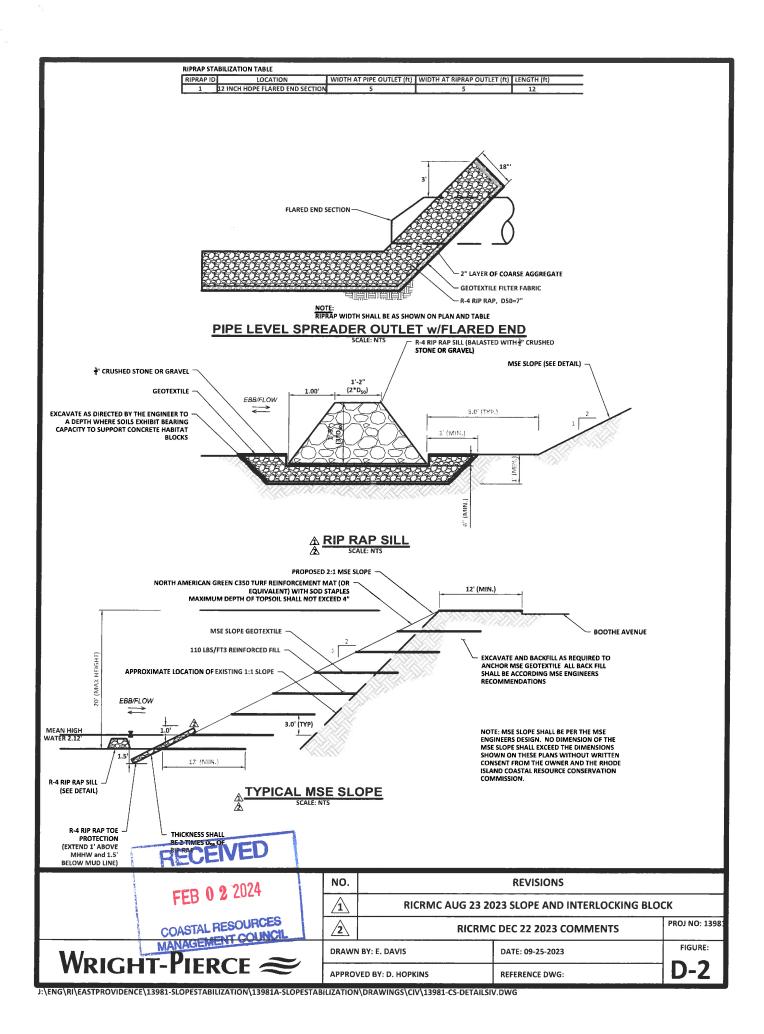

- PREPARE SOIL BEFORE INSTALLING ROLLED EROSION CONTROL PRODUCTS (RECP'S), INCLUDING ANY NECESSARY
 APPLICATION OF LIME, FERTILIZER, AND SEED. NOTE: WHEN USING CELL-O-SEED DO NOT SEED PREPARED AREA.
 CELL-O-SEED MUST BE INSTALLED WITH PAPER SIDE DOWN.
- 2. BEGIN AT THE TOP OF THE SLOPE BY ANCHORING THE RECP'S IN A 6" (15 CM) DEEP X 6" (15 CM) WIDE TRENCH WITH APPROXIMATELY 12" (30 CM) OF RECP'S EXTENDED BEYOND THE UP-SLOPE PORTION OF THE TRENCH. ANCHOR THE RECP'S WITH A ROW OF STAPLES/STAKES APPROXIMATELY 12" (30 CM) APART IN THE BOTTOM OF THE TRENCH. BACKFILL AND COMPACT THE TRENCH AFTER STAPLING. APPLY SEED TO COMPACTED SOIL AND FOLD REMAINING 12" (30 CM) PORTION OF RECP'S BACK OVER SEED AND COMPACTED SOIL SECURE RECP'S OVER COMPACTED SOIL WITH A ROW OF STAPLES/STAKES SPACED APPROXIMATELY 12" (30 CM) APART ACROSS THE WIDTH OF THE RECP'S.
- 3. ROLL THE RECP'S (A.) DOWN OR (B.) HORIZONTALLY ACROSS THE SLOPE. RECP'S WILL UNROLL WITH APPROPRIATE SIDE AGAINST THE SOIL SURFACE. ALL RECP'S MUST BE SECURELY FASTENED TO SOIL SURFACE BY PLACING STAPLES/STAKES IN APPROPRIATE LOCATIONS AS SHOWN IN THE STAPLE PATTERN GUIDE. WHEN USING THE DOT SYSTEMTM, STAPLES/STAKES SHOULD BE PLACED THROUGH EACH OF THE COLORED DOTS CORRESPONDING TO THE APPROPRIATE STAPLE PATTERN.
- 4. THE EDGES OF PARALLEL RECP'S MUST BE STAPLED WITH APPROXIMATELY 2" 5" (5 CM 12.5 CM) OVERLAP DEPENDING ON RECP'S TYPE.
- CONSECUTIVE RECP'S SPLICED DOWN THE SLOPE MUST BE PLACED END OVER END (SHINGLE STYLE) WITH AN
 APPROXIMATE 3" (7.5 CM) OVERLAP. STAPLE THROUGH OVERLAPPED AREA, APPROXIMATELY 12" (30 CM) APART
 ACROSS ENTIRE RECP'S WIDTH.


NOTE: IN LOOSE SOIL CONDITIONS, THE USE OF STAPLE OR STAKE LENGTHS GREATER THAN 6" (15 CM) MAY BE NECESSARY TO PROPERLY SECURE THE RECP'S.

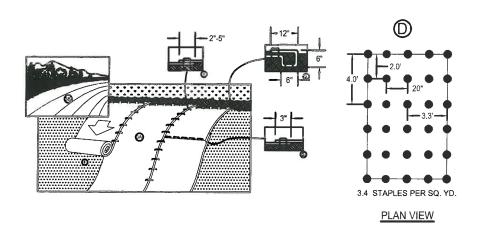


2H:1V TURF REINFORCEMENT INSTALLATION SCALE: NTS


Wright-Pierce 🍣				D-3
Which Dience ~		VED BY: D. HOPKINS	REFERENCE DWG:	FIGURE:
	1	N BY: E. DAVIS	DATE: 09-25-2023	PROJ NO: 1398
MANAGEMENT COUNCIL	<u>î</u>			
SOURCES	NO.		REVISIONS	
FEB 0 2 2024				

DECENED

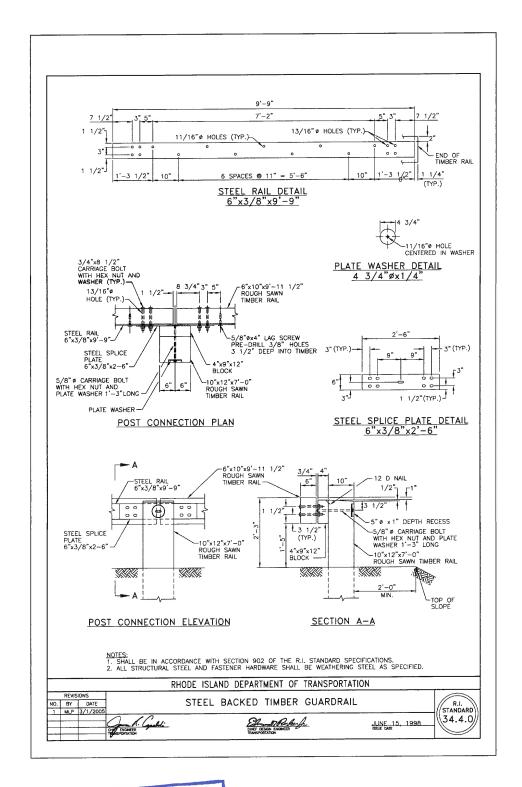



FECEIVED	NO.		REVISIONS	
FEB 0 2 2024	<u>í</u>			
	DRA	VN BY: E. DAVIS	DATE: 09-25-2023	PROJ NO: 1398:
WRIGHT-PIERCE	APPR	OVED BY: D. HOPKINS	REFERENCE DWG:	D-4

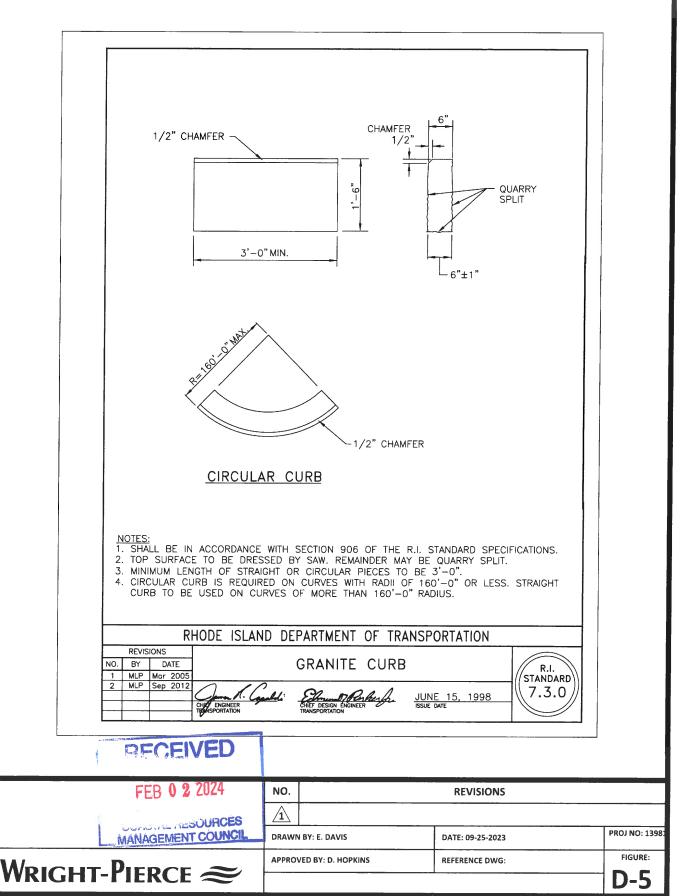

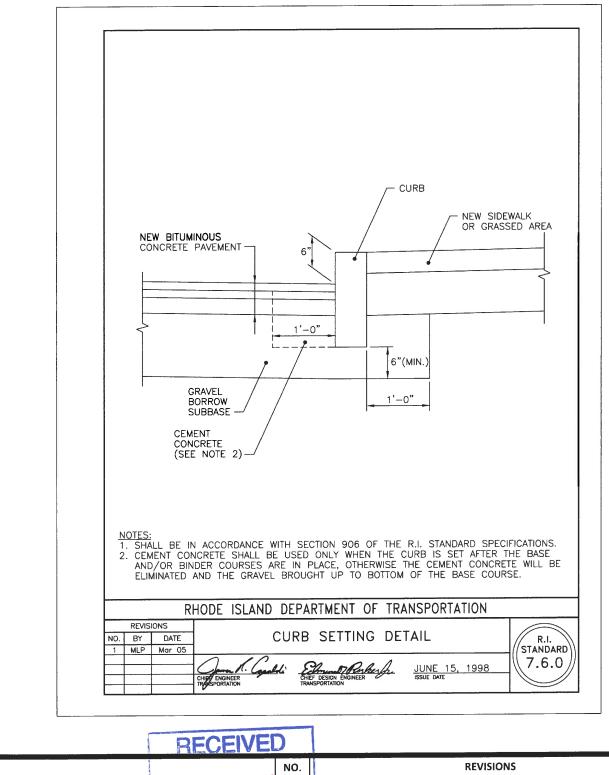


RECEIVED		
NO.	REVISIONS	
FEB 0 2 2024 <u>1</u>		
COASTAL RESOURCESAWN BY:	E. DAVIS DATE: 09-25-2023	PROJ NO: 1398
MANAGEMENT COUNCE	BY: D. HOPKINS REFERENCE DWG:	FIGURE:
WRIGHT-PIERCE \approx		D-6
WRIGHT-PIERCE	BY: D. HOPKINS REFERENCE DWG:	FIGURE:

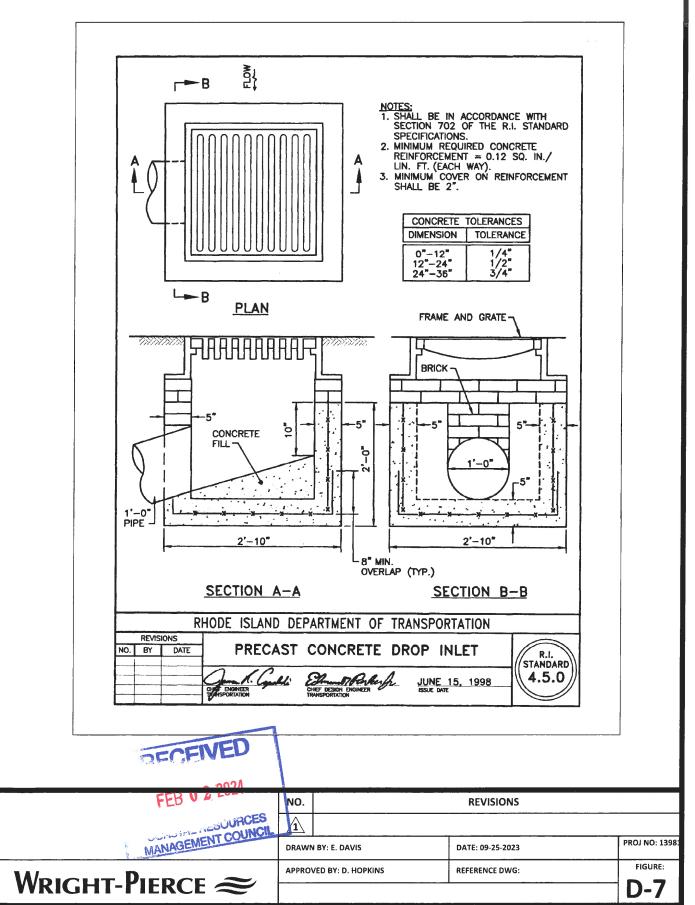


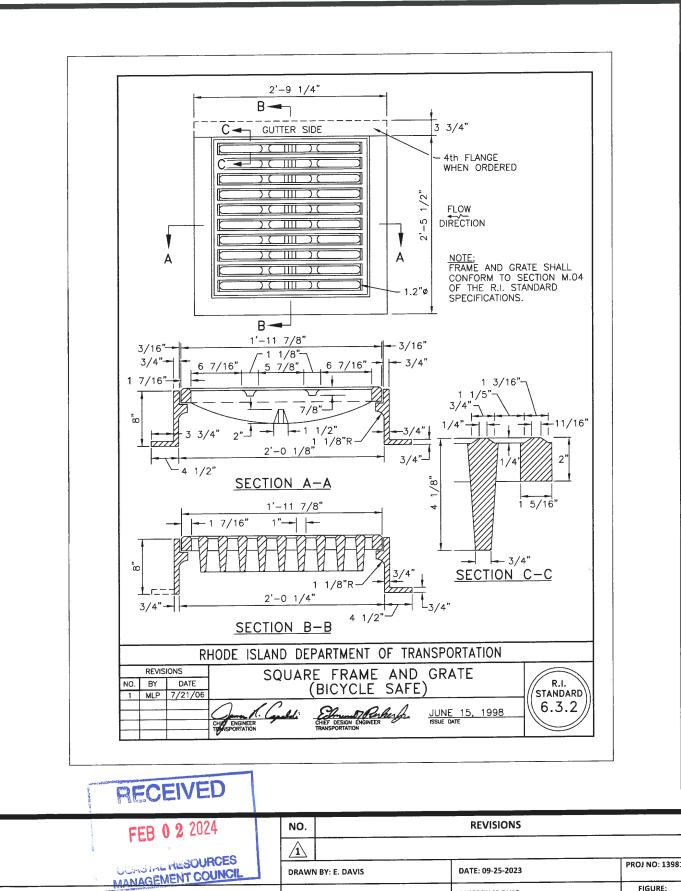



APPROVED BY: D. HOPKINS

REFERENCE DWG:

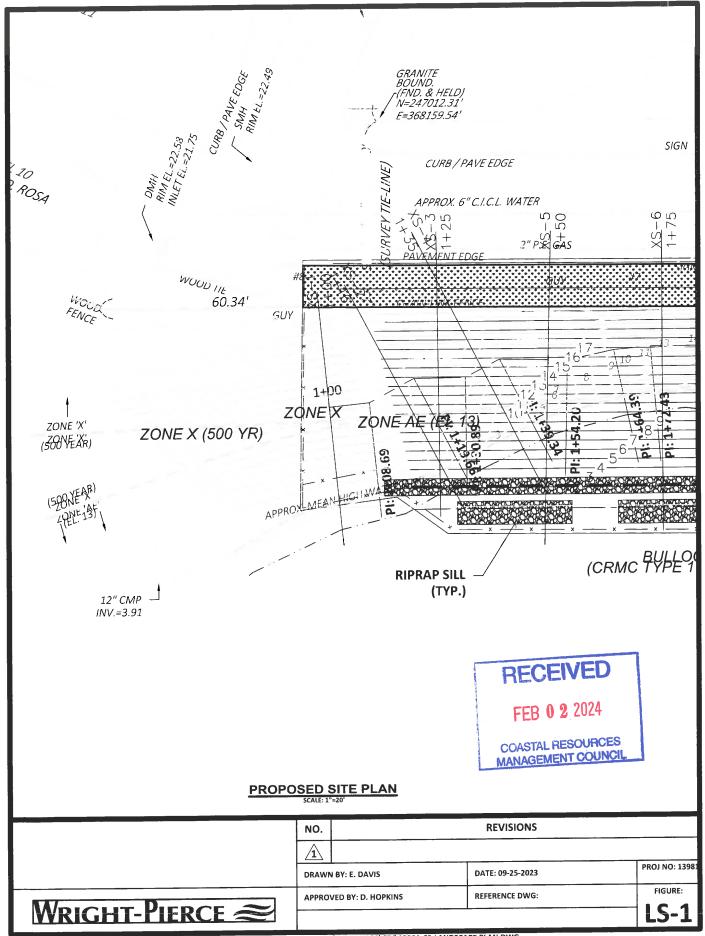

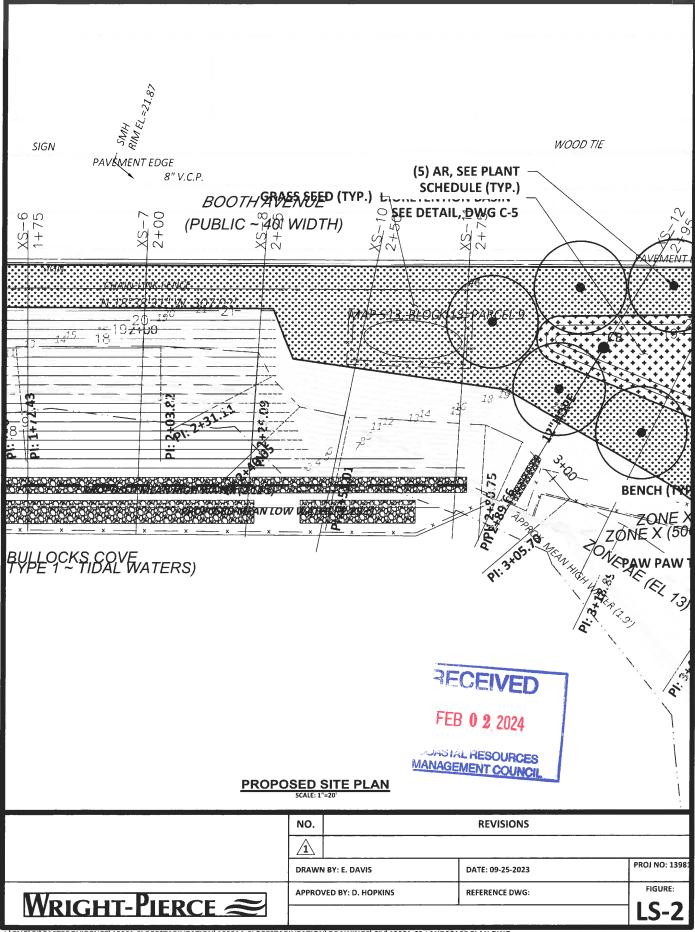

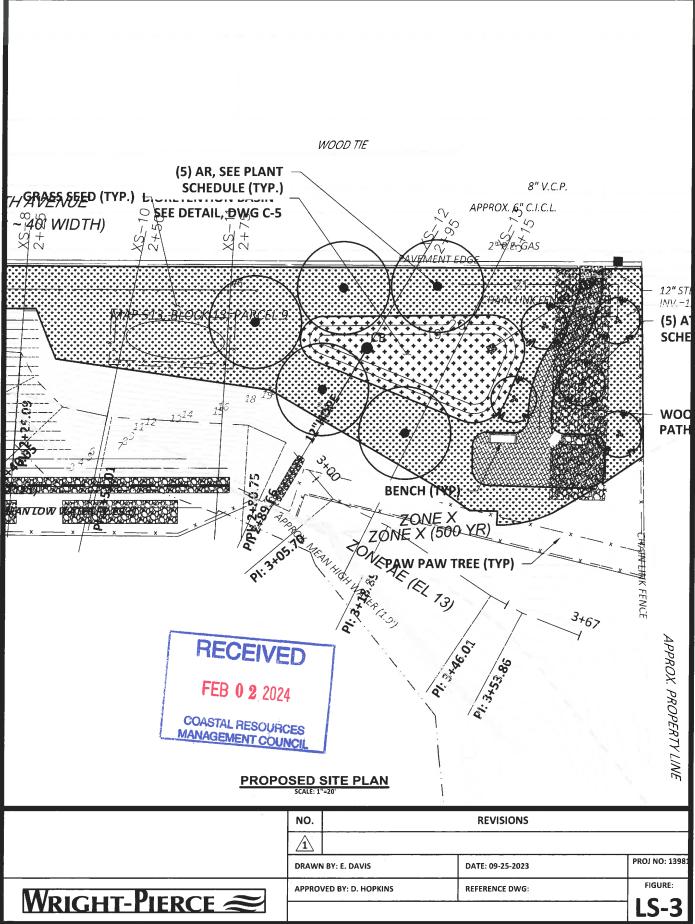

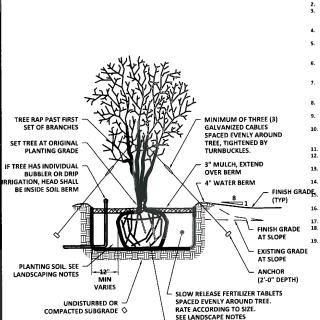

PLANTING NOTES:

- ALL NEW PLANT MATERIAL SHALL CONFORM TO THE REQUIREMENTS AS ESTABLISHED BY THE AMERICAN ASSOCIATION OF NURSERYMAN, LATEST EDITION. IN ADDITION, ALL NEW PLANT MATERIAL FOR THE PROJECT SHALL BE OF THE HIGHEST SPECIMEN QUALITY.

 SEE SPECIFICATIONS FOR TREMS NOT COVERED ON THE PLANS AND DETAILS.

 CONTRACTOR SHALL INSPECT SITE PRIOR TO BEGINNING PLANTING OPERATIONS AND NOTIFY THE ENGINEER OF ANY CONDITIONS THAT ARE NOT SUITABLE TO PERFORMING PLANTING OPERATIONS. CONTRACTOR SHALL NOTIFY THE ENGINEER OF ANY CONDITIONS THAT WOULD PREVENT HEALTHY GROWTH OF PLANT MATERIAL.

 NO TREES SHALL BE PLANTED BEFORE ACCEPTANCE OF ROUGH GRADING. TREES SHALL BEAR SAME RELATIONSHIP TO FINISH GRADE AS THEY BORE TO PREVIOUS GRADE.

 PLANT GROUPING AND LOCATIONS ARE DIAGRAMMATIC. THE LOCATION OF PLANTS SHALL BE APPROVED IN THE FIELD BY THE LANDSCAPE ARCHITECT SHALL BE REPLACED AS DIRECTED BY THE LANDSCAPE ARCHITECT SHALL BE REPLACED AS DIRECTED BY THE LANDSCAPE ARCHITECT SHALL BE REPLACED AS DIRECTED BY THE LANDSCAPE ARCHITECT SHALL BE REPLACED AS DIRECTED BY THE LANDSCAPE ARCHITECT SHALL BE REPLACED AS DIRECTED BY THE LANDSCAPE ARCHITECT SHALL BE APPROVED IN THE FIELD BY THE LANDSCAPE ARCHITECT SHALL BE APPROVED IN THE FIELD BY THE LANDSCAPE ARCHITECT SHALL BE APPROVED IN THE FIELD BY THE LANDSCAPE ARCHITECT SHALL BE APPROVED IN THE FIELD BY THE LANDSCAPE ARCHITECT. AND LONG THE SHALL BE HEALED-IN AT A SHADY LOCATION UNTIL PLANTING AREA IS PREPARED FOR INSTALLATION. ANY PLANTS REMAINING UNPLANTED ON THE SITE FOR MORE THAN 28 HOURS SHALL BE PROTECTED AND MAINTAINED INCLUDING BUT NOT LIMITED TO WATER AND SHADE. DAMAGED ON STRESSED PLANTS SHALL BE REPLACED AT THE CONTRACTOR SEPENSE.

 THERE WILL BE NO SUBSTITUTIONS OF PLANT MATERIAL WITHOUT PRIOR WRITTEN APPROVAL BY THE LANDSCAPE ARCHITECT. ANY PROPOSED THE SECRET SHALL BE MADE WITH PLANTS OF EQUIVALENT OVERALL FORM HEACH, BEART, FLOWER, LEAF, COLD, FRUIT AND CULTURE ONLY AS APPROVED BY THE LANDSCAPE ARCHITECT/SIGNEER.

- UTATORINGS. THE CONTRACTOR SHALL MAINTAIN ALL PREPARED PLANTING AREAS FREE FROM DEBRIS. NO STORAGE OR STOCKPILING SHALL OCCUR ON PLANTIN
- THE CONTRACTOR SHALL MAINTAIN ALL PLEPARED PLANTING AREAS PREE FROM CERRIS. STOKKED ON STOKE OF THE CONTRACTOR IS TO USE CARE DURING EXCAVATION AND PLANTING TO AVOID DISTURBING OR DAMAGING ANY ADJACENT CONSTRUCTION SHALL BE THE CONTRACTOR'S RESPONSIBILITY AND SHALL BE RESTORED AT HIS EXPENSE TO THE SATISFACTION OF THE OWNER.

 STAKE LOCATION OF ALL PROPOSED PLANTING FOR APPROVAL BY THE LANDSCAPE ARCHITECT/ENGINEER PRIOR TO COMMENCEMENT OF PLANTING. THE CONTRACTOR SHALL SUPPLY PLANT MATERIAL IN THE QUANTITIES INDICATED ON THE PLANS, FOR DISCREPANCIES BETWEEN THE PLANS AND THE PLANT SHOULE, THE PLAN QUANTITIES SHALL PREVAIL.

 ALL PLANT MATERIAL IN CONTAINERS SHALL BE WELL ESTABLISHED ROOTED MATERIAL THAT OCCUPIES THE ENTIRE VOLUME OF SPECIFIED CONTRAINER.

- CONTAINER.
 PLANTS WITH GIRDLING ROOTS SHALL BE REJECTED. CONTAINER GROWN PLANTS WITH TIGHT ROOT MASSES SHALL BE SCARIFIED PRIOR TO


- PLANTING.
 THE TREE ROOT FLARE SHALL BE EXPOSED AND PLANTED EVEN WITH THE FINISH GRADE. PREPARE ALL TREE PITS WITH PLANTING SOIL TO A
 MINIMUM DEPTH MATCHING THE OEPTH OF TREE ROOT BALLS.
 ALL PLANT REGO ARE TO RECEIVE THERE HINCHES (3") OF SHREDDED BARK MULCH AS SPECIFIED. NO SEPARATE PAY ITEM FOR MULCH OR AND/OR
 FERTILIZER PACKETS. PAID FOR UNDER PLANTING ITEMS.
 ALL EXISTING THESE TO REMAIN SHALL BE PROPEREDLY PROTECTED, PRUNED AND FERTILIZED PER THE SPECIFICATIONS.
 ALL LEXISTING THESE TO REMAIN SHALL BE PROPEREDLY PROTECTED, PRUNED AND FERTILIZED PER THE SPECIFICATIONS.
 ALL LAWN AREAS DISTURBED BY CONSTRUCTION OPERATIONS INSIDE AND OUTSIDE THE UNIT OF WORK SHALL BE LOAMED AND SEEDED AS
 SPECIFIED. ALL AREAS TO BE SEEDED SHALL RECEIVE SOIL PREPARATION AS SPECIFIED PRIOR TO SEEDING, UNLESS OTHERWISE NOTED ON PLAN.
 ALL AREAS TO BE SEEDED WITH GRASS SEED MIX SHALL RECEIVE 6" TOPSOIL PRIOR TO SEEDING.

- NOTES:

 1. APPLY ANTI-DESICCANT PRIOR TO PLANTING.
- 2. STAKING METHOD FOR TREES UNDER 10' MAY BE SUBSTITUED FOR GUY WIRE METHOD.
 3. PIT SHOULD BE THREE TIMES DIAMETER OF ROOTBALL.

TREE INSTALLATION: MULTI-STEM SCALE: NTS

ROPES AT TOP OF BALL SHALL BE CUT, TOP 1/3 OF BURLAP REMOVED. NON-BIODEGRADABLE MATERIAL SHALL BE TOTALLY REMOVED

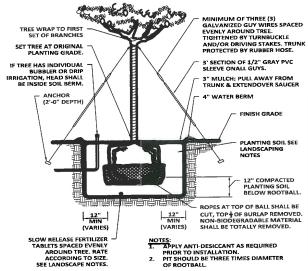


PLANTING SCHEDULE

SYMB.	QTY	BOT. NAME	COMMON NAME	SIZE	ROOT	COMMENTS		
FRUIT	TREES							
AT	5	ASIMINA TRILOBA	PAWPAW	7'-8' HT	B&B	SINGLE STEM, FULL, HEAVY, MATCHED		
DECI	DUOUS TREE	S	-					
AR	5	ACER RUBRUM	RED MAPLE	2 1/2"-3" CAL.	B&B	SINGLE STEM, FULL, HEAVY, MATCHED		
BRUS	H BRANCHE	S FOR SLOPE STABILIZATION						
	200	CEPHALANTHUS OCCIDENTALIS	BUTTONBUSH	3' BRANCH	BARE ROOT	PLANT IN FALL, 3' O.C		
	200	SALIX DISCOLOR	PUSSY WILLOW	3' BRANCH	BARE ROOT	PLANT IN FALL, 3' O.C		
	200	VIBURNUM DENTATUM	ARROWWOOD	3' BRANCH	BARE ROOT	PLANT IN FALL, 3' O.C		
SEED	& LOAM							
	800 SF	BIORETENTION SEED MIX	SEE SPECIFICATION	IS				
	4.600 SF	GRASS SEED MIX	SEE SPECIFICATIONS					

TREE INSTALLATION: 10' AND TALLER


REVISIONS NO. **/1**\ PROJ NO: 1398: DATE: 09-25-2023 DRAWN BY: E. DAVIS FIGURE: REFERENCE DWG: APPROVED BY: D. HOPKINS _S-4



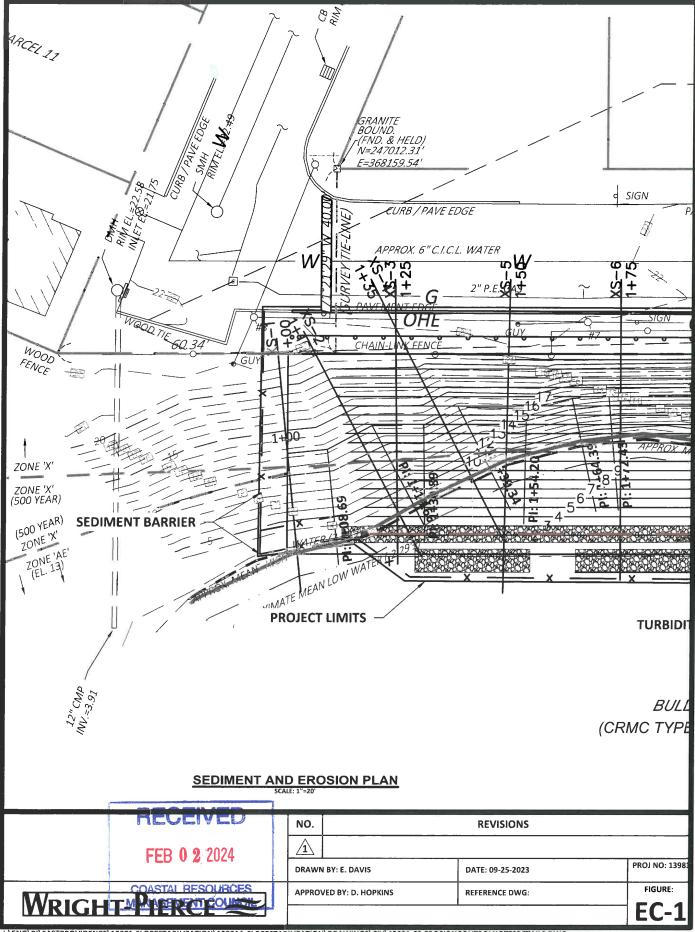

77.87			
SIGN 83787		WOOD TIE	
PAVEMENT EDGE		Ħ.	
8" V.C.P. BOOTH AVE	S	S	
BOOTH AVE	T STOCKPILE TO S	17.7 17.7 W	∵ ∿. CON
ST SEDIMEN	→ Yv G	2+72	PATTMENT
OHE OHE	OHE /	CHAIN-LINK FENCE	/ QH
N 18 3 31 W 307 6 20		1	2
192100 15	*	P 513, BLOCKOTS PAROLE	9 19
10	T X X		
APPROX MEAN HIGH WAYER IN A			X
8			-/ }
			X
TX X X X X X X X X X X X X X X X X X X	X X	En May	
	1	PI: 310 SEDIMEN	
TURBIDITY CURTAIN —		SEDIMEN'	T BARRIER
		1. The state of th	
BULLOCKS COVE		*	
(CRMC TYPE 1 ~ TIDAL WATERS)			
RECEIVED STA	D EROSION PLAN LE: 1"=20"		
FEB 0 2 2024	NO.	REVISIONS	
	À	T	PROJ NO: 13981
COASTAL RESOURCES MANAGEMENT COUNCIL	DRAWN BY: E. DAVIS APPROVED BY: D. HOPKINS	DATE: 09-25-2023 REFERENCE DWG:	FIGURE:
Wright-Pierce ≈			EC-2

NT STOCKPILE TO G	N-LINK FENCE	S APPROX. 6" C.I.C.L W. CTION ANCE 2" P.E. GAS -21	ZONE
CHAIR	SEDIMENT BARRIER	CH NI LINK FENCE	N NEYE N NEYE N NEYE N NEYE N NEYE N NEYE N N N N N N N N N N N N N N N N N N N
COASTAL POR	À		
COASTAL RESOURCES MANAGEMENT COUNCIL	DRAWN BY: E. DAVIS	DATE: 09-25-2023	PROJ NO: 13981
WRIGHT-PIERCE \approx	APPROVED BY: D. HOPKINS	REFERENCE DWG:	EC-3

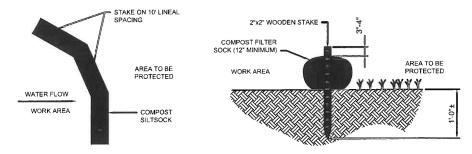

NOTES:

- 1. COMPOST/ SOIL/ ROCK/ SEED FILL TO MEET APPLICATION REQUIREMENTS.
- 2. COMPOST MATERIAL TO BE REMOVED OR DISPERSED ON SITE AS DETERMINED BY
- IF SOCK NETTING MUST BE JOINED, FIT BEGINNING OF NEW SOCK OVER END OF OLD SOCK, OVERLAPPING BY 2 FEET AND STACK OVERLAP. IF SOCK NETTING IS NOT JOINED, OVERLAP OLD SOCK WITH NEW ONE BY MINIMUM OF 2 FEET.

SEDIMENT BARRIER

- ALL SEDIMENT AND EROSION CONTROL MEASURES SHALL BE IMPLEMENTED IN ACCORDANCE WITH THE RHODE ISLAND SOIL EROSION AND SEDIMENT CONTROL HANDBOOK, LATEST EDITION.
- EROSION AND SEDIMENTATION CONTROLS SHOWN ON THE PLANS ARE INTENDED TO REPRESENT THE MINIMUM CONTROLS NECESSARY TO MEET ANTICIPATED SITE CONDITIONS. ADDITIONAL MEASURES SHALL BE IMPLEMENTED AS CONDITIONS WARRANT OR AS DIRECTED BY THE OWNER OR OWNERS REPRESENTATIVE.
- THE CONTRACTOR SHALL UPDATE THE SESC, AND PERFORM THE REQUIRED INSPECTION AND REPORT KEEPING ACTIVITIES OF THE SESC.
- THE CONTRACTOR SHALL INSTALL EROSION CONTROLS PRIOR TO COMMENCING WORK
- THE CONTRACTOR SHALL PROVIDE DUST CONTROL VIA ON-SITE WATER TRUCK OR OTHER APPROVED METHODS.
- THE CONTRACTOR SHALL PROVIDE CONCRETE WASHOUT AREAS.
- THE CONTRACTOR SHALL MAINTAIN CONSTRUCTION ENTRANCES (ANTI-TRACK PADS) AT ALL POINTS OF INGRESS AND EGRESS TO THE SITE.
- WATER FROM DEWATERING OPERATIONS SHALL BE PUMPED UPGRADIENT TO A MINIMUM STRAW-BALE ENCLOSURE OR OTHER APPROVED DEVICE, ALL DEWATERING SHOULD BE IN CONFORMANCE WITH THE RHODE ISLAND SOIL EROSION AND SEDIMENT CONTROL HANDBOOK, LATEST EDITION.
- CONTRACTOR SHALL CONTAIN AND DISPOSE OF SITE-WASTE CONSISTENT WITH LOCAL, STATE, AND FEDERAL REGULATIONS
- CONTRACTOR SHALL FURNISH INSTALL, AND MAINTAIN SILT SACKS IN ALL EXISTING AND NEWLY INSTALLED CATCH BASINS UNTIL THE UPSTREAM AREA IS STABILIZED. 10.
- THE CONTRACTOR SHALL MAINTAIN EROSION CONTROLS THROUGHOUT CONSTRUCTION. THE CONTRACTOR SHALL REPLACE DAMAGED EROSION CONTROLS AT THE OWNER OR OWNERS REPRESENTATIVES REQUEST AT NO ADDITIONAL EXPENSE TO THE OWNER.
- THE CONTRACTOR SHALL NOT LEAVE DISTURBED AREAS UNSTABILIZED FOR PERIODS MORE THAN 14 DAYS. PROVIDE TEMPORARY SEED OR MULCH ON DISTURBED AREAS THAT REMAIN EXPOSED FOR GREATER THAN 14 DAYS.
- INSTALL EROSION CONTROLS DOWNSTREAM OF ANY DISTURBED AREAS TO REDUCE POTENTIAL FOR EROSION. CONTRACTOR SHALL INDICATE LOCATIONS OF EROSION CONTROL FOR REVIEW WITH GENERAL CONTRACTOR AND OWNERS REPRESENTATIVE PRIOR TO COMMENCING WORK. 13.
- CONTRACTOR SHALL BE RESPONSIBLE FOR VERIFICATION OF EXISTING CONDITIONS
- 15, ALL TEMPORARILY CUT UTILITIES SHALL BE PROTECTED FROM SEDIMENTATION UNTIL CONNECTED TO POST-CONSTRUCTION POSITION.
- EXCESS TOPSOIL AND SEDIMENT CAPTURED IN EROSION CONTROL MEASURES SHALL BE STOCKPILED ON SITE AND SEEDED. 16.
- 17. CONTRACTOR TO PROVIDE TEMPORARY CONSTRUCTION FENCE.
- ALL TEMPORARY EROSION CONTROL MEASURES SHALL BE REMOVED ONCE THE WORK AREA HAS BEEN STABILIZED.
- CONTRACTOR SHALL CLEAN DEBRIS AND SOIL FROM ALL CATCH BASINS AND DRAINS AFTER SITE STABILIZATION AND PRIOR TO SITE ACCEPTANCE.

15'-0" MAX PROVIDE TEMPORARY SEED (SEE NOTE 2) COMPOST FILTER SOCK ENCIRCLING TOE 60'-0" MAX

SEDIMENT STOCKPILE
SCALE: NTS

NOTES:

- STOCKPILE AREA SHALL NOT EXCEED SPECIFIED DIMENSIONS WITHOUT APPROVAL
- 2. STOCKPILED ERODIBLE MATERIAL THAT WILL NOT BE USED FOR GREATER THAN 14 DAYS SHALL BE STABILIZED WITH TEMPORARY SEED IMMEDIATELY FOLLOWING PLACEMENT, USE RIDOT STD. M.18.10.5 SEED MIX.

	NO.	REVISIONS	-
	/ı̀		
	DRAWN BY: E. DAVIS	DATE: 09-25-2023	PROJ NO: 1398
Molecus Disper	APPROVED BY: D. HOPKINS	REFERENCE DWG:	FIGURE:
WRIGHT-PIERCE \approx			EC-4