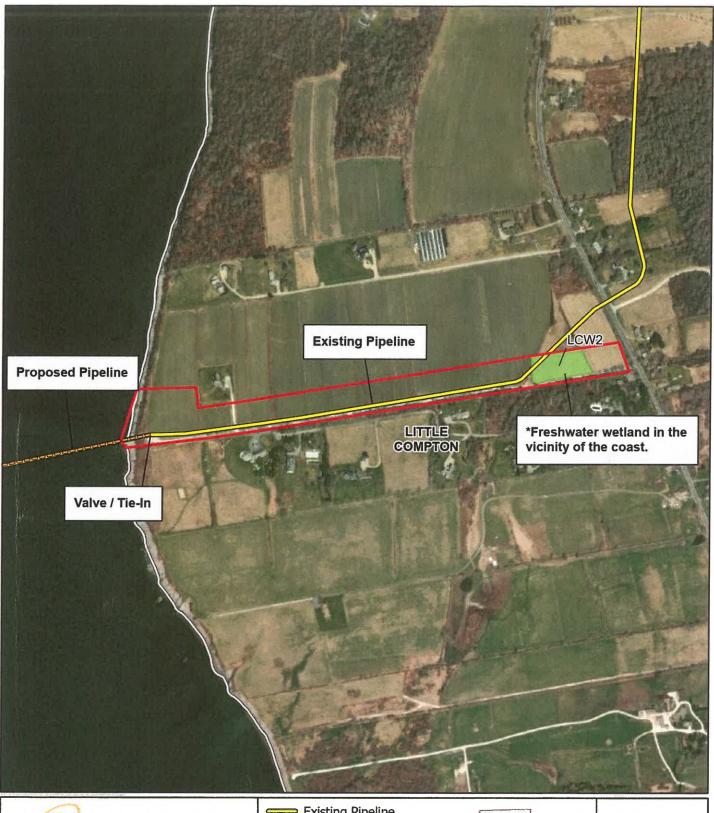


# **APPENDIX A**

Mapping

Constal Resource of Marcan Council
Authorised Planc
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NATURAL RESOURCE DELINEATION MAP EAST BANK

> TIVERTON QUADRANGLE LITTLE COMPTON, RI

Existing Pipeline
Proposed Pipeline
Delineated Wetland
Area


Project Area


Municipal Boundary



ENVIRONMENTAL CONSULTANTS

1:7,200
Created By S. McCinney
Project Humber 98 190
NAO 1683 2011 Steel-Pane Rhode Island RPS 300 R US

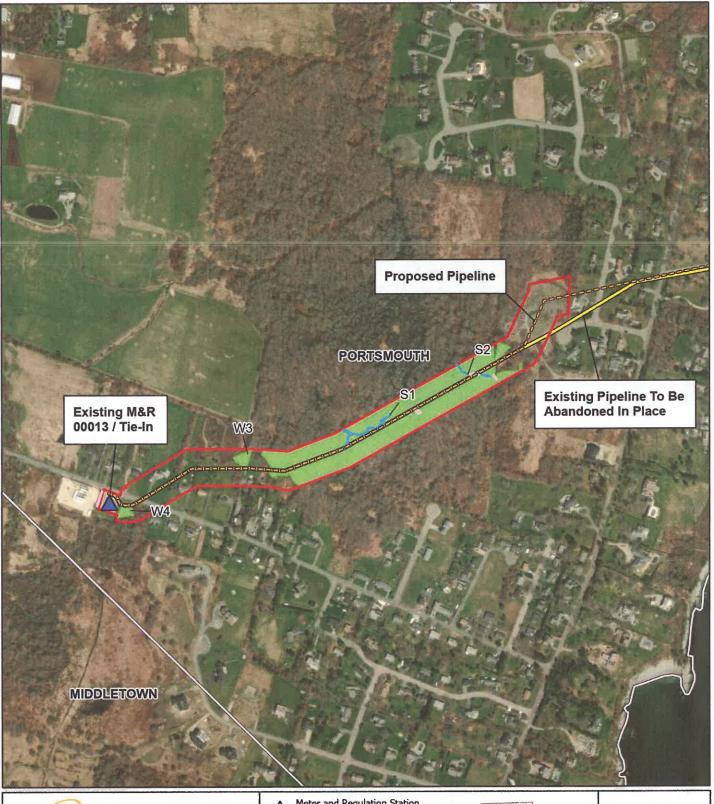

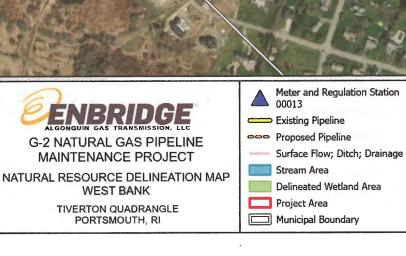



ENVIRONMENTAL CONGULTANTS


1:6,000

Characty & Moderney
Franch National end 5:300 Fills

0 507 Fills Street

1:00 Fills


1:00

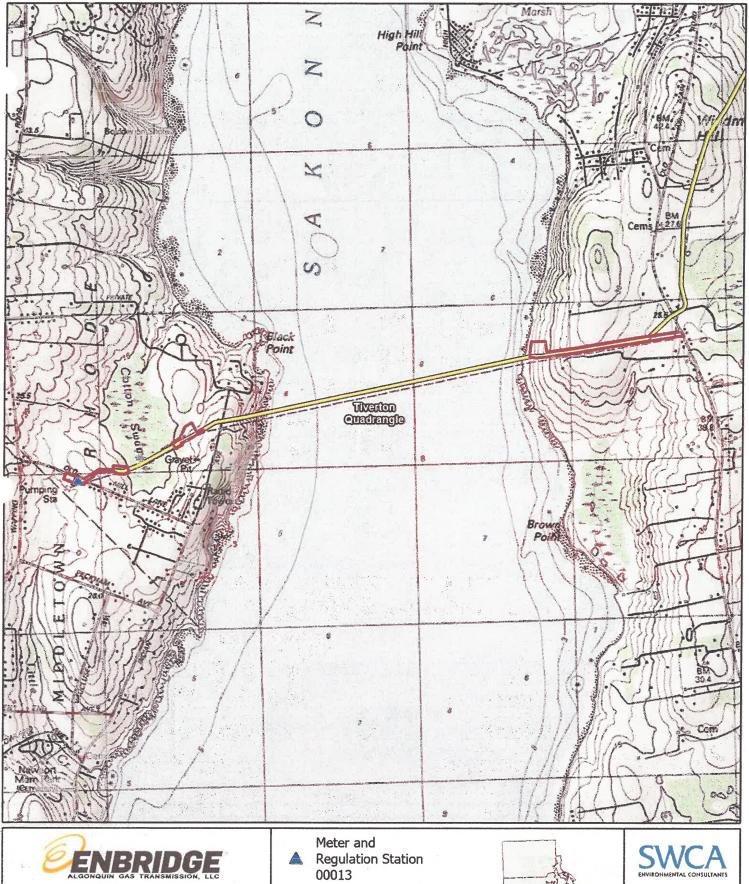



**USGS TOPOGRAPHIC MAP** 

TIVERTON QUADRANGLE PORTSMOUTH AND LITTLE COMPTON, RI

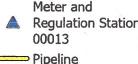









NATURAL RESOURCE MAP EAST BANK

> TIVERTON QUADRANGLE LITTLE COMPTON, RI

- Pipeline



Project Area

Municipal Boundary





Page: 1 of 2

1:3,600 Cheated By: S. Molitimey Project Humber: 68136



(CO) 202 Post -






NATURAL RESOURCE MAP EAST BANK

> TIVERTON QUADRANGLE LITTLE COMPTON, RI




Municipal Boundary

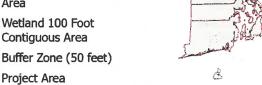



1:3,600 Challed By: 9, McKinney Poject Number: 68136 Case, 9714/2023 AND 1983 2211 State Plane Rhode Isl



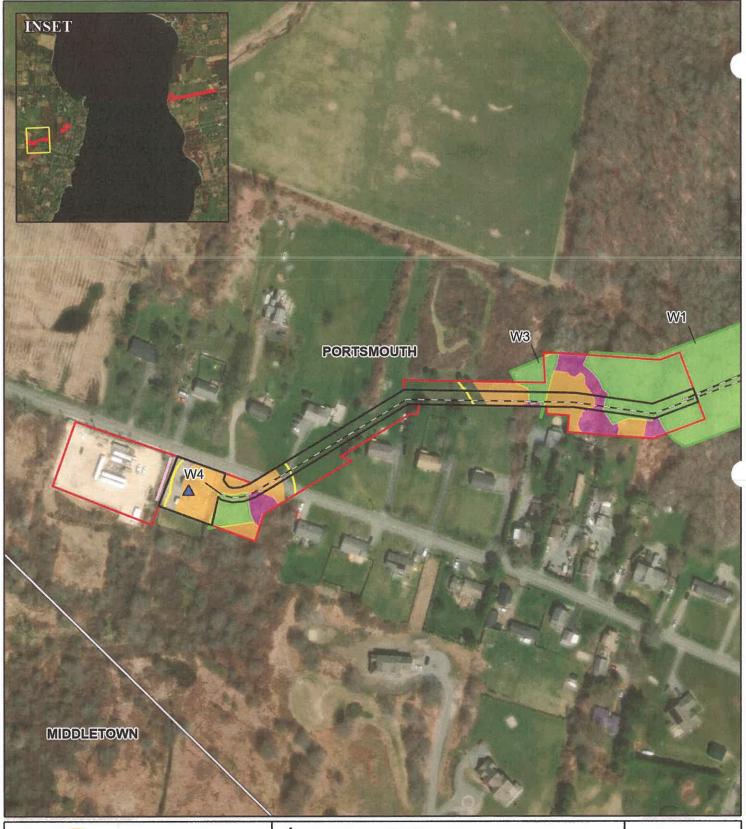



NATURAL RESOURCE MAP WEST BANK

> TIVERTON QUADRANGLE PORTSMOUTH, RI



Pipeline Right-of-Way





Page: 1 of 2 1:2,400



stated By 3, McKonney

genet Number 18 6130

see, 10/16/3022

LO 1983 20/11 StatePlane Rhode Island FIPS 3860 Pt US

100 20/1983 20/15 StatePlane Rhode Island FIPS 3860 Pt US

100 200 6





NATURAL RESOURCE MAP **WEST BANK** 

**TIVERTON QUADRANGLE** PORTSMOUTH, RI

Pipeline Surface Flow; Ditch Stream Area Delineated Wetland Area Buffer: undeveloped, undisturbed vegetation within Buffer Zone Buffer Zone (50 feet) Stream 100 Foot Contiguous Area Wetland 100 Foot Contiguous Area




Page: 2 of 2 1:2,400





-	Set 70 (	StatePane Phot	e 1912/70	LILO 1810	200
_		100		200	fez:
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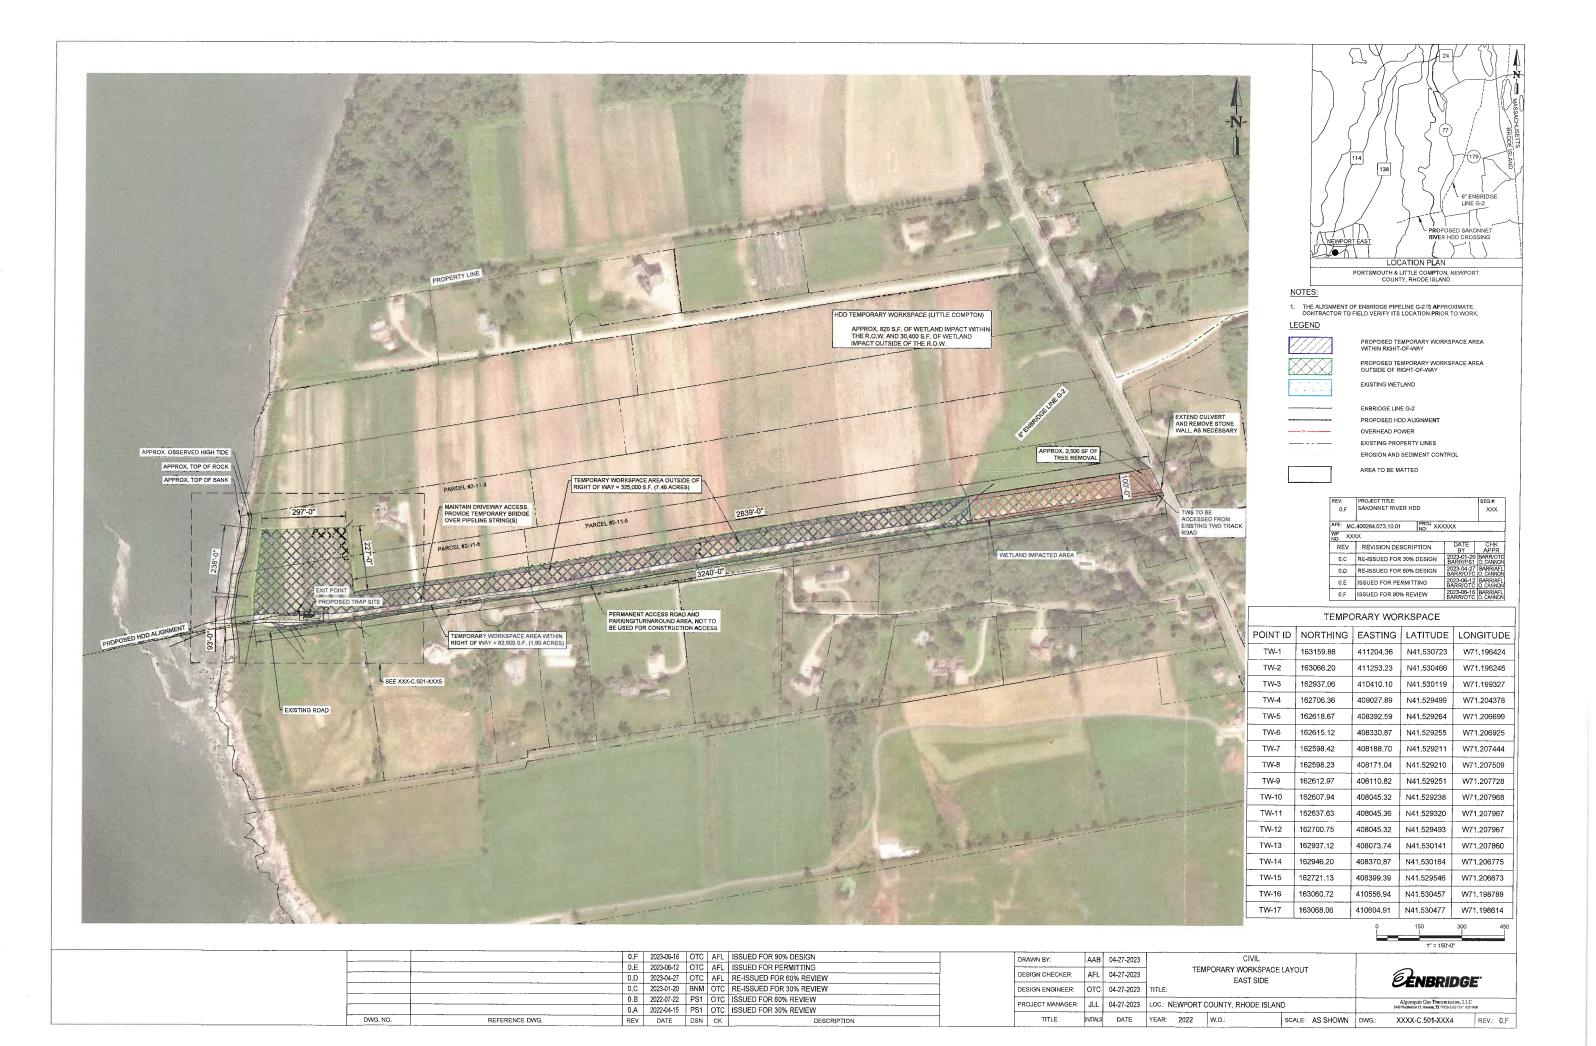
Municipal Boundary Temporary Workspace Pipeline Right-of-Way


Attachment B Project Drawings




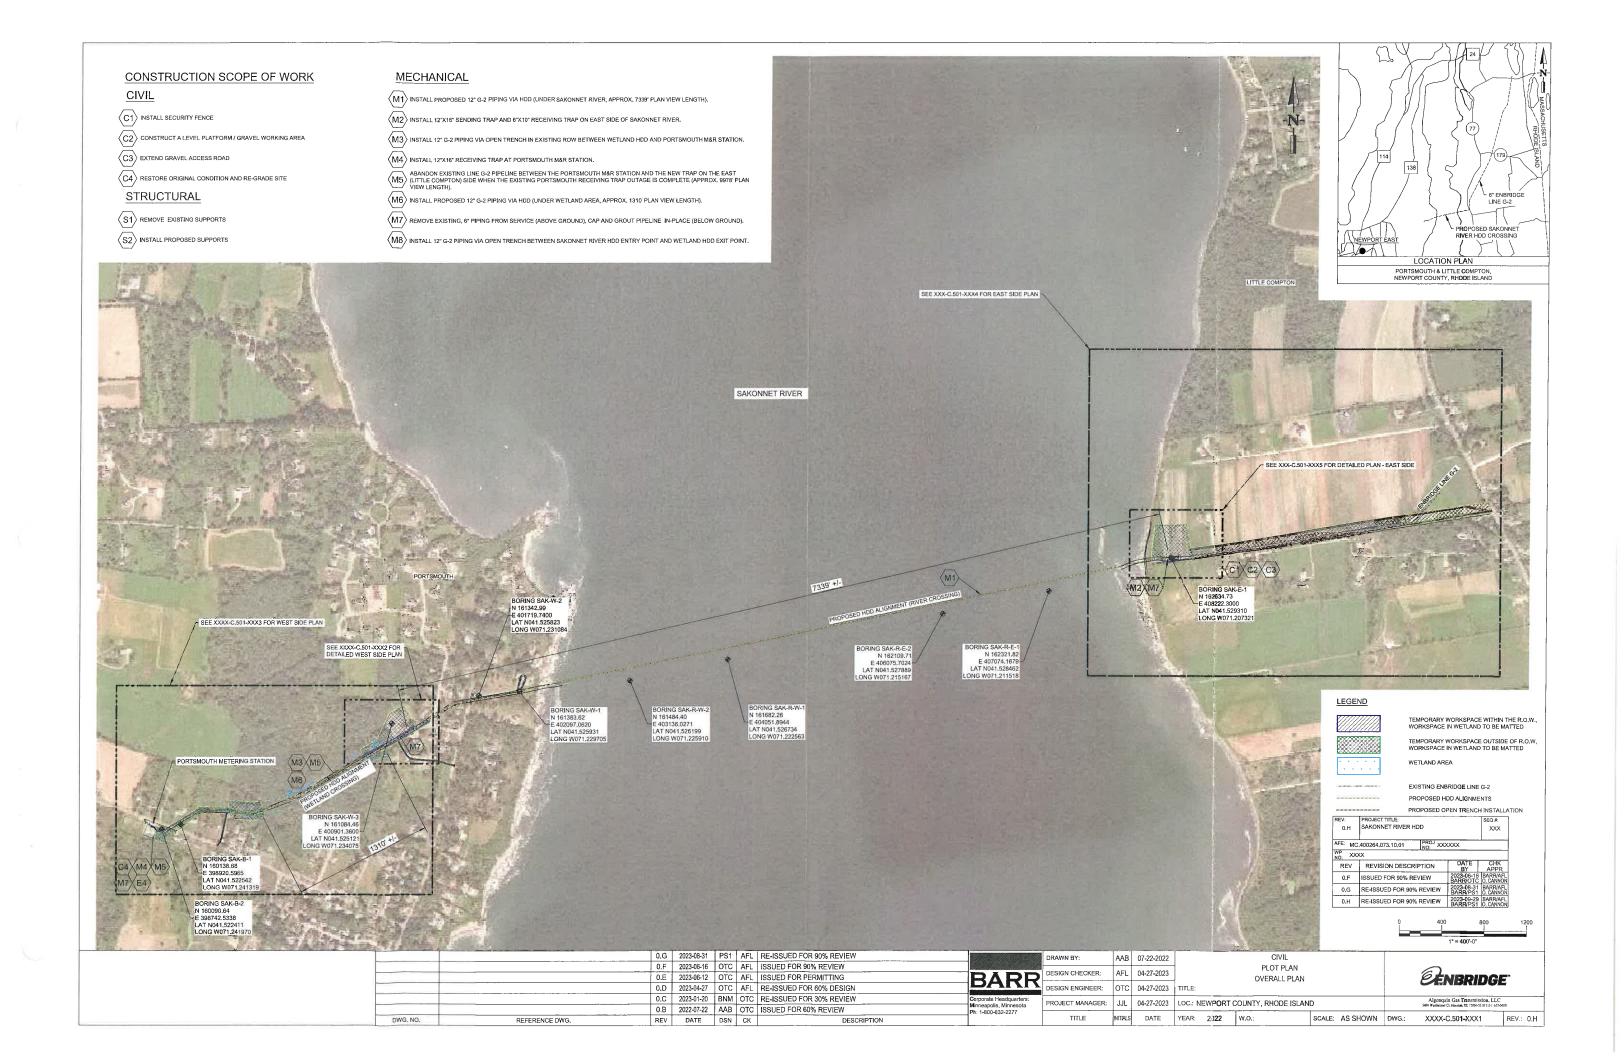

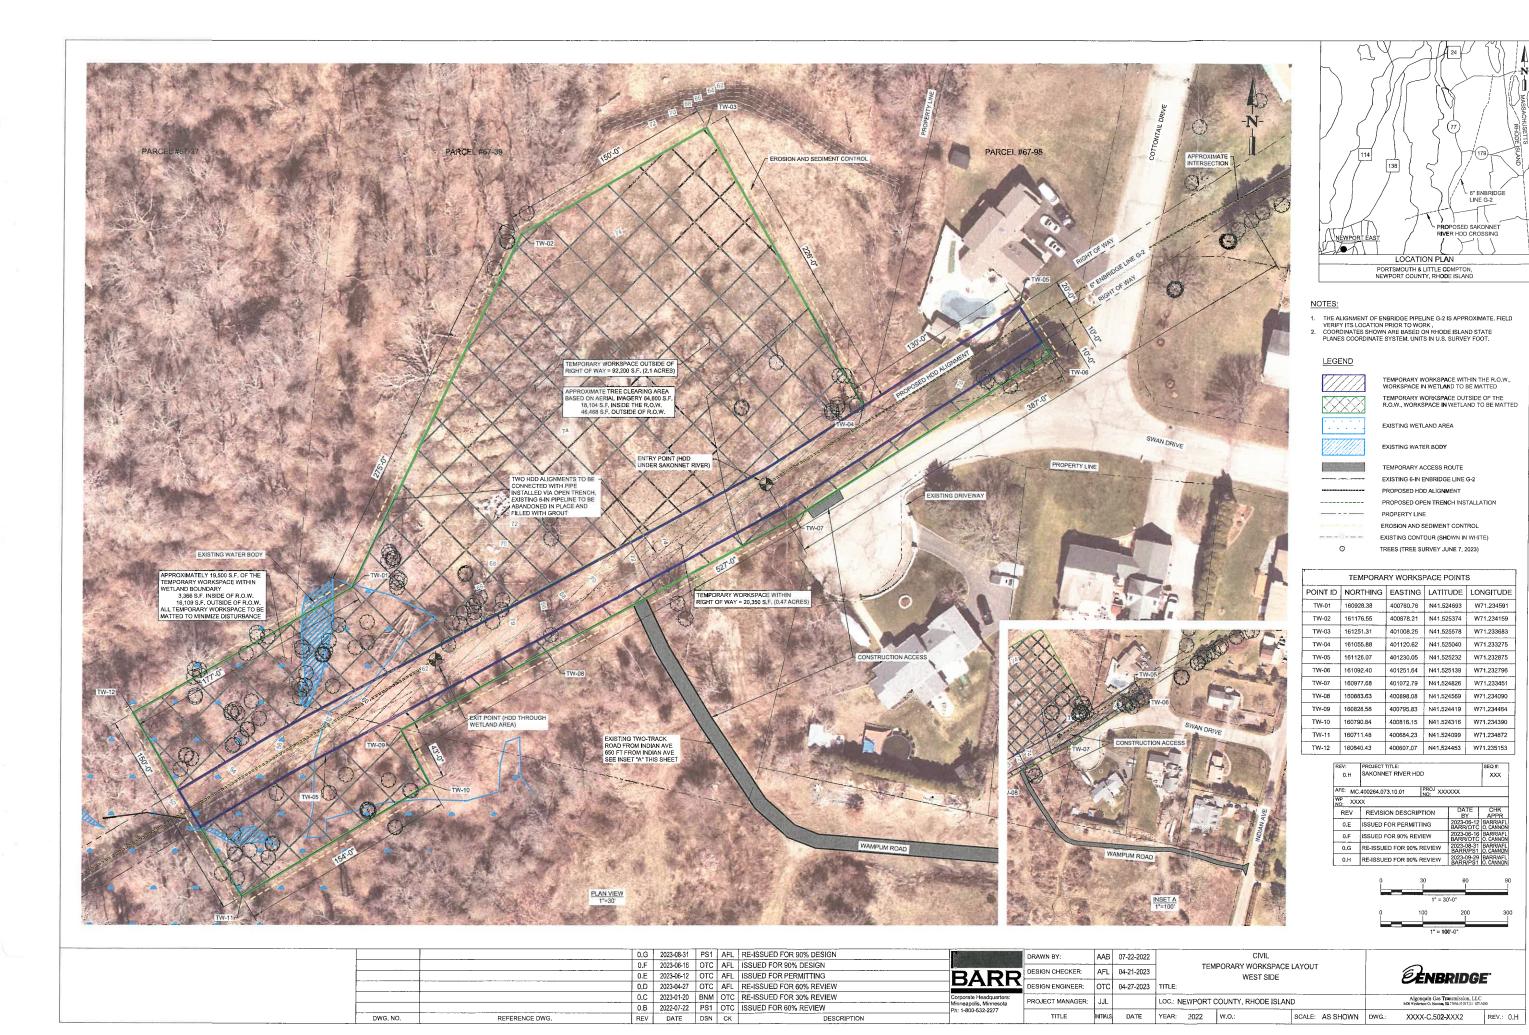

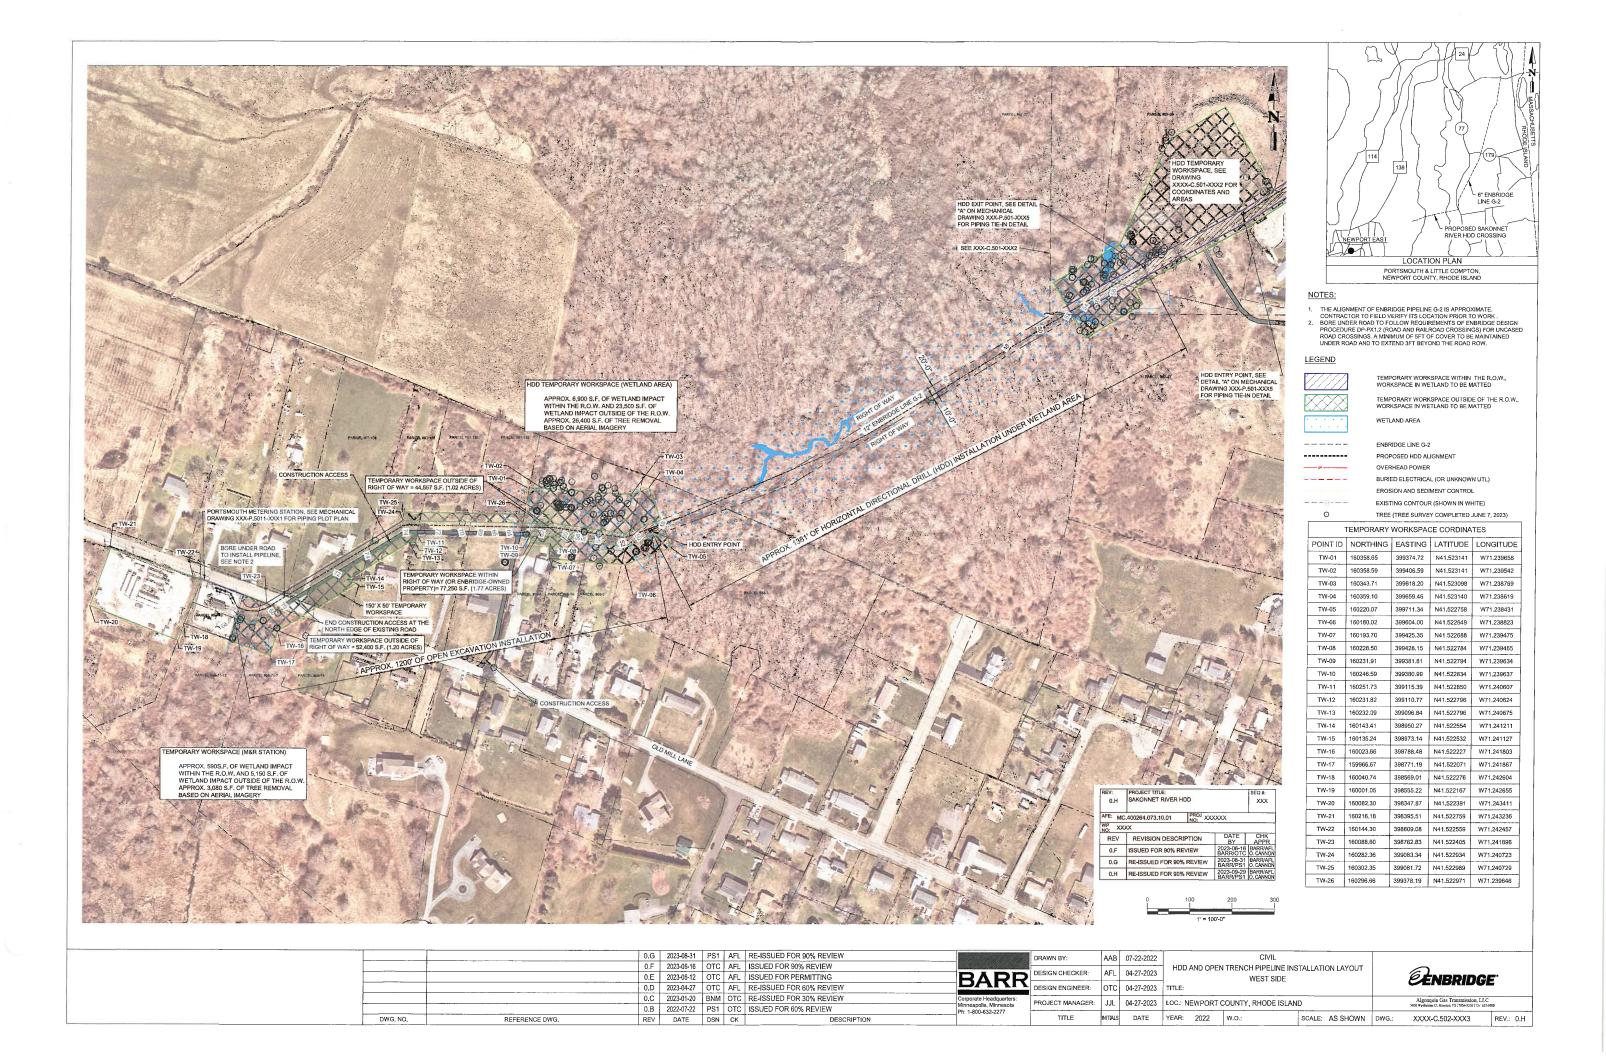

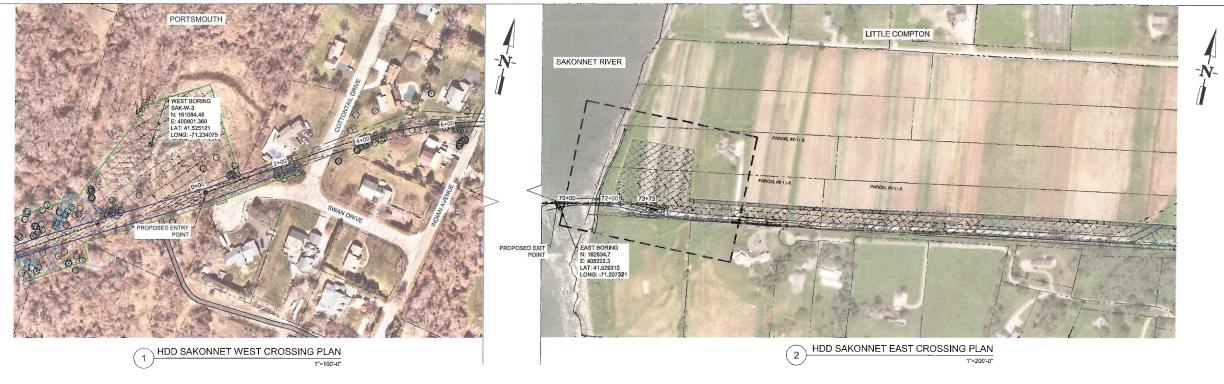

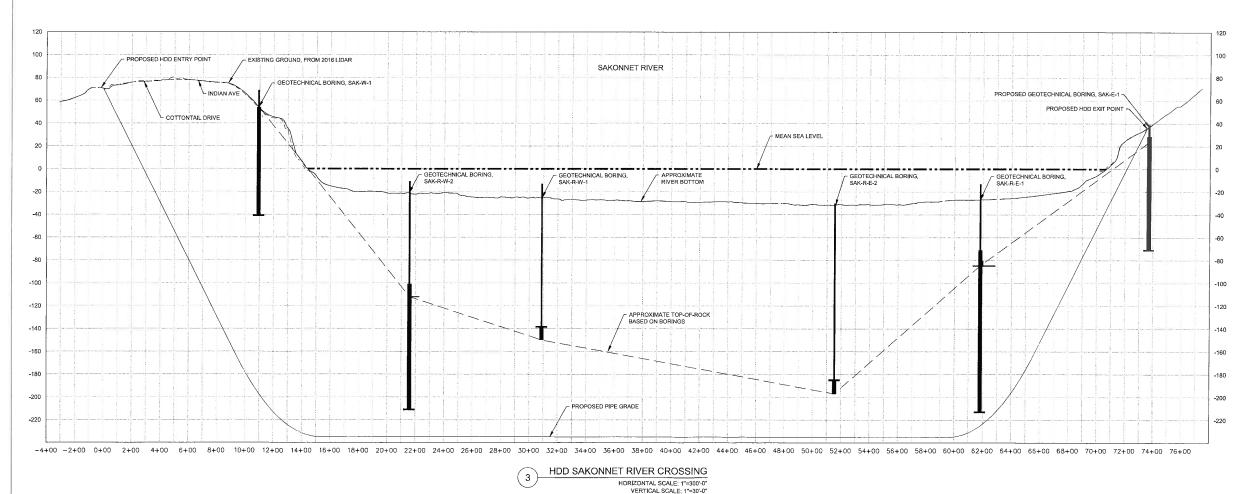

### LEGEND:

APPROXIMATE EXISTING PIPELINE

PROPOSED HDD ALIGNMENT


XXXXXX PROPOSED TEMPORA

PROPOSED TEMPORARY WORK SP.
WETLAND

CONSTRUCTION NOTES:


- THIS DRAWING REPRESENTS A GENERAL GRAPHIC SUMMARY OF THE WORK. WORK INCLUDES BUT IS NOT LIMITED TO WHAT IS DESCRIBED, FOR DETAILS REFER TO DRAWINGS AND PROJECT SPECIFICATIONS.
- 2. CONTOURS SHOWN WERE OBTAINED FROM USGS LIDAR SURVEY OBTAINED IN 2011, BATHYMETRIC DATA OF SAKONNET RIVER COLLECTED BY ONYS SERVICES 6082021 TIED TO ANDABS RHODE ISLAND STATE PLANE NAVDBS US SURVEY FOOT. CONTRACTOR TO YERRY EXISTING CONDITIONS PRIOR TO COMMENCINE WORK.
- CONTRACTOR IS RESPONSIBLE FOR ALL WORK UNLESS OTHERWISE NOTED.
- ALL MEASUREMENTS ARE APPROXIMATE. VERIFY ALL DIMENSIONS IN FIELD PRIOR TO CONSTRUCTION.
- POSITIVELY ID ALL UTILITY CROSSINGS PRIOR TO CONSTRUCTION TO VERIFY DEPTHS AND LOCATIONS.
- 6. COORDINATE WITH ENBRIDGE R.O.W. FOR ACCESS TO SITE.
- DO NOT COMMENCE ANY WORK WITHOUT REQUIRED ENBRIDGE PERSONNEL ON SITE,
- WORK SHALL BE IN ACCORDANCE WITH TO ENBRIDGE SITE PREPARATION AND EARTHWORK SPECIFICATIONS FCS001,
- PROTECT SURVEY CONTROL POINTS, CONTRACTOR IS
   RESPONSIBLE FOR ESTABLISHING ADDITIONAL CONTROL FOR
   CONSTRUCTION AND RECORD SURVEY ACTIVITIES.
- DRILLED PATH SHOWN REFERS TO CENTERLINE OF PILOT HOLE, AS OPPOSED TO TOP OF INSTALLED PIPE.
- 11. PLACEMENT OF THE DRILL RIG IS NOT FIXED BY THE LOCATION OF THE ENTRY AND EXIT POINTS SHOWN, DRILL RIG PLACEMENT AND DRILLING METHODS ARE AT THE CONTRACTORS OPTION.

0.H	SAKONNET RIVER HDD		XXX
	.400264.073.10.01 PROJ XX	xxxx	1
WP XX	xx		
REV	REVISION DESCRIPTION	DATE	CHK
0.E	ISSUED FOR PERMITTING	2023-06-12 BARR/PS1	BARR/AFL O. CANNON
0.F	ISSUED FOR 90% REVIEW	2023-06-16 BARR/PS1	BARR/AFL O. CANNON
0.G	RE-ISSUED FOR 90% REVIEW	2023-08-31 BARR/PS1	BARR/AFL O. CANNON
0.H	RE-ISSUED FOR 90% REVIEW	2023-09-29 BARR/PS1	BARR/AFL O. CANNON

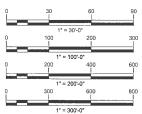

		0.F	2023-06-16	OTC AFL	ISSUED FOR 90% REVIEW		DRAWN BY:	AAB	07-22-2022	-	CIVIL				-
		0.E	2023-06-12	PS1 AFL	ISSUED FOR PERMITTING	\$2.9995.QQ29993	-				PLAN AND PRO	DFILE		$\sim$	
		0.D	2023-04-27	OTC AFL	RE-ISSUED FOR 60% REVIEW	RADD	DESIGN CHECKER:	AFL	04-27-2023					<b>EENBRIDG</b>	≥E.
		0.C	2023-01-20	BNM OTC	RE-ISSUED FOR 30% REVIEW	DVIII	DESIGN ENGINEER:	отс	04-27-2023	TITLE:				CLINDINIDU	/=
		0.B	2022-07-22	AAB OTC	ISSUED FOR 60% REVIEW	Corporate Headquarters: Minneapolis, Minnesota	PROJECT MANAGER:	111	04 27 2022	LOC - NEWDOI	RT COUNTY, RHODE IS	ZI AND		Algonquin Gas Transmission, LI	LC
		0.A	2022-04-15	PSI	ISSUED FOR 30% REVIEW	Minneapolis, Minnesota Ph: 1-800-632-2277	PROJECT WANAGEN.	JLL	04-27-2023	LOC NEVYPOI	KI COUNTY, KHODE IS	SLAIND		\$400 Westheiner Ct. Houston, TX 77056-5310 713 / 60	627-5400
DWG, NO.	REFERENCE DWG,	REV	DATE	DSN CK	DESCRIPTION		TITLE	INITIALS	DATE	YEAR: 2022	W.O.:	SCALE: AS SHOWN	DWG.:	XXXX-C.501-XXX6	REV.:



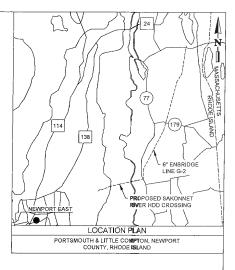

#### NOTES:

- 1. REFER TO ENBRIDGE EPP FOR SITE RESTORATION SEED MIX.
- THE ALIGNMENT OF ENBRIDGE PIPELINE G-2 IS APPROXIMATE, CONTRACTOR TO FIELD VERIFY ITS LOCATION PRIOR TO WORK.

#### LEGEND

TEMPORARY WORKSPACE WITHIN THE R.O.W.

TEMPORARY WORKSPACE OUTSIDE OF THE R.O.W.

PROPOSED CONSTRUCTION ACCESS ROUTE

-----\_ - - - - - - -

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ENBRIDGE LINE G-2 PROPOSED HDD ALIGNMENT CATHODIC PROTECTION LINE

PROPOSED SECURITY FENCE

EROSION AND SEDIMENT CONTROL EXISTING CONTOUR (SHOWN IN WHITE) PROPOSED CONTOUR (SHOWN IN BLACK)

REV: PROJECT TITLE:


0.H SAKONNET RIVER HDD XXX AFE: MC.400264.073,10.01 PROJ XXXXXX WP NO: XXXX

REV REVISION DESCRIPTION 0.D RE-ISSUED FOR 60% DESIGN 0.E ISSUED FOR PERMITTING 0.F ISSUED FOR 90% REVIEW 0.G RE-ISSUED FOR 90% REVIEW


0.H RE-ISSUED FOR 90% REVIEW 2023-09-29




		0.G	2023-08-31			RE-ISSUED FOR 90% REVIEW		DRAWN BY:	AAB	07-22-2022			CIVIL				
		0.F	2023-06-16	OTC	AFL	ISSUED FOR 90% REVIEW	769/1/189/1/189	ļ	1		1	TE	MPORARY WORKS	SPACE LAYOUT			
		0.E	2023-06-12	OTC	AFL	ISSUED FOR PERMITTING		DESIGN CHECKER:	AFL	04-27-2023	_		CLOSE-UP, EA			<b>EENBRIDG</b>	3E.
		0.D	2023-04-27	OTC	AFL	RE-ISSUED FOR 60% REVIEW	DANN	DESIGN ENGINEER:	отс	04-27-2023	TITLE:		02002 01,27	TO T		CENDRIDU	72
		0.C	2023-01-20	BNM	OTC	RE-ISSUED FOR 30% REVIEW	Corporate Headquarters:	PROJECT MANAGER:	1	04 27 2022	100 : 1	IEMPORT	COUNTY, RHODE	ICI AND		Algonquin Gas Transmission, L.	LC
		0.B	2022-07-22	PS1	OTC	ISSUED FOR 60% REVIEW	Minneapolis, Minnesota Ph: 1-800-632-2277	PROJECT WANAGER.	JUL	04-21-2023	LOC.: N	NEVVPORT	COUNTY, RHODE	: ISLAND		5400 Westheimer Ct. Houston, III. 71056-5310-7137	627-5400
DWG. NO.	REFERENCE DWG.	REV	DATE	DSN	СК	DESCRIPTION	111. 1-000-002-2211	TITLE	INITIALS	DATE	YEAR:	2022	W.O.:	SCALE: AS SHOWN	DWG.:	XXXX-C.501-XXX5	REV.: 0.H

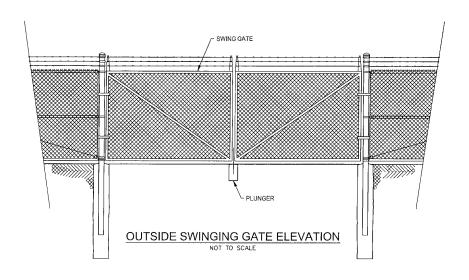



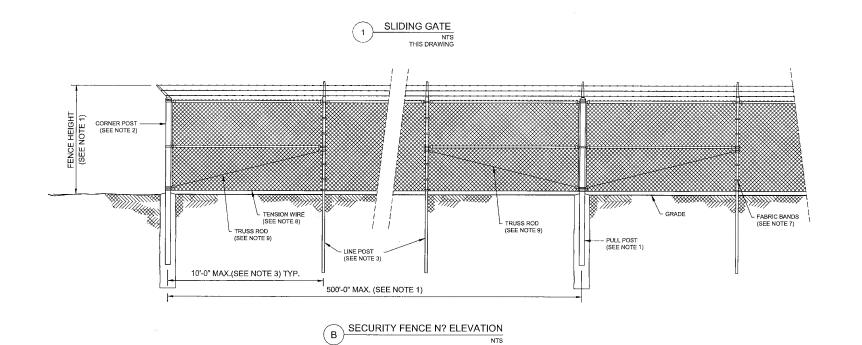

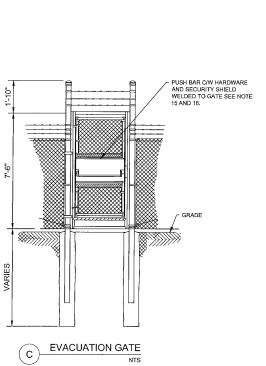

GATE SCHEDULE

GATE POST O.D.

3 1/2"

4 1/2"

NOTE:
GATE POSTS: 11'-0" LONG, DIAMETER AS NOTED

GATE OPENING =(A) GA

FOR SWING GATES: LESS THAN 7'-0"

FOR SLIDING (ROLLING) GATE: UP TO 25'-0"

# FENCING SPECIFICATION AND MATERIALS


FENCE SHALL BE CONSTRUCTED FROM ASTM F1043 GROUP 1A OR GROUP 1C ROUND STEEL PIPE FRAMING AND CHAIN LINK FABRIC WITH BARBED WIRE OVERHANG, SPECIFIED PIPE DIAMETERS ARE ACTUAL OUTSIDE DIAMETER, FENCE DESIGN AND CONSTRUCTION SHALL BE IN CONFORMANCE WITH ASTM F2811 - STANDARD GUIDE FOR DESIGN AND CONSTRUCTION OF CHAIN LINK SECURITY FENCING IN ADDITION TO THE FOLLOWING MINIMUM REQUIREMENTS.


		NSTRUCTION OF CHAIN LI IIMUM REQUIREMENTS:	NK SECURITY FENCING IN ADDITION TO THE FOLLOWING
	1.	HEIGHT:	7°-0" ABOVE FINISHED GRADE INCLUDING BARBED WIRE OVERHANG.
	2.	POSTS:	TERMINAL POSTS, CORNER POSTS AND PULL POSTS 3 1/2" O.D. X 11-0" LONG, PULL POSTS SHALL NOT EXCEED 500-0" SPACING, POST CONORETE FOOTINGS SHALL BE CAST INT 12" DIAMETER X 6-0" DEEP AUGERED HOLES.
	3.	LINE POST:	2 3/8" O.D. AT A SPACING OF 10'-0" MAX, DRIVE SET A MINIMUM OF 6'-0" DEEP.
	4.	TOP RAIL:	15/8" O.D. THE TOP RAIL SHALL BE JOINED WITH 6" OUTER SLEEVE TO FORM A CONTINUOUS BRACE FOR EACH STRETCH OF FENCE AND SECURED TO TERMINAL POSTS, CORNER POSTS, GATE POSTS, AND PULL POSTS.
	5.	BRACING:	1 5/8" O.D. HORIZONTAL MID BRACE LOCATED AT: TERMINAI POSTS, CORNER POSTS, GATE POSTS, PULL POSTS, AND TERMINATING AT THE FIRST LINE POST. BRACE ASSEMBLY INCLUDES A 3/8" TRUSS ROD
	6.	FITTINGS:	ALL FITTINGS SHALL BE INSTALLED SO AS TO PREVENT TAMPERING FROM OUTSIDE THE FENCED AREA.
	7,	FABRIC:	WOVEN FROM 9 GAUGE MIN., CLASS 1, (1.2 OZ/FT²) GALVANIZED WIRE, AND WOVEN INTO 2"X2" MESH, TOP OF FABRIC BARBED, BOTTOM KNUCKLED.
	8.	TENSION WIRE:	7 GAUGE, 1.2 OZ/FT <sup>2</sup> GALVANIZED WIRE, STRETCH TIGHT AND SECURE TO BOTTOMS OF ALL POSTS, SECURE WITH HOG RINGS EVERY 12".
9	9.	FABRIC WIRE:	FABRIC SHALL BE FASTENED TO TOP RAIL, AND TO BOTTON TENSION WIRE AT 1'-0" INTERVALS AND SECURED TO ALL POSTS VERTICALLY AT 1-10" INTERVALS,
1	10.	BARBED ARMS:	CAST ALUMINUM OR GALVANIZED ARM TO ACCOMMODATE THREE RUNS OF BARBED WIRE AT 45 DEGREE OVERHANG TO THE OUTSIDE, 1'-0" ABOVE FABRIC.
1	11.	BARBED WIRE:	TWO STRAND, 12.5 GAUGE GALVANIZED WIRE, WITH 14 GAUGE 4 POINT BARBS AT 5" O/C GALVANIZED.
1	12.	FOOTINGS:	MINIMUM CONCRETE 3000 PSI SULPHATE RESISTANT CEMENT WHERE SPECIFIED. DOME SHAPE TOPS OF FOOTINGS TO PROVIDE WATER DRAINAGE,
1	13.	ROLLING GATES:	ROLLING (SLIDE) GATE TYPE II, CLASS   PER ASTM F+184, FRAME WITH GALVANIZED PIPE, WELDED JOINTS, 2 36° O.D. GATES SHALL HAVE LATCHING DEVICES WITH A PROVISION FOR PADLOCKS & CHAIN. SLIDING GATES SHALL HAVE SEMILAUTOMATIC OUTER LATCHES.
1	4.	GATE POST:	SEE GATE SCHEDULE.
1	5.		SEE DRAWING D-1.8-5827-0TDD FOR DETAIL. PROVIDE MINIMUM 270° SWING.


REV:	PROJECT TITLE:			SEQ#:
0.G	SAKONNET RIVER HD	D		XXX
				i
AFE: MC	.400264.073.10.01	PROJ XXX	XXX	
WP XXX	«			
REV	REVISION DESCRIP	TION	DATE BY	CHK APPR
0.A	ISSUED FOR 30% REV	IEW	2022-04-15 BARR/PS1	BARR/OTC O. CANNON
0.B	ISSUED FOR 60% REV	IEW	2022-07-22 BARR/PS1	BARR/OTC O. CANNON
0.C	RE-ISSUED FOR 30% I	REVIEW	2023-01-20 BARR/PS1	BARR/OTC O, CANNON
0.D	RE-ISSUED FOR 60% F	REVIEW	2022-04-27 BARR/OTC	BARR/AFL O. CANNON
0.E	ISSUED FOR PERMITT	ING	2023-06-12 BARR/PS1	BARR/AFL O. CANNON
0.F	ISSUED FOR 90% REV	IEW	2023-06-16 BARR/PS1	BARR/OTC O. CANNON
0.G	RE-ISSUED FOR 90% F	REVIEW	2023-08-31 BARR/PS1	BARR/AFL O. CANNON


16. DRAWING SUBMITTAL CONTRACTOR MAY UTILIZE APPROVED GATE DESIGN.
CONTRACTOR TO SUBMIT DRAWINGS FOR ALTERNATE GATE
DESIGN APPROVAL.


		0.G	2023-08-31	PS1	AFL.	RE-ISSUED FOR 90% REVIEW		DRAWN BY:	PS1	07-22-2022			CIVIL					
		0.F	2023-06-16	PS1	OTC	ISSUED FOR 90% REVIEW		1			1		SECURITY FI	ENCE			$\sim$	
		0.E	2023-06-08	PS1	AFL	ISSUED FOR PERMITTING	RAPE	DESIGN CHECKER:	AFL				SECTIONS & D	ETAILS			<b>EENBRID</b>	CE.
		0.D	2023-04-27	OTC	AFL	RE-ISSUED FOR 60% REVIEW	וואכם	DESIGN ENGINEER:	отс		TITLE:						CENDRING	
		0.C	2023-01-20	BNM	отс	RE-ISSUED FOR 30% REVIEW	Corporate Headquarters:	PROJECT MANAGER:	JJI		LOC - NE	WDOD.	T COUNTY, RHODE I	OL AND		-+	Algonquin Gas Transmission	
		0.B	2022-07-22	PS1	отс	ISSUED FOR 60% REVIEW	Minneapolis, Minnesota Ph: 1-800-632-2277	PROJECT MANAGER.	JJL		LOC., NE	WPUR	I COUNTY, RHODE I	SLAND			5400 Westheimer Ct. Houston, TN 17866-5310-7.	713 / 623-5400
DWG, NO,	REFERENCE DWG.	REV	DATE	DSN	СК	DESCRIPTION	1.1	TITLE	INITIALS	DATE	YEAR:	2022	w.o.:	SCALE:	NTS	DWG.:	XXXX-C.501-XXX7	REV.: 0.G

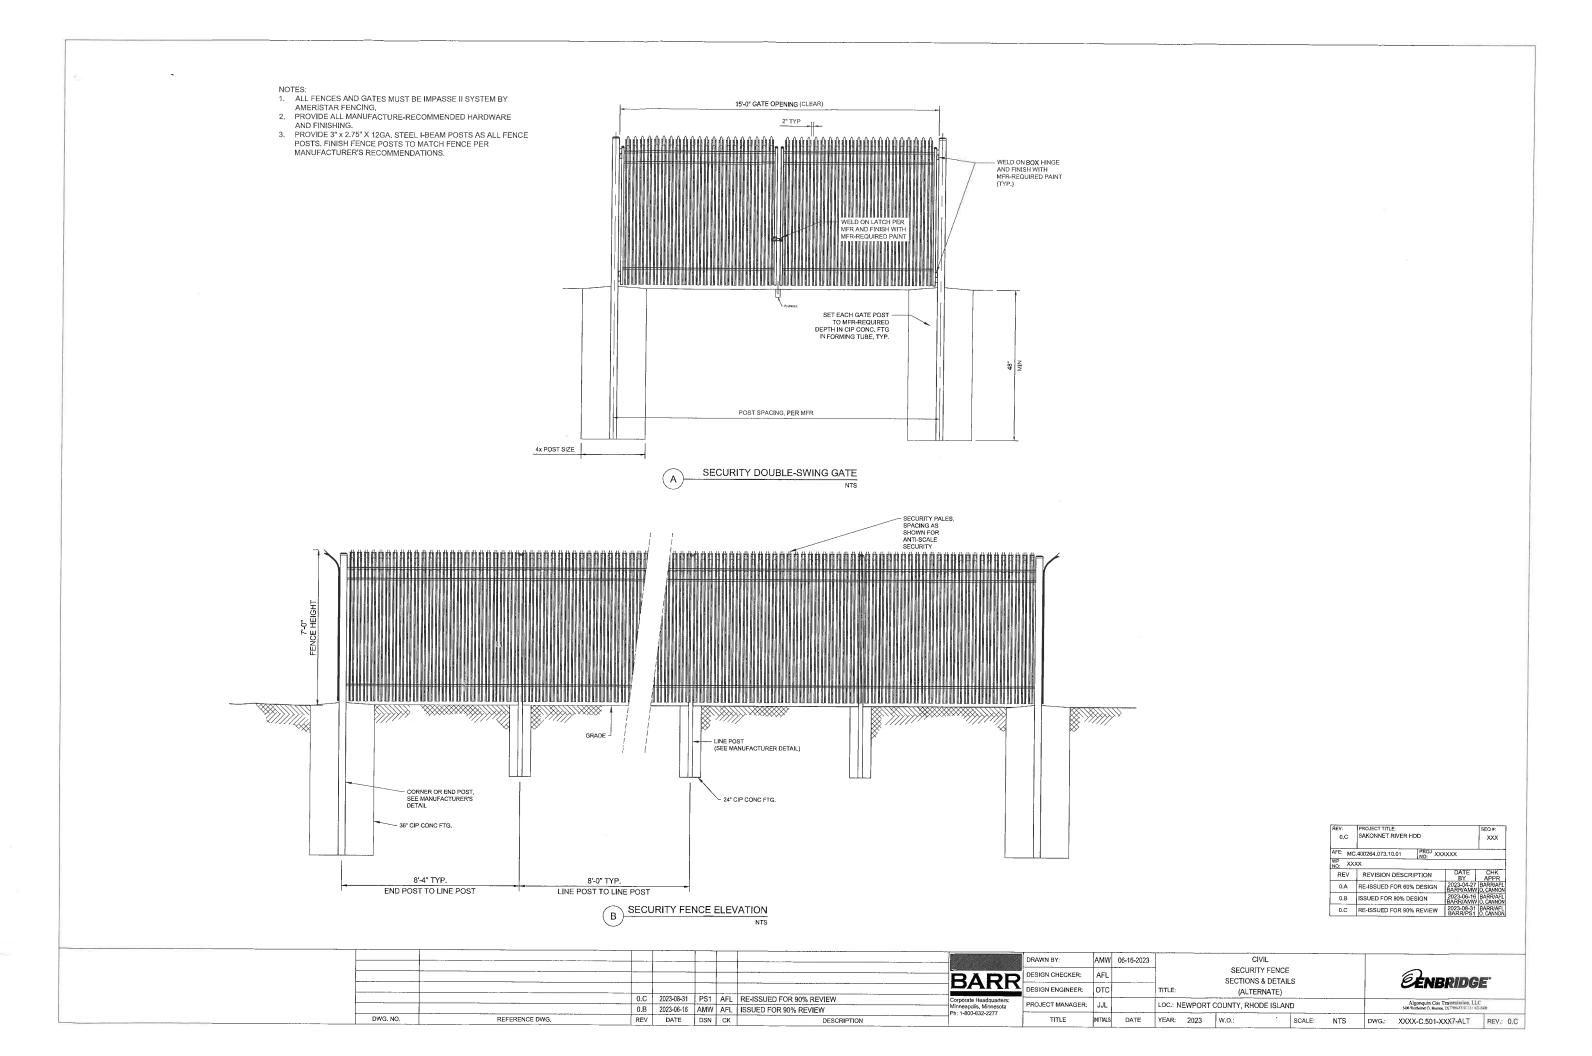

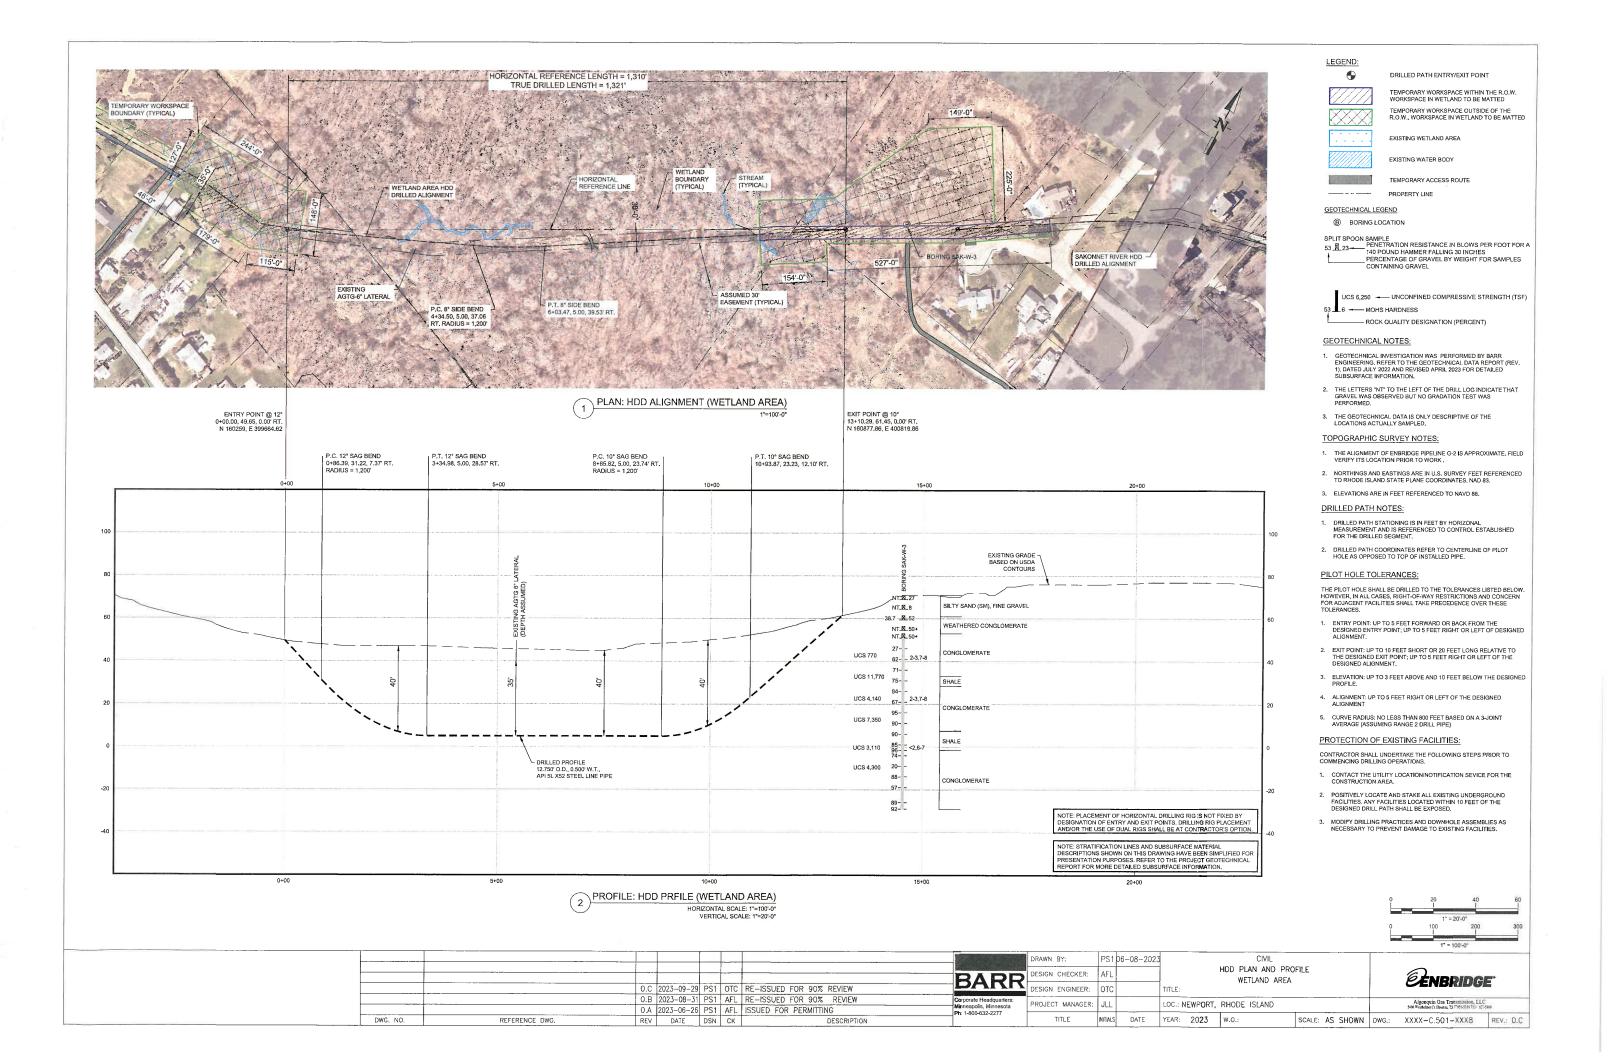

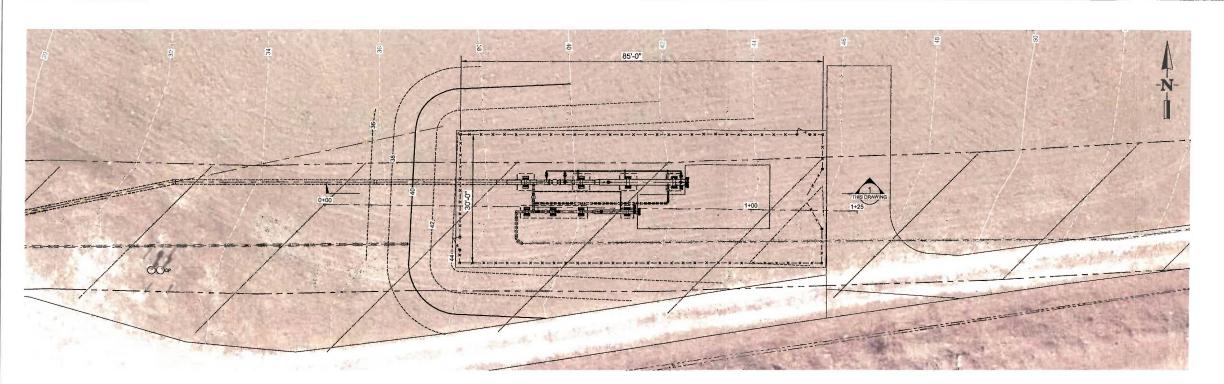

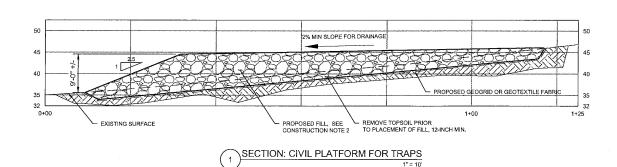

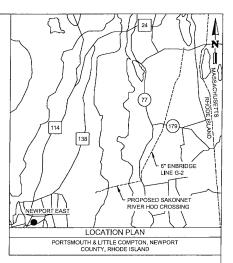

# CONSTRUCTION NOTES:

- CONSTRUCTION NOTES:

  1. NOTIFY THE RHODE ISLAND SAFE DIG SERVICE TO HAVE BURIED UTILITIES MARKED PRIOR TO EXCAVATION.

  2. UTILITY MARKERS TO BE CLEARLY VISIBLE PRIOR TO AND DURING THE DURATION OF WORK.

  3. PERFORM A "MAY SWEEP TO IDENTIFY UNDERGROUND UTILITIES.

  4. THE ALIGNMENT OF ENBRIDGE PIPELINE G-2 IS APPROXIMATE. CONTRACTOR TO FIELD VERIFY ITS LOCATION PRIOR TO WORK.

  5. CIVIL PLATFORM TO BE CONSTRUCTED USING "BANK RUN PROCESSED SAND AND GRAVEL" PER RHODE ISLAND DOT STANDARD SPECIFICATIONS FOR ROAD AND BRIDGE CONSTRUCTION, SECTION M-1, OR APPROVED ALTERNATE MATERIAL.

  6. PLACE FILL IN SINCH MAXIMUM LOOSE LIFTS AND COMPACT TO 95% STANDARD PROCTOR MAXIMUM DRY DENSITY OR GREATER. ADJUST THE MOISTURE CONTENT OF THE FILL MATERIAL, AS NEEDED, TO ACHIEVE TARGET COMPACTION.

  7. RESTORE DISTURBED AREAS BY GRADING, SPREADING TOPSOIL, SPREADING THE RECOMMENDED SEED MIX IN THE ENVIRONMENTAL PROTECTION PLAN, AND COVERING WITH MULCH OR STRAW.

## LEGEND

Adjust, marry and Addition		ENBRIDGE LINE G-2
====	=====	PROPOSED HDD ALIGNMENT
		CATHODIC PROTECTION LINE
	x	PROPOSED SECURITY FENCE
	12	EXISTING CONTOUR (SHOWN IN WHITE)
	52	PROPOSED CONTOUR (SHOWN IN BLACK)

REV:	PROJECT TITLE:			SEQ#:
0.B	SAKONNET RIVER I	HDD		xxx
AFE: MO	C.400264.073.10.01	PROJ XXX	OXXX	L
WP XX	XX			
REV	REVISION DESCR	RIPTION	DATE BY	CHK APPR
0.A	ISSUED FOR 90% R	EVIEW	2023-06-16 BARR/PS1	BARR/OTC 0. CANNON
0.B	RE-ISSUED FOR 90	% REVIEW	2023-08-31	BARR/AFL

													1" = 30'-0"		
			L			DRAWN BY:	PS1	06-12-2023		CIVIL					
					DADE	DESIGN CHECKER:	отс	06-15-2023	23 1				ENPRINCE.		
					DAKI	DESIGN ENGINEER:	отс	06-16-2023	TITLE:				CENDRIDGE		
<del></del>	0.B	2023-08-31			Corporate Headquarters: Minneapolis, Minnesota	PROJECT MANAGER:	JJL	06-16-2023	23 LOC.: NEWPORT COUNTY, RHODE ISLAND			Algonquin Gas Transmission, LLC			
REFERENCE DWG	0.A		DOM OK		Ph: 1-800-632-2277				_	·		DWG :	XXXX-C 501-XXX9	REV.: 0.	
	DEEEDEN/CE DWG	0.B 0.A DEFERENCE DWG DEV	0.B 2023-08-31 0.A 2022-04-15 REFERENCE DWG, REV DATE	0.A 2022-04-15 PS1 OTC	0.A 2022-04-15 PS1 OTC ISSUED FOR 90% REVIEW	0.A         2022-04-15         PS1         OTC         ISSUED FOR 90% REVIEW         Minneapolis, Minnesota Ph: 1-800-632-2277	BARR   DESIGN CHECKER:	DESIGN CHECKER: OTC	DESIGN CHECKER: OTC   06-15-2023	DESIGN CHECKER: OTC   06-16-2023   TITLE:	BARR   DESIGN CHECKER: OTC 06-15-2023   OFC 06-16-2023   OFC 06-16-2023	BARR   DESIGN CHECKER: OTC 06-15-2023   GRADING PLAN PLAN AND SECTION	BARR   DESIGN CHECKER: OTC   06-15-2023   GRADING PLAN	DRAWN BY: PS1 06-12-2023   CIVIL	