(401) 783-3370 Fax (401) 783-2069

#### **PUBLIC NOTICE**

File Number:	2024-03-070	Date:	June 11, 2024	

This office has under consideration the application of:

### Quonset Development Corporation 95 Cripes Street North Kingstown RI 02852

for a State of Rhode Island Assent to construct and maintain: The Quonset Development Corporation (QDC) is proposing the installation of the following structures to support Rhode Island's booming "Blue Economy Industry" (include but not limited to marine aquaculture, offshore wind and marine transportation):

- A 2,900 square foot (sf) pile supported vessel launch ramp and 4,100 sf fixed pile supported pier along the Terminal 5 shoreline;
- 9,000 square feet (sf) of floating support docks;
- 900 square foot (sf) crane pad;
- A total of 440 linear feet (LF) of wave attenuation structure to provide a safe vessel dockage.

Project Location:	2574 Davisville Road
City/Town:	North Kingstown
Plat/Lot:	Plat 193, lot 10
Waterway:	Narragansett Bay

Plans of the proposed work can be requested at <u>Cstaff1@crmc.ri.gov</u>.

In accordance with the Administrative Procedures Act (Chapter 42-35 of the Rhode Island General Laws) you may request a hearing on this matter.

You are advised that if you have good reason to enter protests against the proposed work it is your privilege to do so. It is expected that objectors will review the application and plans thoroughly, visit site of proposed work if necessary, to familiarize themselves with the conditions and cite what law or laws, if any, would in their opinion be violated by the work proposed.

If you desire to protest, you must attend the scheduled hearing and give sworn testimony. A notice of the time and place of such hearing will be furnished you as soon as possible after receipt of your request for hearing. If you desire to request a hearing, to receive consideration, it should be in writing (with your correct mailing address, e-mail address and valid contact number) and be received at this office on or before


July 11, 2024


Please email your comments/hearing requests to: <a href="mailto:cstaffl@crmc.ri.gov">cstaffl@crmc.ri.gov</a>; or mail via USPS to: Coastal Resources Management Council; O. S. Government Center, 4808 Tower Hill Road, Rm 116; Wakefield, RI 02879.

# BLUE ECONOMY SUPPORT DOCKS & BOAT RAMP

## NORTH KINGSTOWN, RHODE ISLAND CONTRACT NO: 2023-006

INDEX OF DRAWINGS				
INDEX	SHEET	SHEET TITLE		
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4	S-201	FLOATING DOCK PLAN		
5	S-202	SUPPORT DOCK AND BOAT RAMP PILE AND FRAMING PLAN		
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		CONSTRUCTION PLAN		

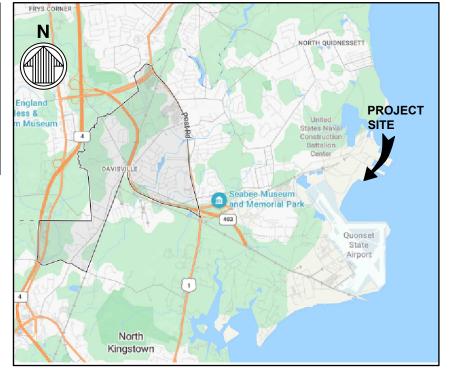

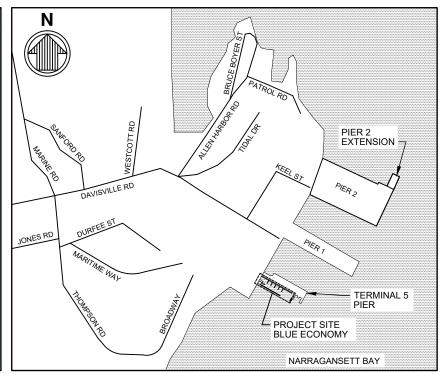

VICINITY MAP

LOCATION MAP

RECEIVED

3/12/2024

COASTAL RESOURCES
MANAGEMENT COUNCIL

PERMIT SUBMISSION NOT FOR CONSTRUCTION DECEMBER 05, 2023



Development Services 95 Cripe Street North Kingstown, RI 02852 Tel: (401) 295-0044 (401) 268-9885



NO. REVISION		DATE	
DESIGN BY FML	CHECKED BY FM	1L	
DRAWN BY FML	ENGINEER FML		
SCALE	PROJECT NO.		
CONTRACT NO. 2023-006			
FILE NAME: G-001.DWG			
APPROVED			
GREGORY J. COREN, P.E. QDC MANAGER OF ENGINEERING			
DATE:			

BLUE ECONOMY SUPPORT DOCKS & BOAT RAMP

TITLE SHEET

Gateway District Quonset Business Park<sub>®</sub>

SHEET NO.


DRAWING NO.

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G-001

#### **GENERAL NOTES**

- NOTES BELOW ARE NOT INTENDED TO REPLACE SPECIFICATIONS.
- 2. THE CONTRACTOR SHALL VERIFY ALL DIMENSIONS AND EXISTING CONDITIONS BEFORE STARTING WORK. NOTIFY OWNER/ENGINEER OF ANY DISCREPANCIES.
- 3. ALL WORK SHALL CONFORM TO THE REQUIREMENTS OF THESE PLANS AND SPECIFICATIONS.
- ALL FEDERAL, STATE, AND LOCAL SAFETY REGULATIONS ARE TO BE STRICTLY FOLLOWED. METHODS OF CONSTRUCTION AND INSTALLATION OF MATERIAL IS THE CONTRACTORS RESPONSIBILITY.
- ELEVATIONS SHOWN ARE BASED ON QVD (QUONSET VERTICAL DATUM), UNLESS OTHERWISE
- THE CONTRACTOR SHALL ABIDE BY ALL APPLICABLE FEDERAL, STATE, AND LOCAL ENVIRONMENTAL PROTECTION STANDARDS, LAWS AND REGULATIONS
- THE CONTRACTOR SHALL BE RESPONSIBLE FOR THE MAINTENANCE OF THE CONSTRUCTION SITE AND THE AREAS OF WORK WHILE PERFORMING THE WORK OF THIS CONTRACT. CONSTRUCTION DEBRIS SHALL BE REMOVED FROM THE CONSTRUCTION SITE ON A DAILY BASIS. NO BURNING OF DEBRIS SHALL BE PERMITTED.
- TERMINAL 5 PIER IS ADJACENT TO AN OPERATIONAL AUTO TERMINAL AND WILL BE STORING NEW AUTOS NEAR THE PROJECT SITE. KEEP DUST DOWN AT ALL TIMES, INCLUDING DURING NONWORKING PERIODS. USE VACUUMING, WET MOPPING, WET SANDING, OR WET POWER BROOMING. AIR BLOWING WILL BE PERMITTED ONLY FOR CLEANING NONPARTICULATE DEBRIS SUCH AS STEEL REINFORCING BARS. ONLY WET CUTTING WILL BE PERMITTED FOR CUTTING CONCRETE BLOCKS, CONCRETE, AND BITUMINOUS CONCRETE. DO NOT UNNECESSARILY SHAKE BAGS OF CEMENT, CONCRETE MORTAR, OR PLASTER. USE WIND SCREENS OR OTHER MEANS TO DECREASE THE CHANCE OF DUST AND/OR DEBRIS FROM SETTLING ON AUTOS. CONTRACTOR IS RESPONSIBLE FOR ANY ACCUMULATION ON AUTOS COMING FROM CONSTRUCTION SITE.
- VERTICAL DATUM NOTES

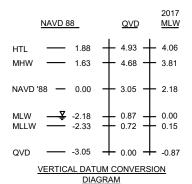

THE TIDAL DATA SHOWN WAS TAKEN FROM THE U.S. DEPARTMENT OF COMMERCE, NATIONAL OCEANIC AND ATMOSPHERIC ADMINISTRATION (NOAA) VERTICAL ONLINE DATUM TRANSFORMATION PROGRAM DETERMINED AT THE FOLLOWING LOCATION:

LOCATION: QUONSET, RHODE ISLAND **LATITUDE: 41.614 N** LONGITUDE: 71.405 W

REFERENCE TO QVD WAS OBTAINED FROM A PLAN TITLED "SURVEY CONTROL PLAN FOR RHODE ISLAND ECONOMIC DEVELOPMENT CORPORATION" PREPARED BY FOSTER SURVEY COMPANY OF WARWICK, RI AND LAST REVISED JULY 23, 2008.

TIDAL DATA IS PER NOAA AVERAGES BASED ON 1983-2001 TIDAL EPOCH AND NOT GUARANTEED TO REPRESENT CONDITIONS WHICH MAY OCCUR DURING CONSTRUCTION ACTUAL TIDES WILL VARY FROM LEVELS INDICATED. THE CONTRACTOR IS RESPONSIBLE FOR MAKING HIS OWN ESTIMATES OF TIDES WHICH MAY OCCUR DURING CONSTRUCTION VARIATION OF TIDAL LEVELS FROM THOSE INDICATED OR CONTRACTOR'S ESTIMATION OF TIDAL LEVELS SHALL NOT BE CONSIDERED AS A CLAIM FOR ADDITIONAL COMPENSATION OR DELAY OF THE WORK

- 10. THE HORIZONTAL DATUM IS THE RHODE ISLAND STATE PLANE COORDINATE SYSTEM.
- 11. A SITE-SPECIFIC GEOTECHNICAL INVESTIGATION WAS COMPLETED BY GZA GEO ENVIRONMENTAL, INC. (GZA) OF PROVIDENCE, RI. THE RESULTS OF THIS INVESTIGATION ARE PROVIDED IN THE GEOTECHNICAL DATA REPORT, INFRASTRUCTURE IMPROVEMENTS PIER: AND TERMINAL 5 (GZA, JULY 20, 2021), WHICH IS PROVIDED AS PART OF THE DESIGN-BUILD SOLICITATION PREPARED FOR THIS PROJECT.
- 12. THE BATHYMETRIC DATA AND DREDGE FOOTPRINT SHOWN ON THIS PLAN REFLECTS DATA GATHERED BETWEEN JANUARY 14, 2021 AND DECEMBER 9, 2021
- 13. EXISTING SHEET PILING, TIE-RODS, AND LANDSIDE PILE LOCATIONS ARE BASED ON RECORD DRAWINGS,

#### TUBIDITY CURTAIN:

A FLOATING TURBIDITY BARRIER SHALL BE DEPLOYED AROUND AND/OR IMMEDIATELY ADJACENT TO THE WORK AREA DURING EACH CONSTRUCTION PHASE THAT IS EXPECTED TO PRODUCE DEBRIS AND/OR SEDIMENT IN 600 FOOT (MAX) LENGTHS. TURBIDITY CURTAINS ARE NOT EXPECTED TO BE REQUIRED DURING PILE DRIVING.

#### **FOUNDATION**

- 1. JETTING OF PILES SHALL NOT BE ALLOWED.
- 2. TEST PILES (PDA PILES) SHALL BE DRIVEN PRIOR TO PLACING ORDER FOR PRODUCTION PILES.
- COAT PILES AS FOLLOWS:

  - INTERZONE 954 BY INTERNATIONAL MARINE COATINGS STRIPE COAT OVER ALL WELD SEAMS, BOLTS, SHARP OBJECTS, AND ANY
    - IMPERFECTIONS (8 MILS)
    - PRIMER COAT BRONZE (8 MILS) FINISH COAT BLACK (12 MILS)
  - MINIMUM COATING LENGTH OF 10'-0" BELOW MUDLINE

#### CONCRETE AND REINFORCING STEEL

- ALL CONCRETE WORK SHALL BE PERFORMED IN ACCORDANCE WITH ACI 301, UNLESS OTHERWISE NOTED.
- ALL CONCRETE SHALL BE NORMAL WEIGHT AND SHALL INCLUDE CALCIUM NITRITE CORROSION INHIBITOR PER THE SPECIFICATION
- ALL DETAILING, FABRICATION, AND ERECTION OF REINFORCING STEEL SHALL CONFORM TO THE ACI MANUAL OF STANDARD PRACTICE FOR DETAILING REINFORCED CONCRETE STRUCTURES, ACI 315.
- 4. MATERIALS SHALL CONFORM TO THE FOLLOWING, UNLESS OTHERWISE

	A. CONCRETE STRENGTH	28 DAYS
a.	CAST-IN-PLACE CONCRETE (TOPPING SLAB & BENT CAP CLOSURES)	4000 PSI (MINIMUM)
b.	CAST-IN-PLACE CONCRETE (PILE PLUG, PILE BLOCK OUT)	5000 PSI (MINIMUM)
c.	GROUT	8000 PSI (MINIMUM)
d.	PRECAST CONCRETE	6000 PSI (MINIMUM)

- B. REINFORCING STEEL REINFORCING SHALL HAVE THE FOLLOWING CHARACTERISTICS ASTM A 615, GRADE 60,
- a. REINFORCING STEEL AND DOWELS FOR CONCRETE . . . . **EPOXY COATED ASTM A 1064 EPOXY COATED**
- C. BEARING PADS SHALL BE ASPHALT IMPREGNATED FELT ASTM D1751
- 5. EPOXY COATED REINFORCING STEEL SHALL COMPLY WITH ASTM A775.
- CHAMFER ALL EXPOSED EXTERNAL CORNERS OF CONCRETE WITH 3/4", 45° CHAMFERS UNLESS OTHERWISE NOTED.
- MINIMUM CONCRETE COVER FOR REINFORCING SHALL BE 3" UNLESS OTHERWISE NOTED
- ALL REINFORCING BAR SPLICES SHALL BE CLASS "B" IN ACCORDANCE WITH THE SPLICE SCHEDULE ON THIS SHEET AND IN ACCORDANCE WITH ACI 318, CHAPTER 12, UNLESS OTHERWISE NOTED. SPLICES SHALL BE STAGGERED AND LOCATED AWAY FROM POINTS OF
- ALL JOINTS BETWEEN CAST-IN-PLACE CONCRETE AND HARDENED CONCRETE SHALL BE CLEAN WITH A ROUGHENED SURFACE OF 1/4" AMPLITUDE AND COATED WITH AN APPROVED BONDING COMPOUND.
- 10. TOPPING SLAB CONCRETE MIX DESIGN SHALL INCLUDE A SHRINKAGE REDUCING ADMIXTURE PER THE SPECIFICATIONS.

#### STRUCTURAL AND MISCELLANEOUS STEEL

- ALL STEEL WORK SHALL BE PERFORMED IN ACCORDANCE WITH THE LATEST EDITION OF THE AISC SPECIFICATIONS FOR THE DESIGN, FABRICATION, AND ERECTION OF STRUCTURAL STEEL FOR BUILDINGS. ALL WELDING SHALL CONFORM TO AWS D1.1 & D1.6.
- STEEL MATERIALS SHALL CONFORM TO THE FOLLOWING. UNLESS OTHERWISE NOTED:
- A. STRUCTURAL CARBON STEEL:..... ASTM A 572, GALV, UON
- ALL STEEL SHAPES, PLATES, OTHER FABRICATIONS AND ALL HARDWARE SHALL BE GALVANIZED BY THE HOT-DIP PROCESS IN ACCORDANCE WITH THE REQUIREMENTS OF ASTM A 123 AND/OR A 153, AS APPLICABLE, AFTER FABRICATION, UNLESS OTHERWISE NOTED.

(COATED) (50KSI)

#### TIMBER CONSTRUCTION


- ALL TIMBER CONSTRUCTION SHALL CONFORM TO THE RECOMMENDATIONS OF THE AMERICAN INSTITUTE OF TIMBER CONSTRUCTION.
- BOLTS AND NUTS SHALL CONFORM TO ASTM A 307 GALV, UON
- WASHERS SHALL BE GALVANIZED OGEE AND SHALL CONFORM TO ASTM A54.
- TIMBER MATERIAL SHALL BE TREATED DENSE MARINE GRADE No.1 DOUGLAS FIR OR SOUTHERN YELLOW PINE
- PROVIDE PRESSURE TREATED DOUGLAS FIR OR SOUTHERN YELLOW PINE CLEAN-UP PEELED PILES CONFORMING TO ASTM D25. PILES MUST BE IN ONE PIECE. SPLICING IS NOT

#### **ENVIRONMENTAL PROTECTION NOTES**

THE CONTRACTOR SHALL BE RESPONSIBLE FOR TAKING PREVENTATIVE MEASURES TO AVOID ANY ENVIRONMENTAL IMPACTS. THESE MEASURES SHALL INCLUDE BUT ARE NOT LIMITED TO:


- NO FUEL SHALL BE STORED ON SITE. ALL FUEL SHALL BE BROUGHT TO THE SITE AS REQUIRED
- ALL HOSES AND FUEL TRANSFER OPERATIONS SHALL BE CONDUCTED IN AN EFFICIENT AND SAFE MANNER IN ACCORDANCE WITH THE CONTRACTOR'S OPERATION MANUAL, AND AT A MINIMUM OF 100 FEET AWAY FROM ANY WATER BODIES.
- OIL ABSORBENT PADS SHALL BE PLACED UNDER ALL MACHINERY DURING FUELING
- ALL HYDRAULIC EQUIPMENT SHALL HAVE VEGETABLE OIL BASED, NON-TOXIC, NON-POLLUTING, HYDRAULIC FLUID.
- EQUIPMENT SHALL BE PROPERLY MAINTAINED AND RECORDED IN WEEKLY LOGS AS TO REQUIREMENTS FOR AND ACTUAL MAINTENANCE COMPLETED.
- A SPILL KIT OR ABSORBENT MATERIALS AND A MINIMUM OF 500 FEFT OF LISCG APPROVED OIL CONTAINMENT BOOM SHALL BE ON-SITE AT ALL TIMES URING CONSTRUCTION
- THE CONTRACTOR SHALL IMPLEMENT AND ADHERE TO ANY PROVISIONS REQUIRED BY ANY PERMITS ISSUED FOR THE WORK.

#### **TURBIDITY CURTAIN**

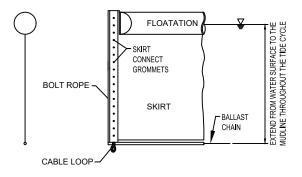


- FIGURE IS FOR REFERENCE ONLY. TURBIDITY CURTAIN SHALL BE SUBMITTED FOR APPROVAL
- 2. ANCHOR CURTAIN ENDS AT BULKHEAD FACE
- 3. ANCHOR CURTAIN AT INTERMEDIATE POINTS WITH CONCRETE ANCHOR BOLTS OR SUITABLE ANCHORAGE ACCEPTED BY OWNER.



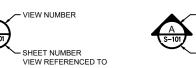

**DETAIL CALLOUT** 

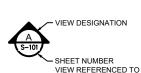

SECTION CUT

**ELEVATION VIEW** 

PERMIT SUBMISSION

**NOT FOR CONSTRUCTION** 

**DECEMBER 05. 2023** 

VIEW DESIGNATION

- SHEET NUMBER



**Development Services** 95 Cripe Street North Kingstown, RI 02852 Tel: (401) 295-0044 (401) 268-9885






HECKED BY EMI RAWN BY FML SINEER FML ONTRACT NO. 2023-00 ILE NAME: G-002.DWG APPROVED GREGORY J. COREN, P.E. QDC MANAGER OF ENGINEERING

> **BLUE ECONOMY SUPPORT DOCKS & BOAT RAMP**

GENERAL NOTES

**Gateway District** Quonset Business Park

G-002

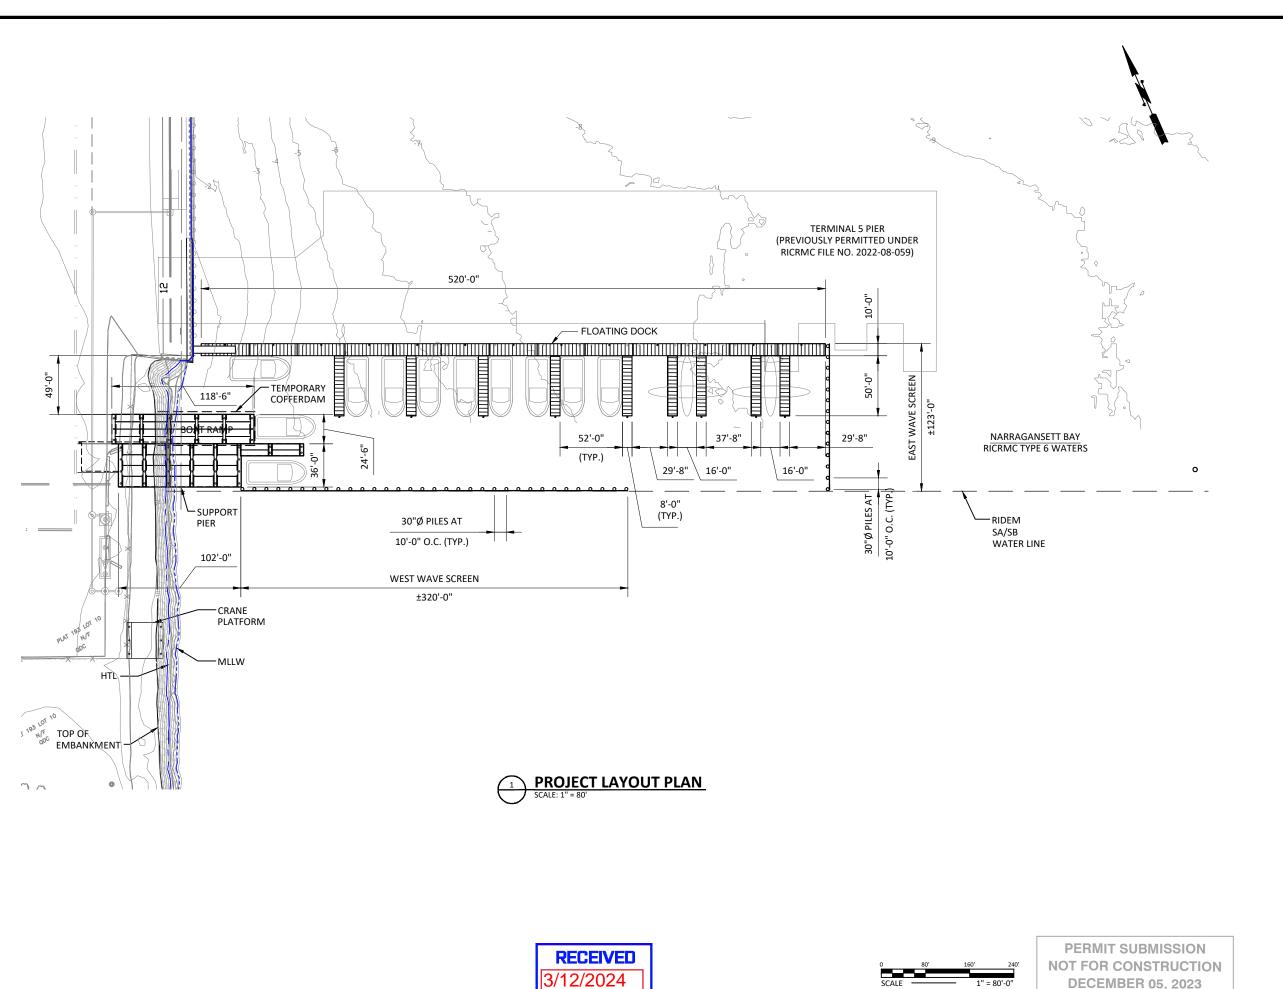



Development Services 95 Cripe Street North Kingstown, RI 02852 Tel: (401) 295-0044 (401) 268-9885



NO. REVISION DATE

DESIGN BY FML CHECKED BFML

DRAWN BY FML ENGINEER FML

SCALE PROJECT NO.

CONTRACT NO. 2023-006

FILE NAMES-101.DWG

BLUE ECONOMY SUPPORT DOCKS & BOAT RAMP

GREGORY J. COREN, P.E. QDC MANAGER OF ENGINEERING

PROJECT LAYOUT PLAN


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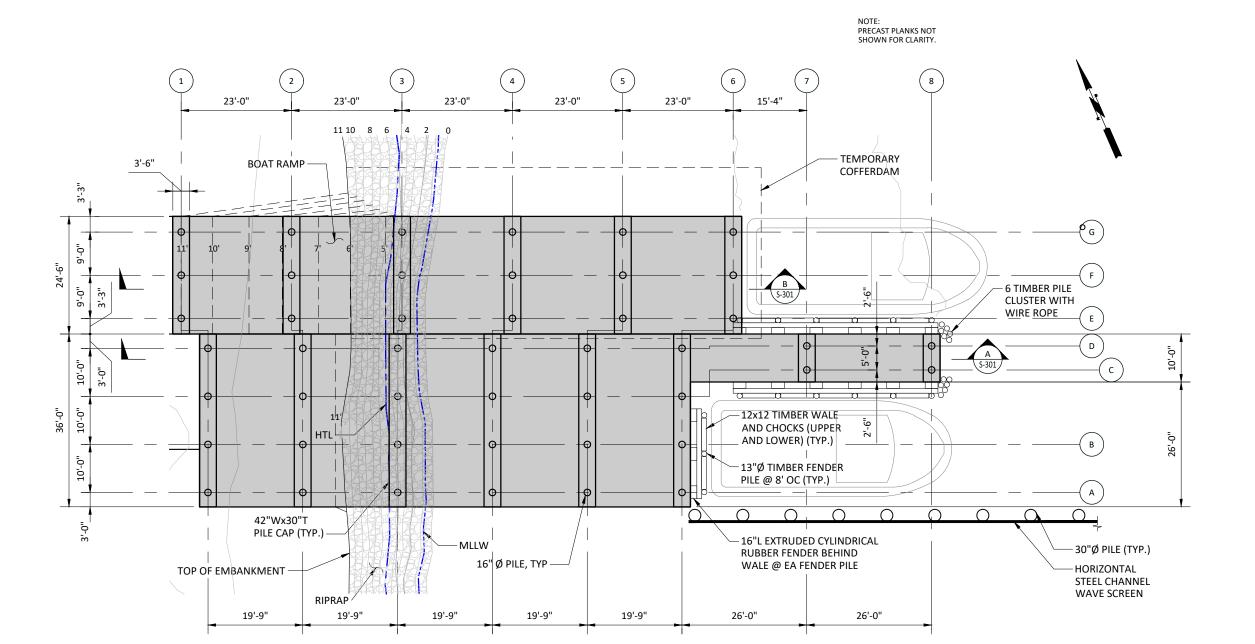
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APPROVED

DRAWING NO.

**3** 



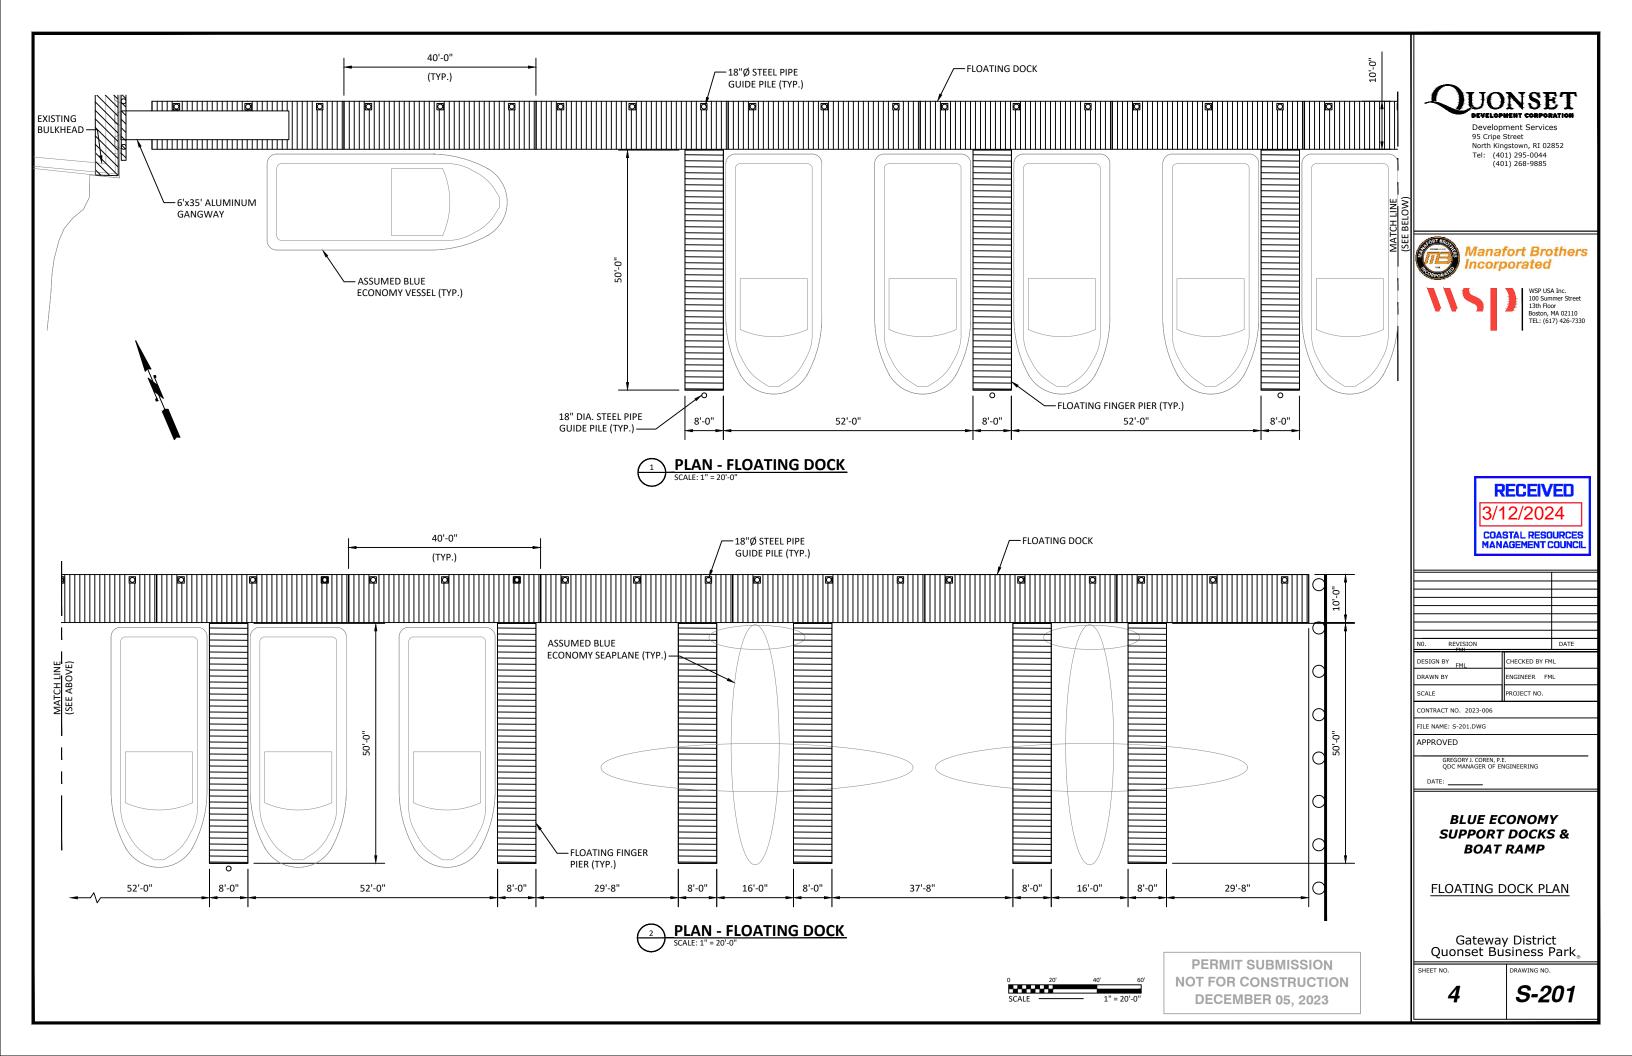

PLAN - BLUE ECONOMY SUPPORT DOCK & BOAT RAMP

SCALE: 1" = 20'-0"

#### NOTE

- CRANE SUPPORT PLATFORM PILE AND FRAMING PLAN SIMILAR.
   WAVE SCREEN STEEL PANELS ARE ANTICIPATED TO SPAN FROM -2.0 MLW TO +8.0
- WAVE SCREEN STEEL PANELS ARE ANTICIPATED TO SPAN FROM -2.0 MLW TO +8.0 MLW TO REST ABOVE THE MUDLINE. AT NO TIME WILL THE PANELS BE ALLOWED TO REST ON THE MUDLINE, NO SEABED IMPACTS ARE ANTICIPATED.





PERMIT SUBMISSION NOT FOR CONSTRUCTION DECEMBER 05, 2023

## QUONSET DEVELOPMENT CORPORATION

Development Services 95 Cripe Street North Kingstown, RI 02852 Tel: (401) 295-0044 (401) 268-9885



NO. REVISION		DATE	
DESIGN BY FML	CHECKED BY FML		
DRAWN BY FML	ENGINEER FML		
SCALE	PROJECT NO.		
CONTRACT NO. 2023-006			
FILE NAME: S-202.DWG			
APPROVED			
GREGORY J. COREN, P.E. QDC MANAGER OF ENGINEERING			

#### BLUE ECONOMY SUPPORT DOCKS & BOAT RAMP


SUPPORT DOCK AND BOAT
RAMP PILE AND FRAMING
PLAN

Gateway District Quonset Business Park<sub>®</sub>


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SECTION - BLUE ECONOMY SUPPORT DOCK
SCALE: 1/16" = 1'-0"



B SECTION - BLUE ECONOMY BOAT RAMP
SCALE: 1/16" = 1'-0"
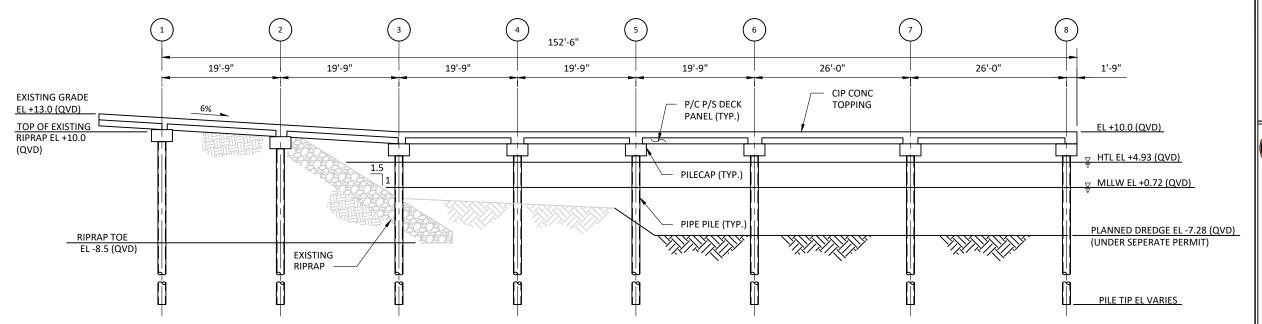
#### NOTE:

1. CRANE SUPPORT PLATFORM SECTION SIMILAR

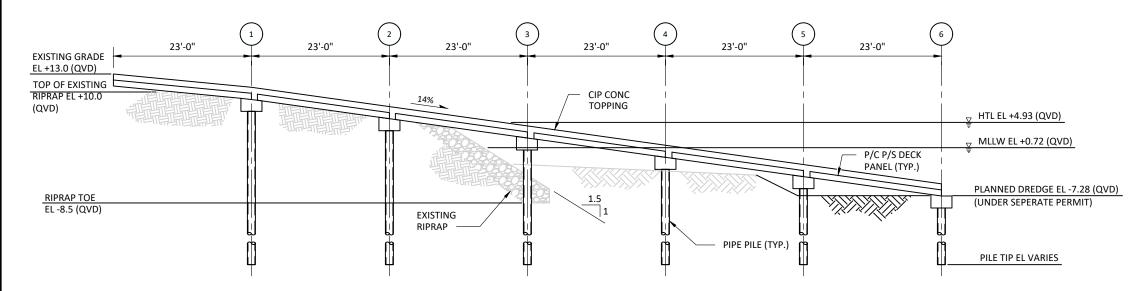



PERMIT SUBMISSION NOT FOR CONSTRUCTION DECEMBER 05, 2023

## QUONSET SEVELOPHENT CORPORATION

Development Services 95 Cripe Street North Kingstown, RI 02852 Tel: (401) 295-0044 (401) 268-9885



NO. REVISION DATE

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DRAWN BY FML ENGINEER FML

SCALE PROJECT NO.

CONTRACT NO. 2023-006

FILE NAME: S-301.DWG

APPROVED

GREGORY J. COREN, P.E.
QDC MANAGER OF ENGINEERING

DATE: \_\_\_\_\_\_

BLUE ECONOMY SUPPORT DOCKS & BOAT RAMP


SUPPORT DOCK AND BOAT RAMP SECTIONS

Gateway District Quonset Business Park<sub>®</sub>

SHEET NO.

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6

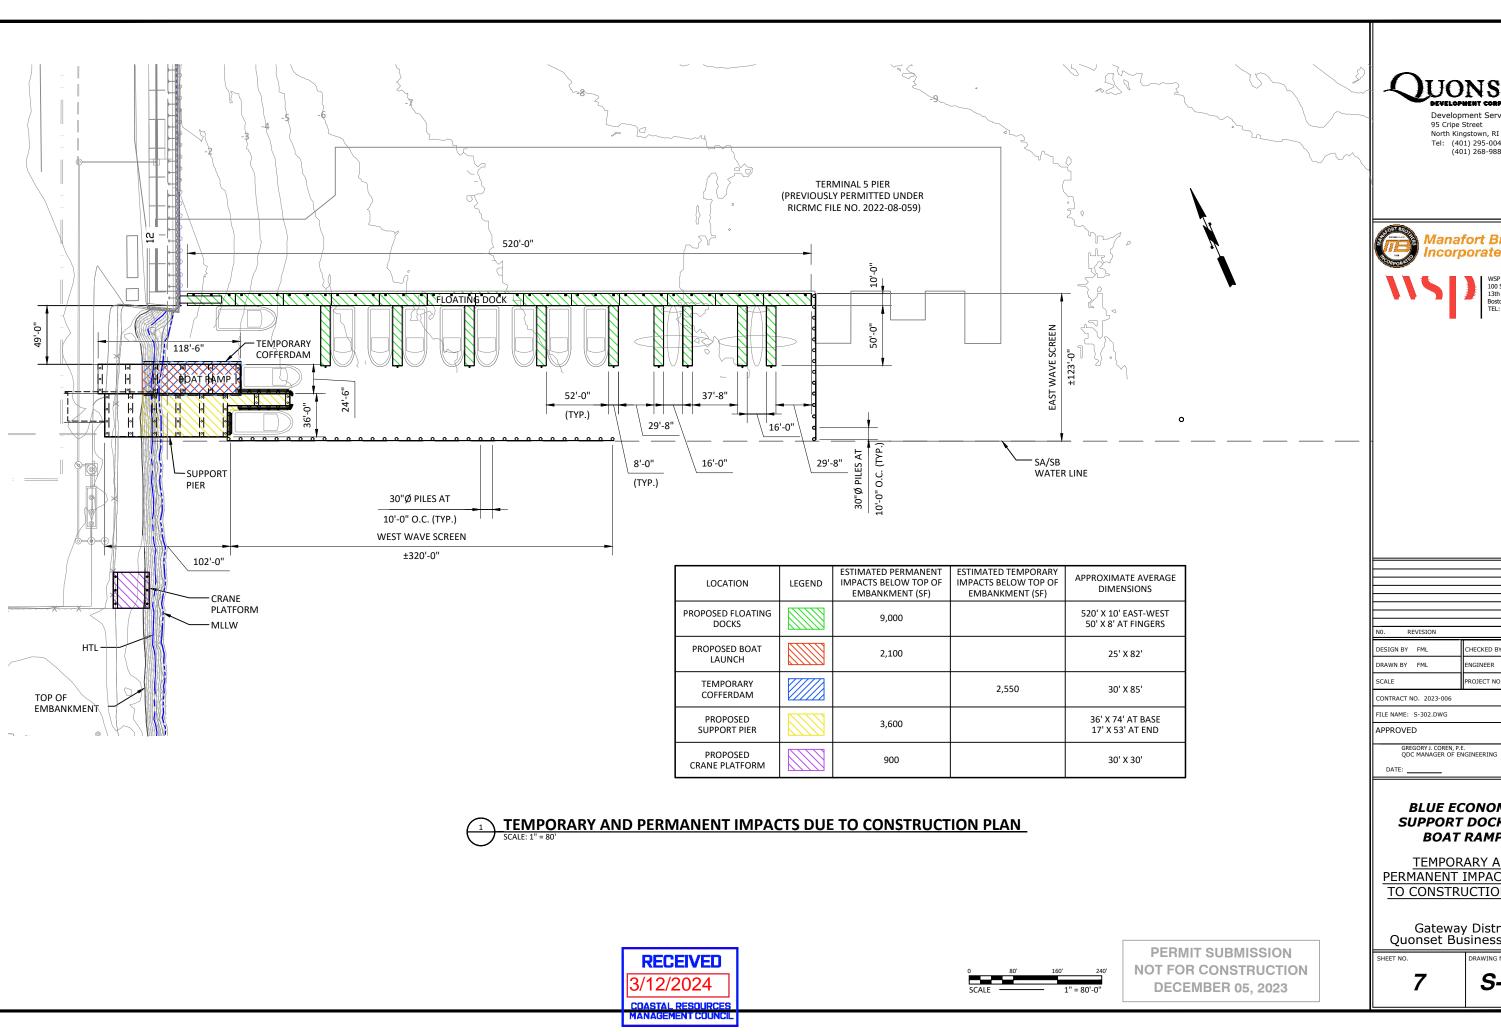

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#### **BLUE ECONOMY SUPPORT DOCKS & BOAT RAMP**

TEMPORARY AND PERMANENT IMPACTS DUE TO CONSTRUCTION PLAN

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