

State of Rhode Island Coastal Resources Management Council Oliver H. Stedman Government Center 4808 Tower Hill Road, Suite 3 Wakefield, RI 02879-1900

(401) 783-3370 Cstaff1@crmc.ri.gov

NOTICE OF PUBLIC HEARING

Reschedule Notification October 7, 2025

CRMC File No.:	2023-10-015	Date:	September 22, 2025
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In accordance with and pursuant to the provisions of the "Administrative Procedures Act", (Chapter 42-35 et. seq. of the General Laws of Rhode Island), and the Rules and Regulations of the Coastal Resources Management Council, a hearing will be held on the petition of:

City of East Providence c/o Erik Skadberg, PE 145 Taunton Avenue East Providence, RI 02914

relative to Title 46, Chapter 23, of Section 6 A, B, C, D, E, Title 46 Chapter 23 Section 18(b), Title 46, Chapter 6, Section 1, Title 46, Chapter 6, Section 2 of the Rhode Island General Laws of 1956, as amended, for a State of Rhode Island Assent to: The City of East Providence proposes to repair significant storm damage to the existing bank and construct a new revetment along an approximate 810 ft section of shoreline at Crescent Park. To protect the shoreline, park land, and persons using the park, the Applicant seeks to construct a shoreline protection system along the park's southern end which includes: re-grading the existing slope and relocating the toe approximately 30 ft landward from the location of the toe prior to recent storm damage, removal of existing slope vegetation as needed for safety during and after construction, and the construction of a stone revetment system along the shoreline with a vegetated slope incorporating an erosion control mat and coir logs above the revetment. The work includes reconstructing the existing wooden stairs at a new location to the north to maintain access to the beach at the park's southern end. A special exception is required for the grading and cutting of the existing coastal bluff/bank per CRMP Red Book § RICMRP, Specifically, Section 1.3.1.B.2.(a) Filling, Removing and Grading of Shoreline Features, Prohibitions "Filling, removing, or grading is prohibited on beaches, dunes, undeveloped barrier beaches, coastal wetlands, cliffs and banks, and rocky shores adjacent to Type 1 and 2 waters unless the primary purpose of the alteration is to preserve or enhance the feature as a conservation area or natural buffer against storms."

Additional work has been proposed to keep as much sand as possible 'in the system' since the last public notice (October 29,2024) as follows:

Crescent Park

- 1. Construct a 10 ft wide sand berm along the seaward side of the proposed revetment toe at a maximum slope of 3H:1V;
- 2. Plant American beachgrass on the sand berm spaced at 1 foot on center;
- 3. Install post and rope fencing at the toe of the sand berm to protect vegetation;
- 4. Place sand in the revetment stone matrix, as feasible;
- 5. Place sand in the revetment stone matrix along Crescent Park's northern shoreline (CRMC # 2022-02-036), as feasible;
- 6. Place sand at end of Beach Road (above high tide line) after completion of the new stormwater system construction; and,

CRMC File 2023-10-015 City of East Providence Public Hearing Notification for Special Exception Page Two

7. Regrade beach profile seaward of the sand berm up to the high tide line at a maximum slope of 10H:1V where feasible.

Sabin Point

- 1. Construct sand berm with a maximum slope of 3H:1V;
- 2. Plant American beachgrass on the sand berm spaced at 1 foot on center;
- 3. Remove and demolish/abandon existing buried drainage utilities as shown;
- 4. Install post and rope fencing around the perimeter of the sand berm to protect vegetation; and,
- 5. Install timber access mat over sand berm for pedestrian access.

The hearing will be held at <u>6:30 p.m.</u> on <u>Tuesday, October 21, 2025</u> in Conference Room A of the Administration Building, One Capitol Hill, Providence, RI.

Parties interested in/or concerned with the above-mentioned matter are invited to be present and/or represented by counsel at the above-mentioned time and place. This meeting place is accessible to individuals with disabilities. The meeting location is accessible to handicapped persons. Any individual requiring a reasonable accommodation in order to participate in this meeting should contact CRMC offices at 401-783-3370 at least 72 hours prior to the meeting.

Plans of the proposed work may be seen in the office of the Coastal Resources Management Council, Oliver H. Stedman Government Center, 4808 Tower Hill Road, Wakefield, Rhode Island, between the hours of 8:30 a.m. and 3:30 p.m., Monday through Friday.

Oral statements will be heard and recorded and statements may be submitted to the hearing officers at the time of hearing.

Signed this 22nd day of September, 2025.

Jeffrey M. Willis, Executive Director Coastal Resources Management Council

/lat -- Rescheduled October 07, 2025



Order Confirmation

Not an Invoice

Account Number:	709523
Customer Name:	East Providence, City Of
Customer Address:	East Providence, City Of 145 TAUNTON AVE.
	EAST PROVIDENCE RI 02914
Contact Name:	East Providence, City Of
Contact Phone:	4014357766
Contact Email:	
PO Number:	

Date:	09/24/2025
Order Number:	11695606
Prepayment Amount:	\$ 0.00

Column Count:	2.0000
Line Count:	96.0000
Height in Inches:	9.8700

Print

Product	#Insertions	Start - End	Category
NEO PVP The Providence Jrnl	1	09/29/2025 - 09/29/2025	Public Notices
NEO PVP providencejournal.com	1	09/29/2025 - 09/29/2025	Public Notices

As an incentive for customers, we provide a discount off the total order cost equal to the 3.99% service fee if you pay with Cash/Check/ACH. Pay by Cash/Check/ACH and save!

Total Cash Order Confirmation Amount Due	\$1382.40
Tax Amount	\$0.00
Service Fee 3.99%	\$55.16
Cash/Check/ACH Discount	-\$55.16
Payment Amount by Cash/Check/ACH	\$1382.40
Payment Amount by Credit Card	\$1437.56



Order	Confirmation Amount	\$1382.40

Ad Preview

NOTICE OF PUBLIC HEARING CRMC File No.: 2023-10-015

In accordance with and pursuant to the provisions of the "Administrative Procedures Act", (Chapter 42-35 et. seq. of the General Laws of Rhode Island), and the Rules and Regulations of the Coastal Resources Management Council, a hearing will be held on the petition of: City of East Providence

city of East Providence
c/o Erik Skadberg, PE
145 Taunton Avenue
East Providence, RI 02914
relative to Title 46, Chapter 23, of Section 6 A, B, C, D, E, Title 46 Chapter 39 Section 18(b), Title 46, Chapter 6, Section 1, Title 46, Chapter 6, Section 1 20 of the Rhode Island General Laws of 1956, as amended, for a State of Rhode Island Assent to: The City of East Providence proposes to repair significant storm damage to the existing bank and construct a new revetment along an approximate 810 ft section of shoreline at Crescent Park. To protect the shoreline, park land, and persons using the park, the Applicant seeks to construct a shoreline protection system along the park's southern end which includes: re-grading the existing slope and relocating the toe approximately 30 ft landward from the location of the toe prior to recent storm damage, removal of existing slope vegetation as needed for safety removal of existing slope vegetation as needed for safety during and after construction, and the construction of a stone revetment system along the shoreline with a vegetated slope incorporating an erosion control mat and coir logs above the revetment. The work includes reconstructlogs above the revetment. The work includes reconstructing the existing wooden stairs at a new location to the north to maintain access to the beach at the park's southern end. A special exception is required for the grading and cutting of the existing coastal bluff/bank per CRMP Red Book's RCMRP. Specifically, Section 1.3.1.B.2.(a) Filling, Removing and Grading of Shoreline Features, Prohibitions "Filling, removing, or grading is prohibited on beaches, dunes, undeveloped barrier beaches, coastal wetlands, cliffs and banks, and rocky shores adjacent to Type 1 and 2 cliris and banks, and rocky shores adjacent to type I and 2 waters unless the primary purpose of the alteration is to preserve or enhance the feature as a conservation area or natural buffer against storms."

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as possible 'in the system' since the last public notice (October 29,2024) as follows: Crescent Park

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- 2. Plant American beachgrass on the sand berm spaced at 1 foot on center;

 3. Install post and rope fencing at the toe of the sand berm
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- Sabin Point

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The hearing will be held at 6:00 p.m. *on Tuesday, October 14, 2025 in Conference Room A of the Administration Build-

ng, One Capitol Hill, Providence, RI.

Parties interested in/or concerned with the abovementioned matter are invited to be present and/or represented by counsel at the above-mentioned time and place. This meeting place is accessible to individuals with disabilities. The meeting location is accessible to handicapped persons. Any individual requiring a reasonable accommoda-tion in order to participate in this meeting should contact CRMC offices at 401-783-3370 at least 72 hours prior to the meeting.

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(401) 783-3370 Fax (401) 783-2069

PUBLIC NOTICE

File Number:	2023-10-015	Date:	October 29, 2024

This office has under consideration the application of:

City of East Providence c/o Erik Skadberg, PE 145 Taunton Avenue East Providence, RI 02914

for a State of Rhode Island Assent to construct and maintain: The City of East Providence proposes to repair significant storm damage to the existing bank and construct a new revetment along an approximate 810 ft section of shoreline at Crescent Park. To protect the shoreline, park land, and persons using the park, the Applicant seeks to construct a shoreline protection system along the park's southern end which includes: re-grading the existing slope and relocating the toe approximately 30 ft landward from the location of the toe prior to recent storm damage, removal of existing slope vegetation as needed for safety during and after construction, and the construction of a stone revetment system along the shoreline with a vegetated slope incorporating an erosion control mat and coir logs above the revetment. The work includes reconstructing the existing wooden stairs at a new location to the north to maintain access to the beach at the park's southern end. A special exception is required for the grading and cutting of the existing coastal bluff/bank per CRMP Red Book § RICMRP, Specifically, Section 1.3.1.B.2.(a) Filling, Removing and Grading of Shoreline Features, Prohibitions "Filling, removing, or grading is prohibited on beaches, dunes, undeveloped barrier beaches, coastal wetlands, cliffs and banks, and rocky shores adjacent to Type 1 and 2 waters unless the primary purpose of the alteration is to preserve or enhance the feature as a conservation area or natural buffer against storms."

Project Location:	701 Bullocks Point Avenue; Plat 414, lot 7, 8, 8.1
City/Town:	East Providence
Waterway:	Providence River

Plans of the proposed work can be requested at Cstaff1@crmc.ri.gov.

In accordance with the Administrative Procedures Act (Chapter 42-35 of the Rhode Island General Laws) you may request a hearing on this matter.

You are advised that if you have good reason to enter protests against the proposed work it is your privilege to do so. It is expected that objectors will review the application and plans thoroughly, visit site of proposed work if necessary, to familiarize themselves with the conditions and cite what law or laws, if any, would in their opinion be violated by the work proposed.

If you desire to protest, you must attend the scheduled hearing and give sworn testimony. A notice of the time and place of such hearing will be furnished you as soon as possible after receipt of your request for hearing. If you desire to request a hearing, to receive consideration, it should be in writing (with your correct mailing address, e-mail address and valid contact number) and be received at this office on or before:

November 29, 2024.

Please email your comments/hearing requests to: cstaffl@crmc.ri.gov; or mail via USPS to: Coastal Resources Management Council; O. S. Government Center, 4808 Tower Hill Road, Rm 116; Wakefield, RI 02879.


SLOPE REPAIRS & SHORELINE PROTECTION SOUTHERN SHORELINE

ROSE LARISA MEMORIAL PARK

701 BULLOCKS POINT AVENUE EAST PROVIDENCE, RHODE ISLAND

INDEX


DESCRIPTION
TITLE SHEET
GENERAL NOTES - 1 OF 2
GENERAL NOTES - 2 OF 2
EXISTING CONDITIONS PLAN - PRE-STORM - OVERALL
EXISTING CONDITIONS PLAN - PRE-STORM - 1 OF 2
EXISTING CONDITIONS PLAN - PRE-STORM - 2 OF 2
SLOPE EROSION LOCATIONS - POST-STORM
DEMOLITION PLAN
PROPOSED CONDITIONS PLAN - OVERALL
PROPOSED CONDITIONS PLAN - 1 OF 2
PROPOSED CONDITIONS PLAN - 2 OF 2
TYPICAL SLOPE REPAIR SECTION
SLOPE REPAIR CROSS SECTION - 1 OF 4
SLOPE REPAIR CROSS SECTION - 2 OF 4
SLOPE REPAIR CROSS SECTION - 3 OF 4
SLOPE REPAIR CROSS SECTION - 4 OF 4
TYPICAL DETAILS - 1 OF 2
TYPICAL DETAILS - 2 OF 2

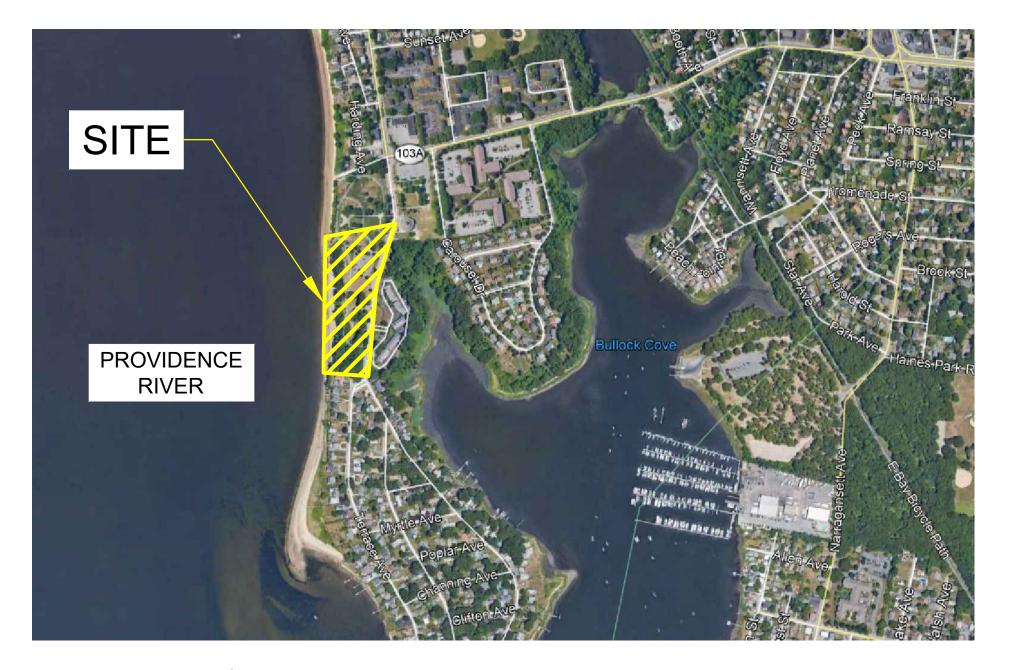



PREPARED FOR CITY OF EAST PROVIDENCE 145 TAUNTON AVENUE EAST PROVIDENCE, RI 02914




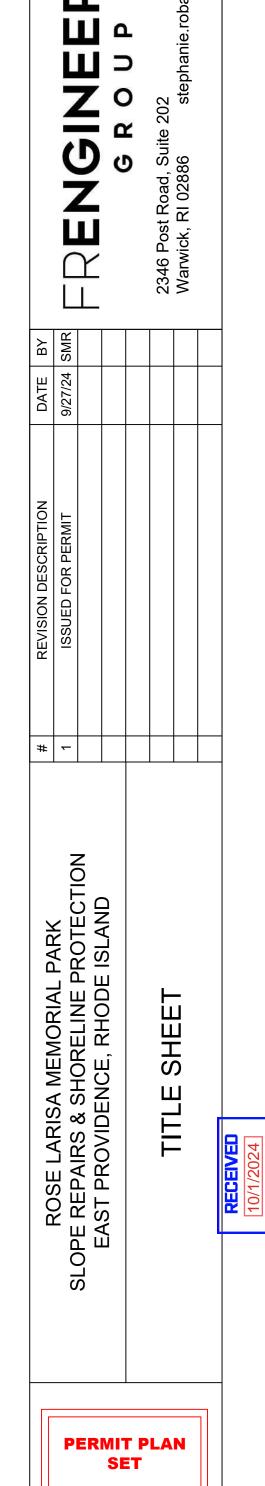






DATE: SEPTEMBER 27, 2024 DESIGN BY: SMR DRAWN BY: SJR / CDE PROJECT NUMBER: 22006.00




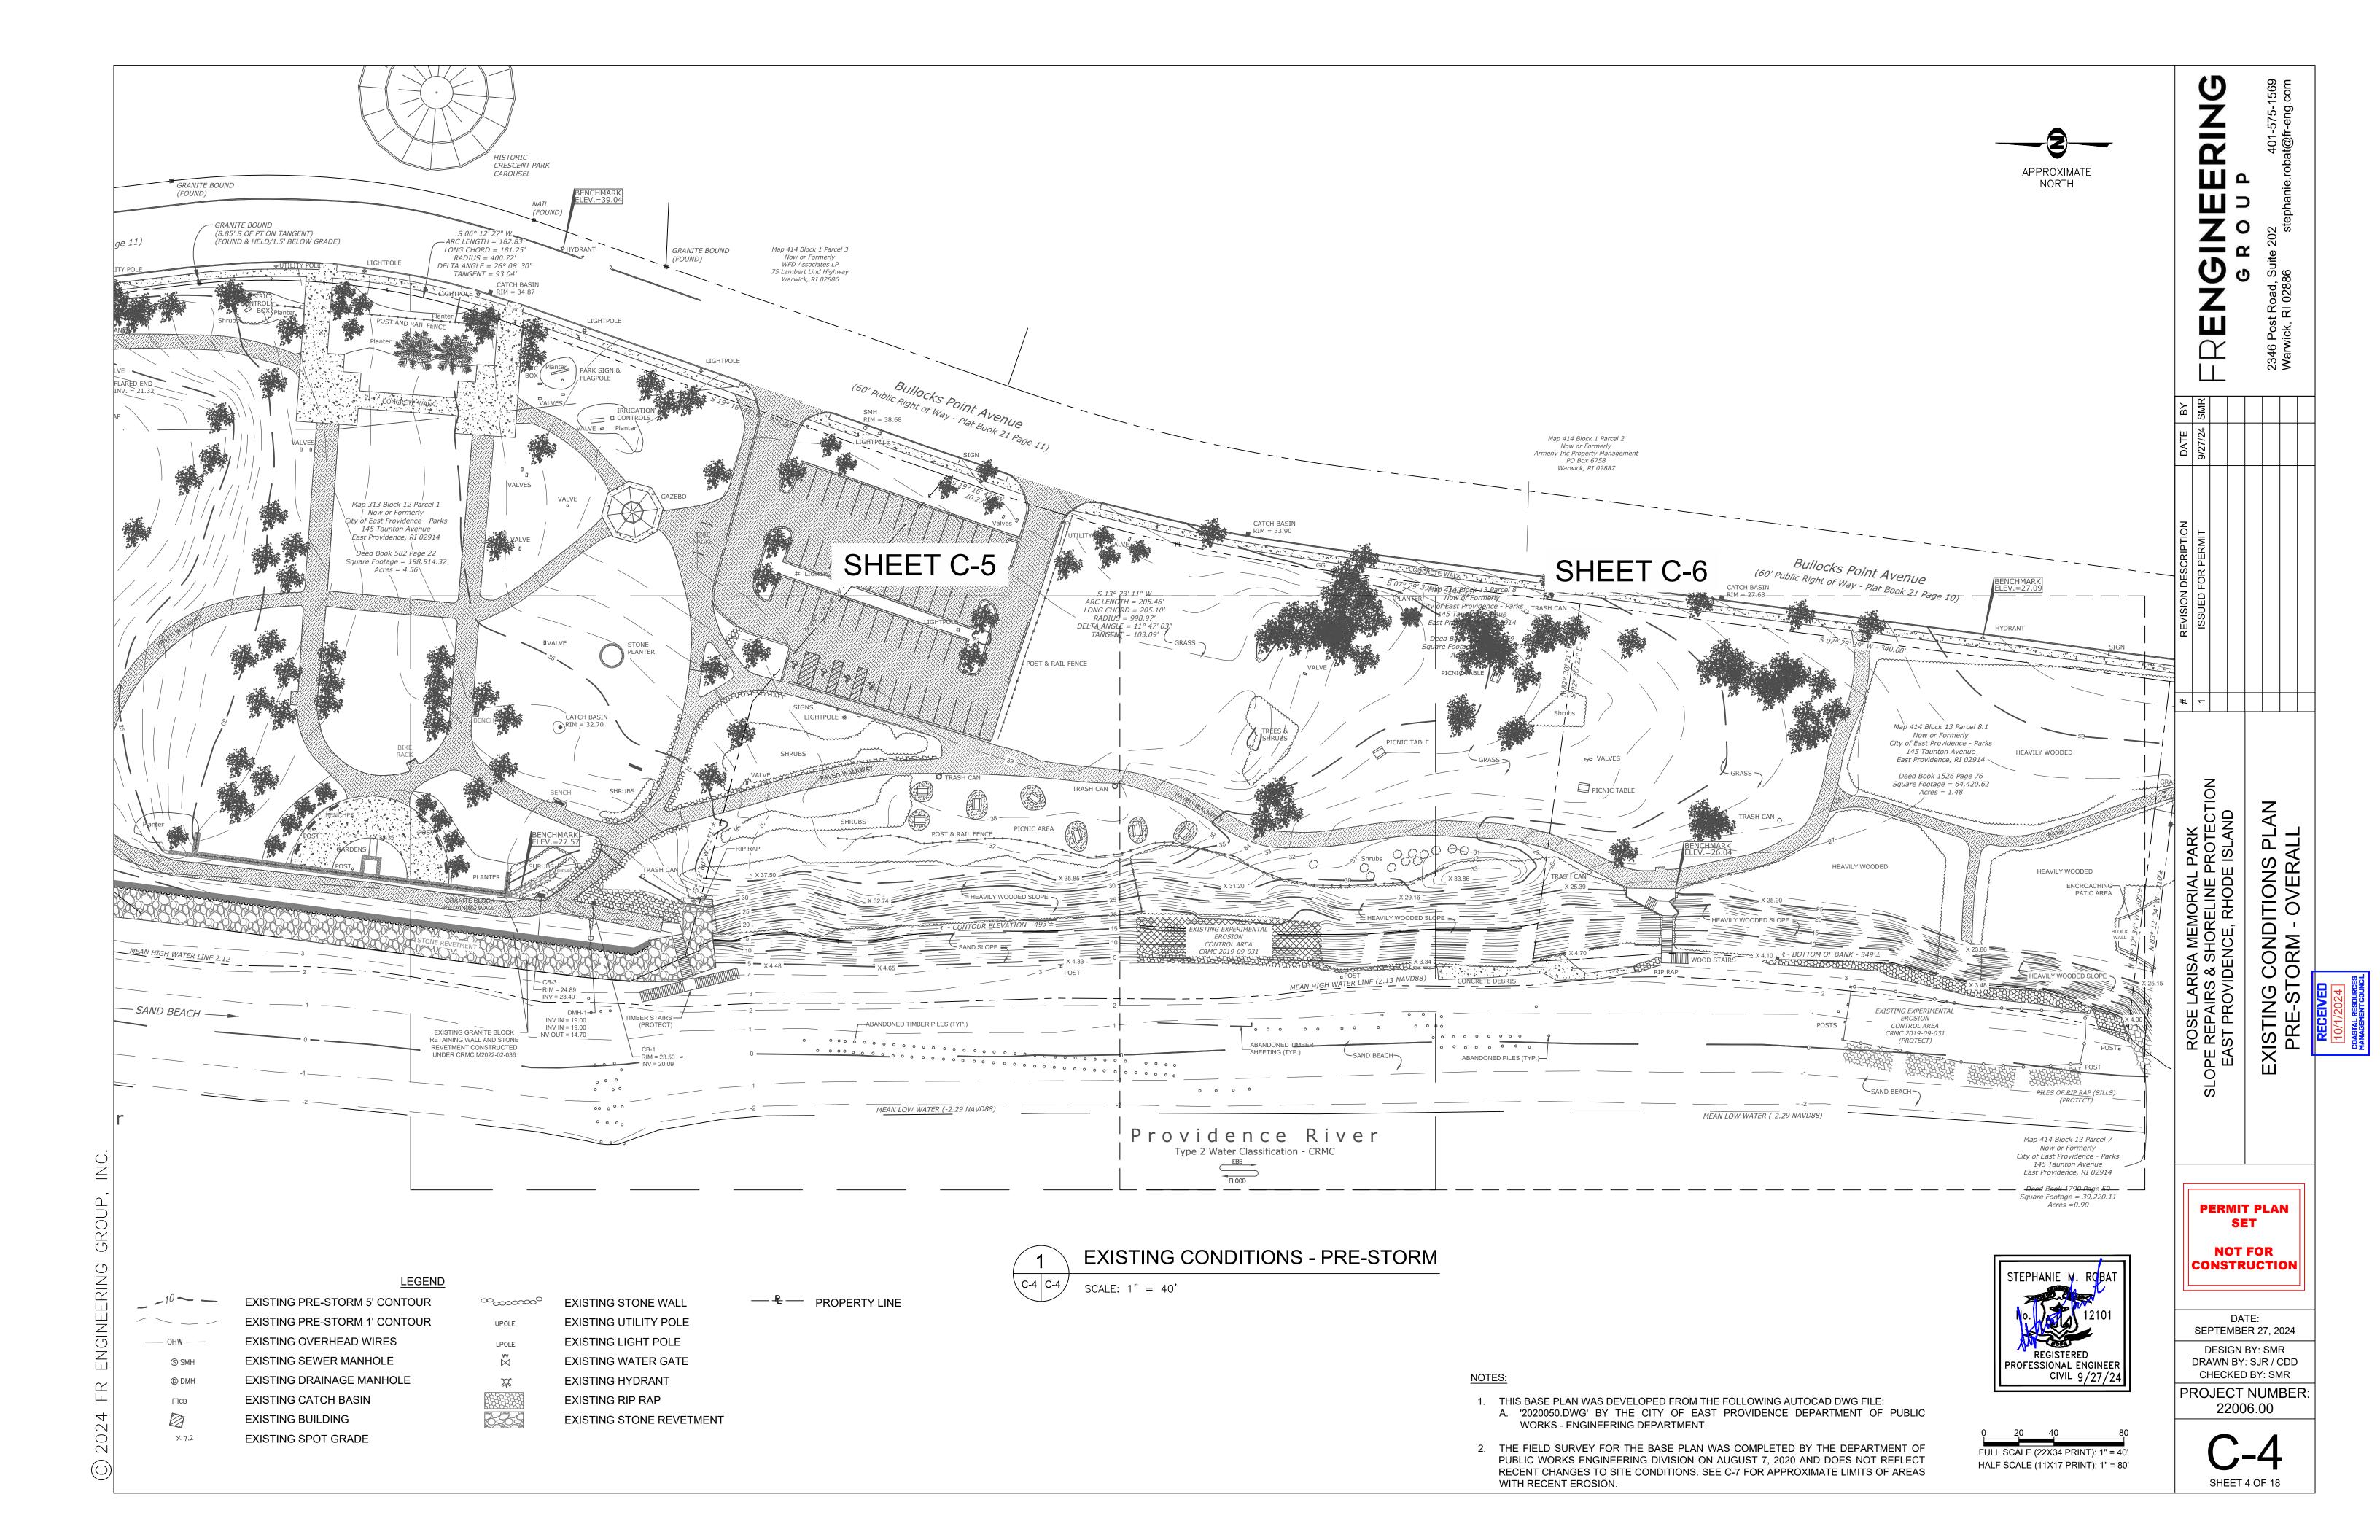

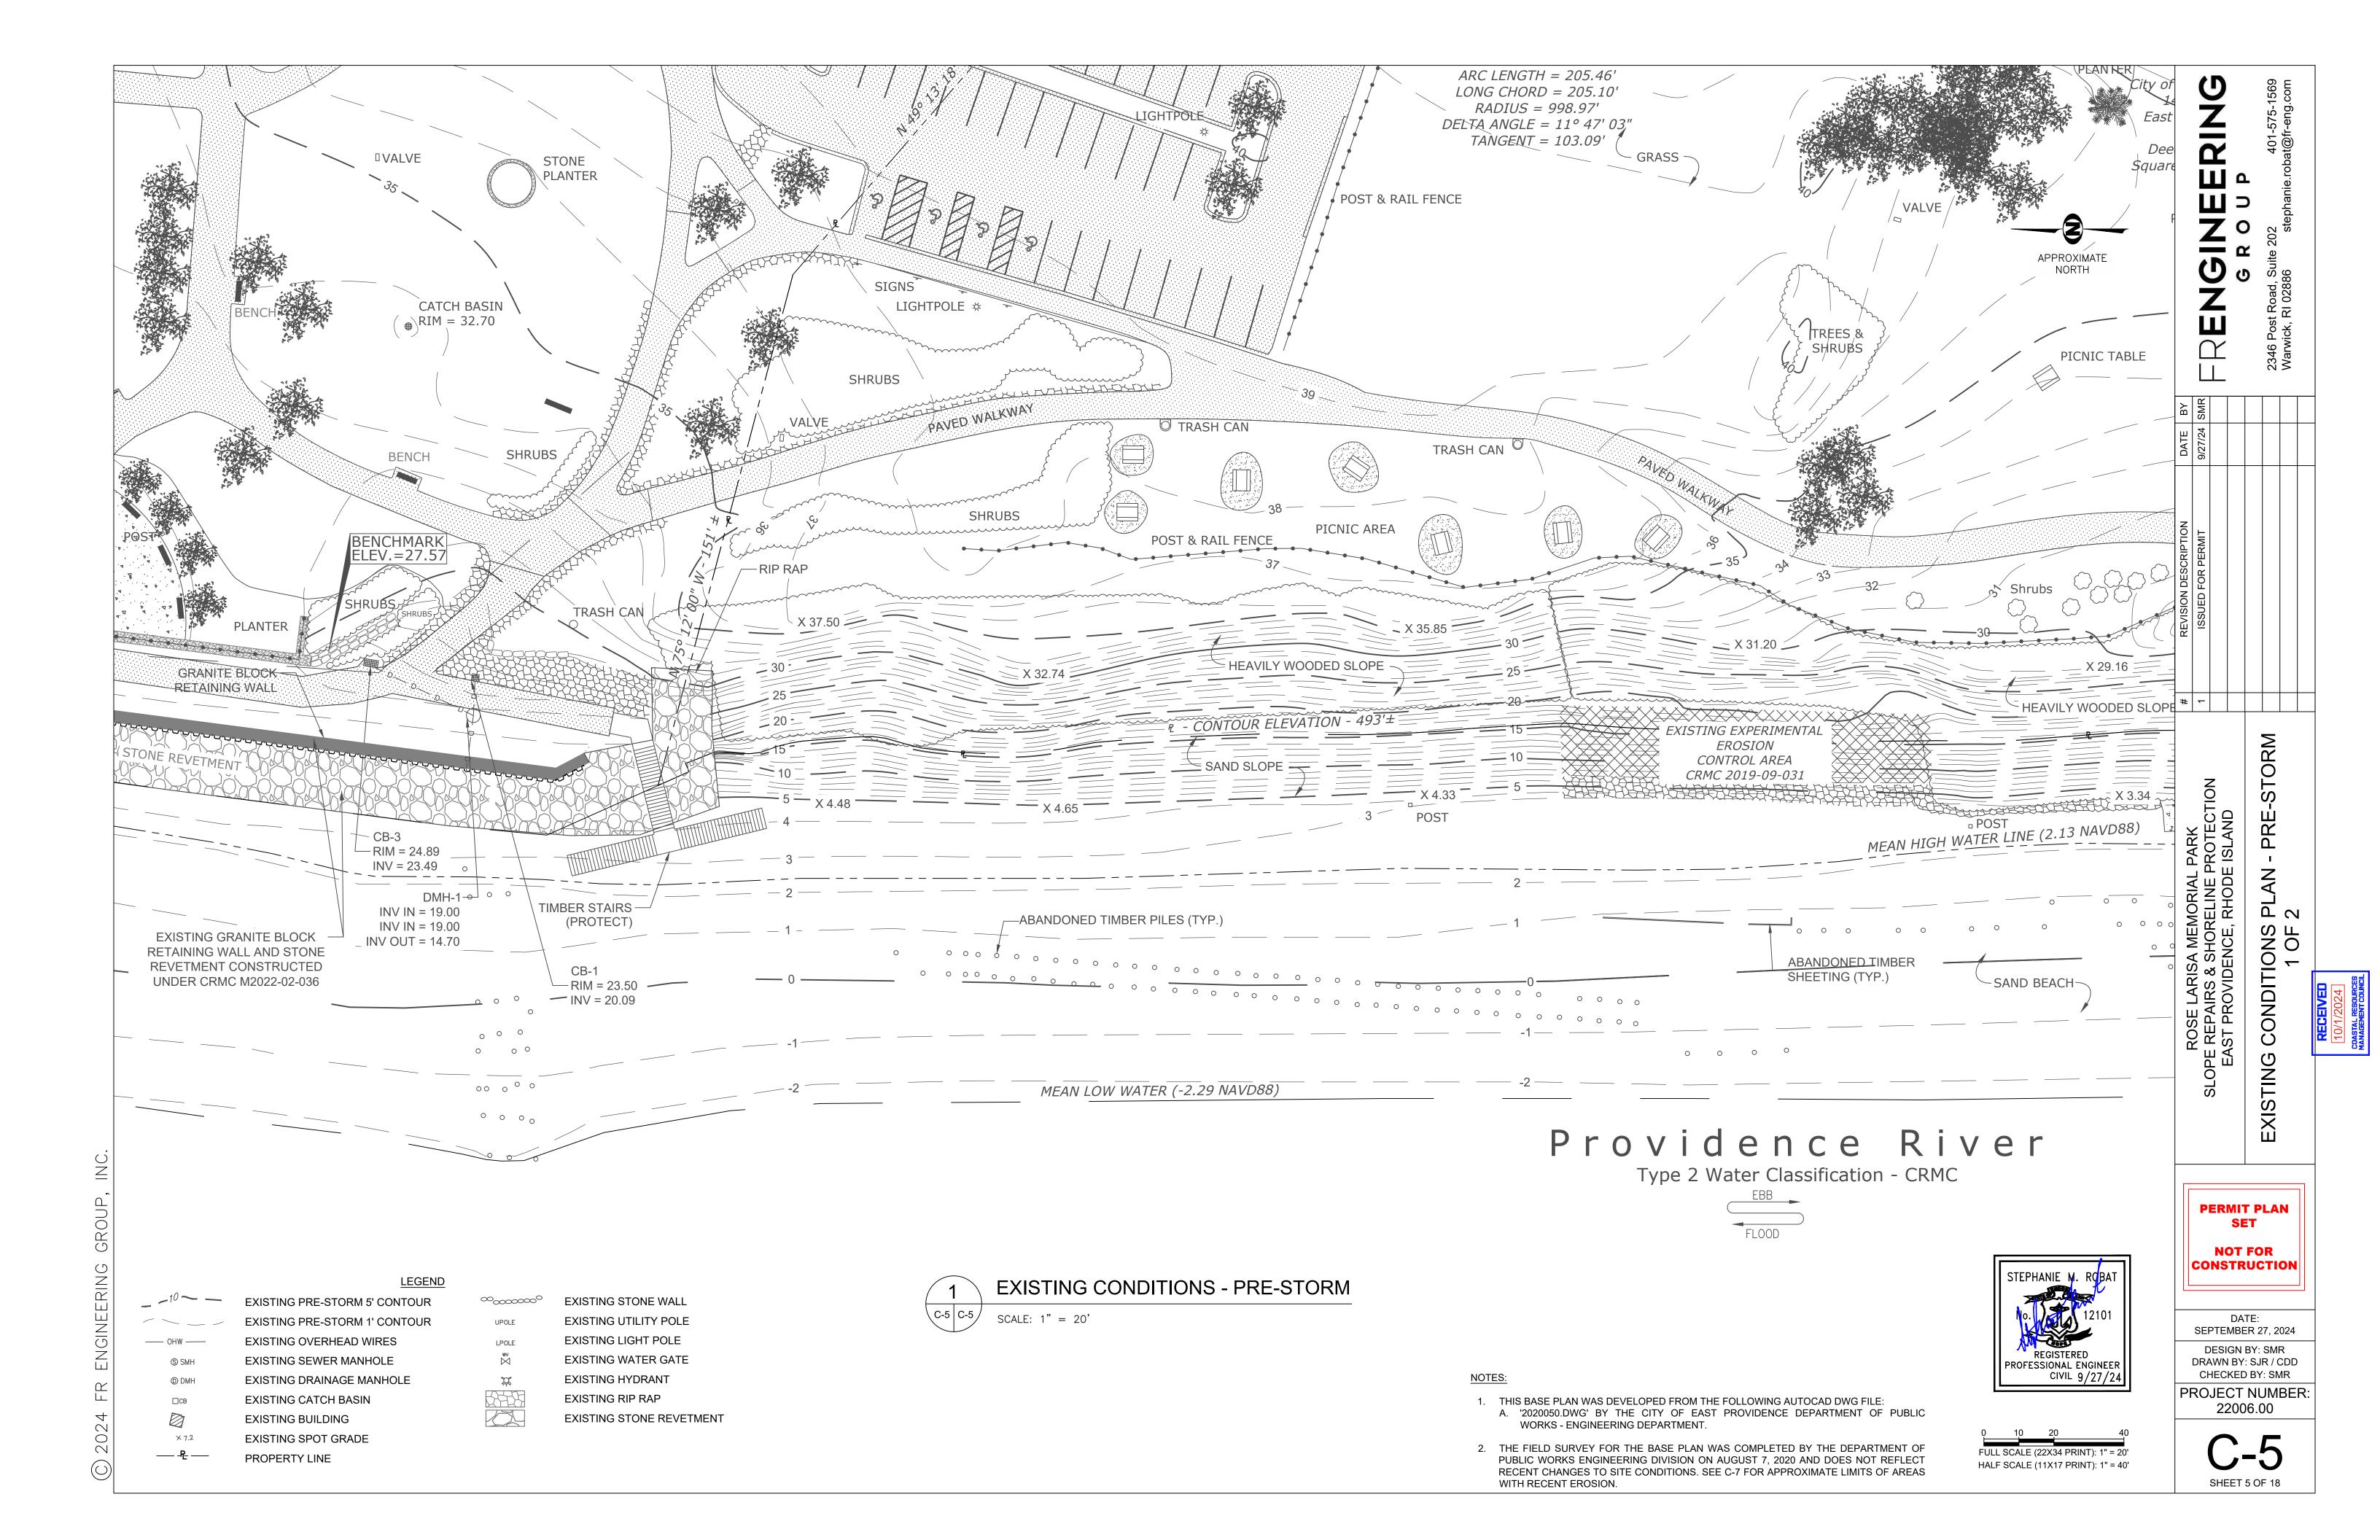

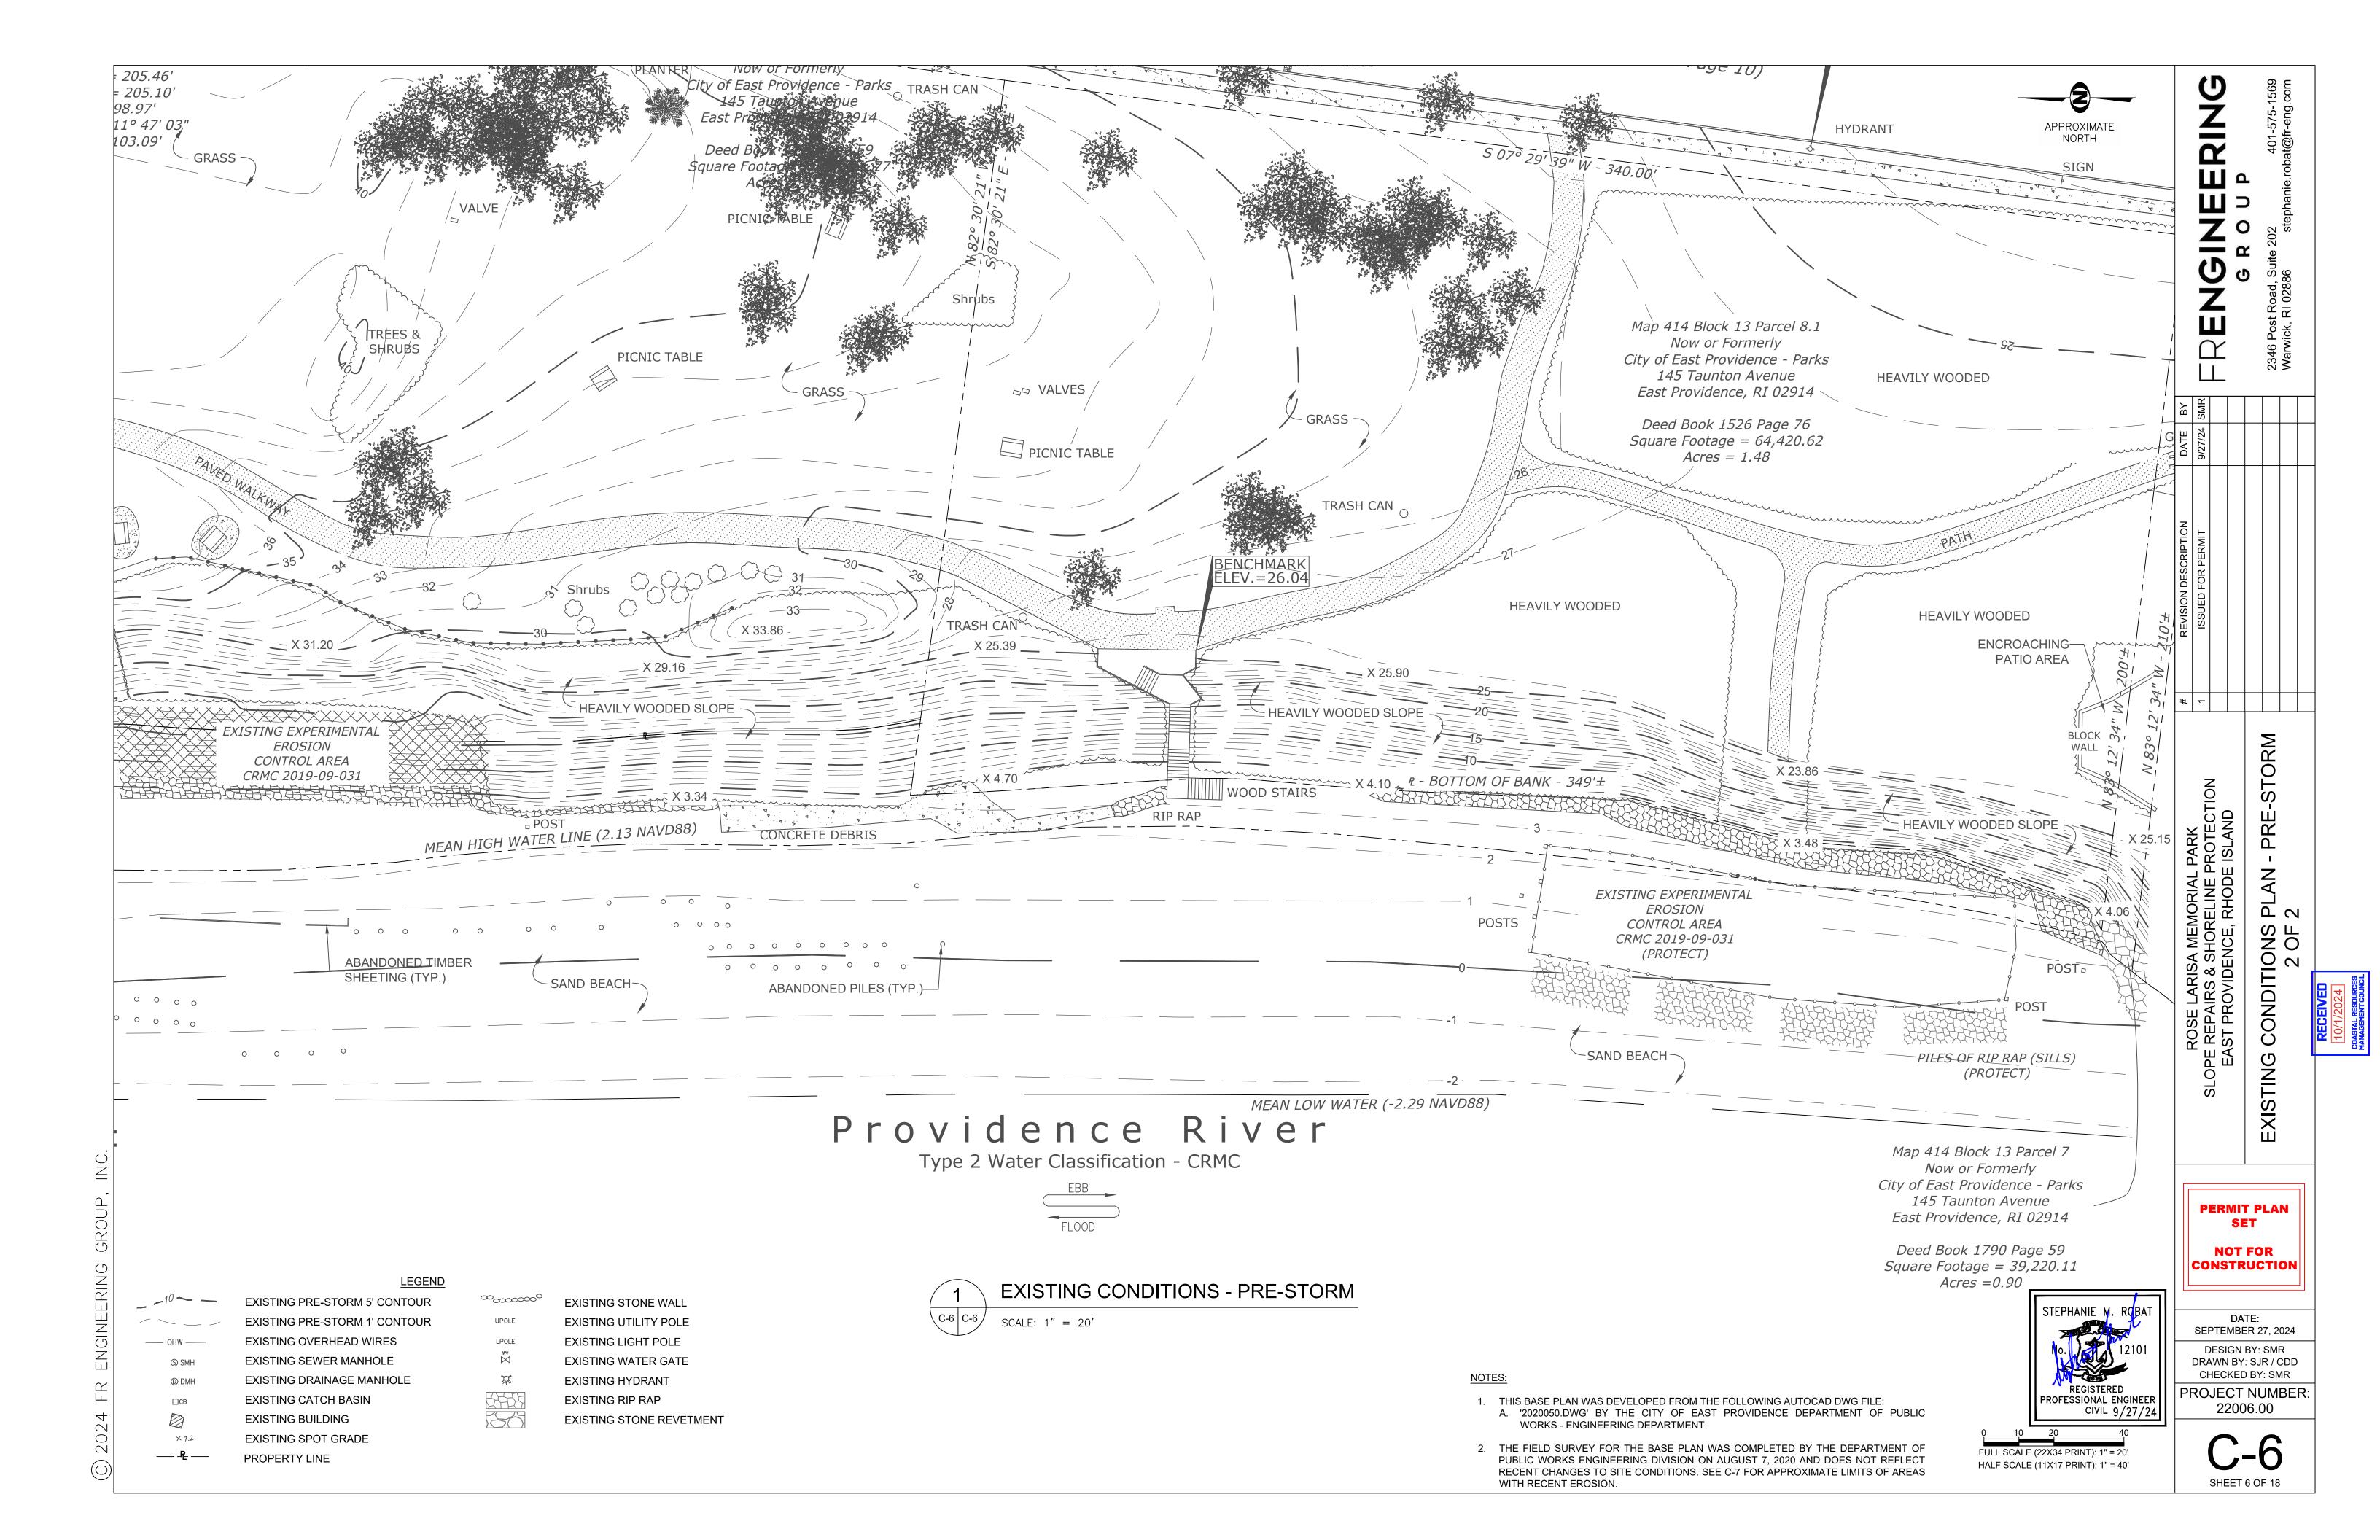

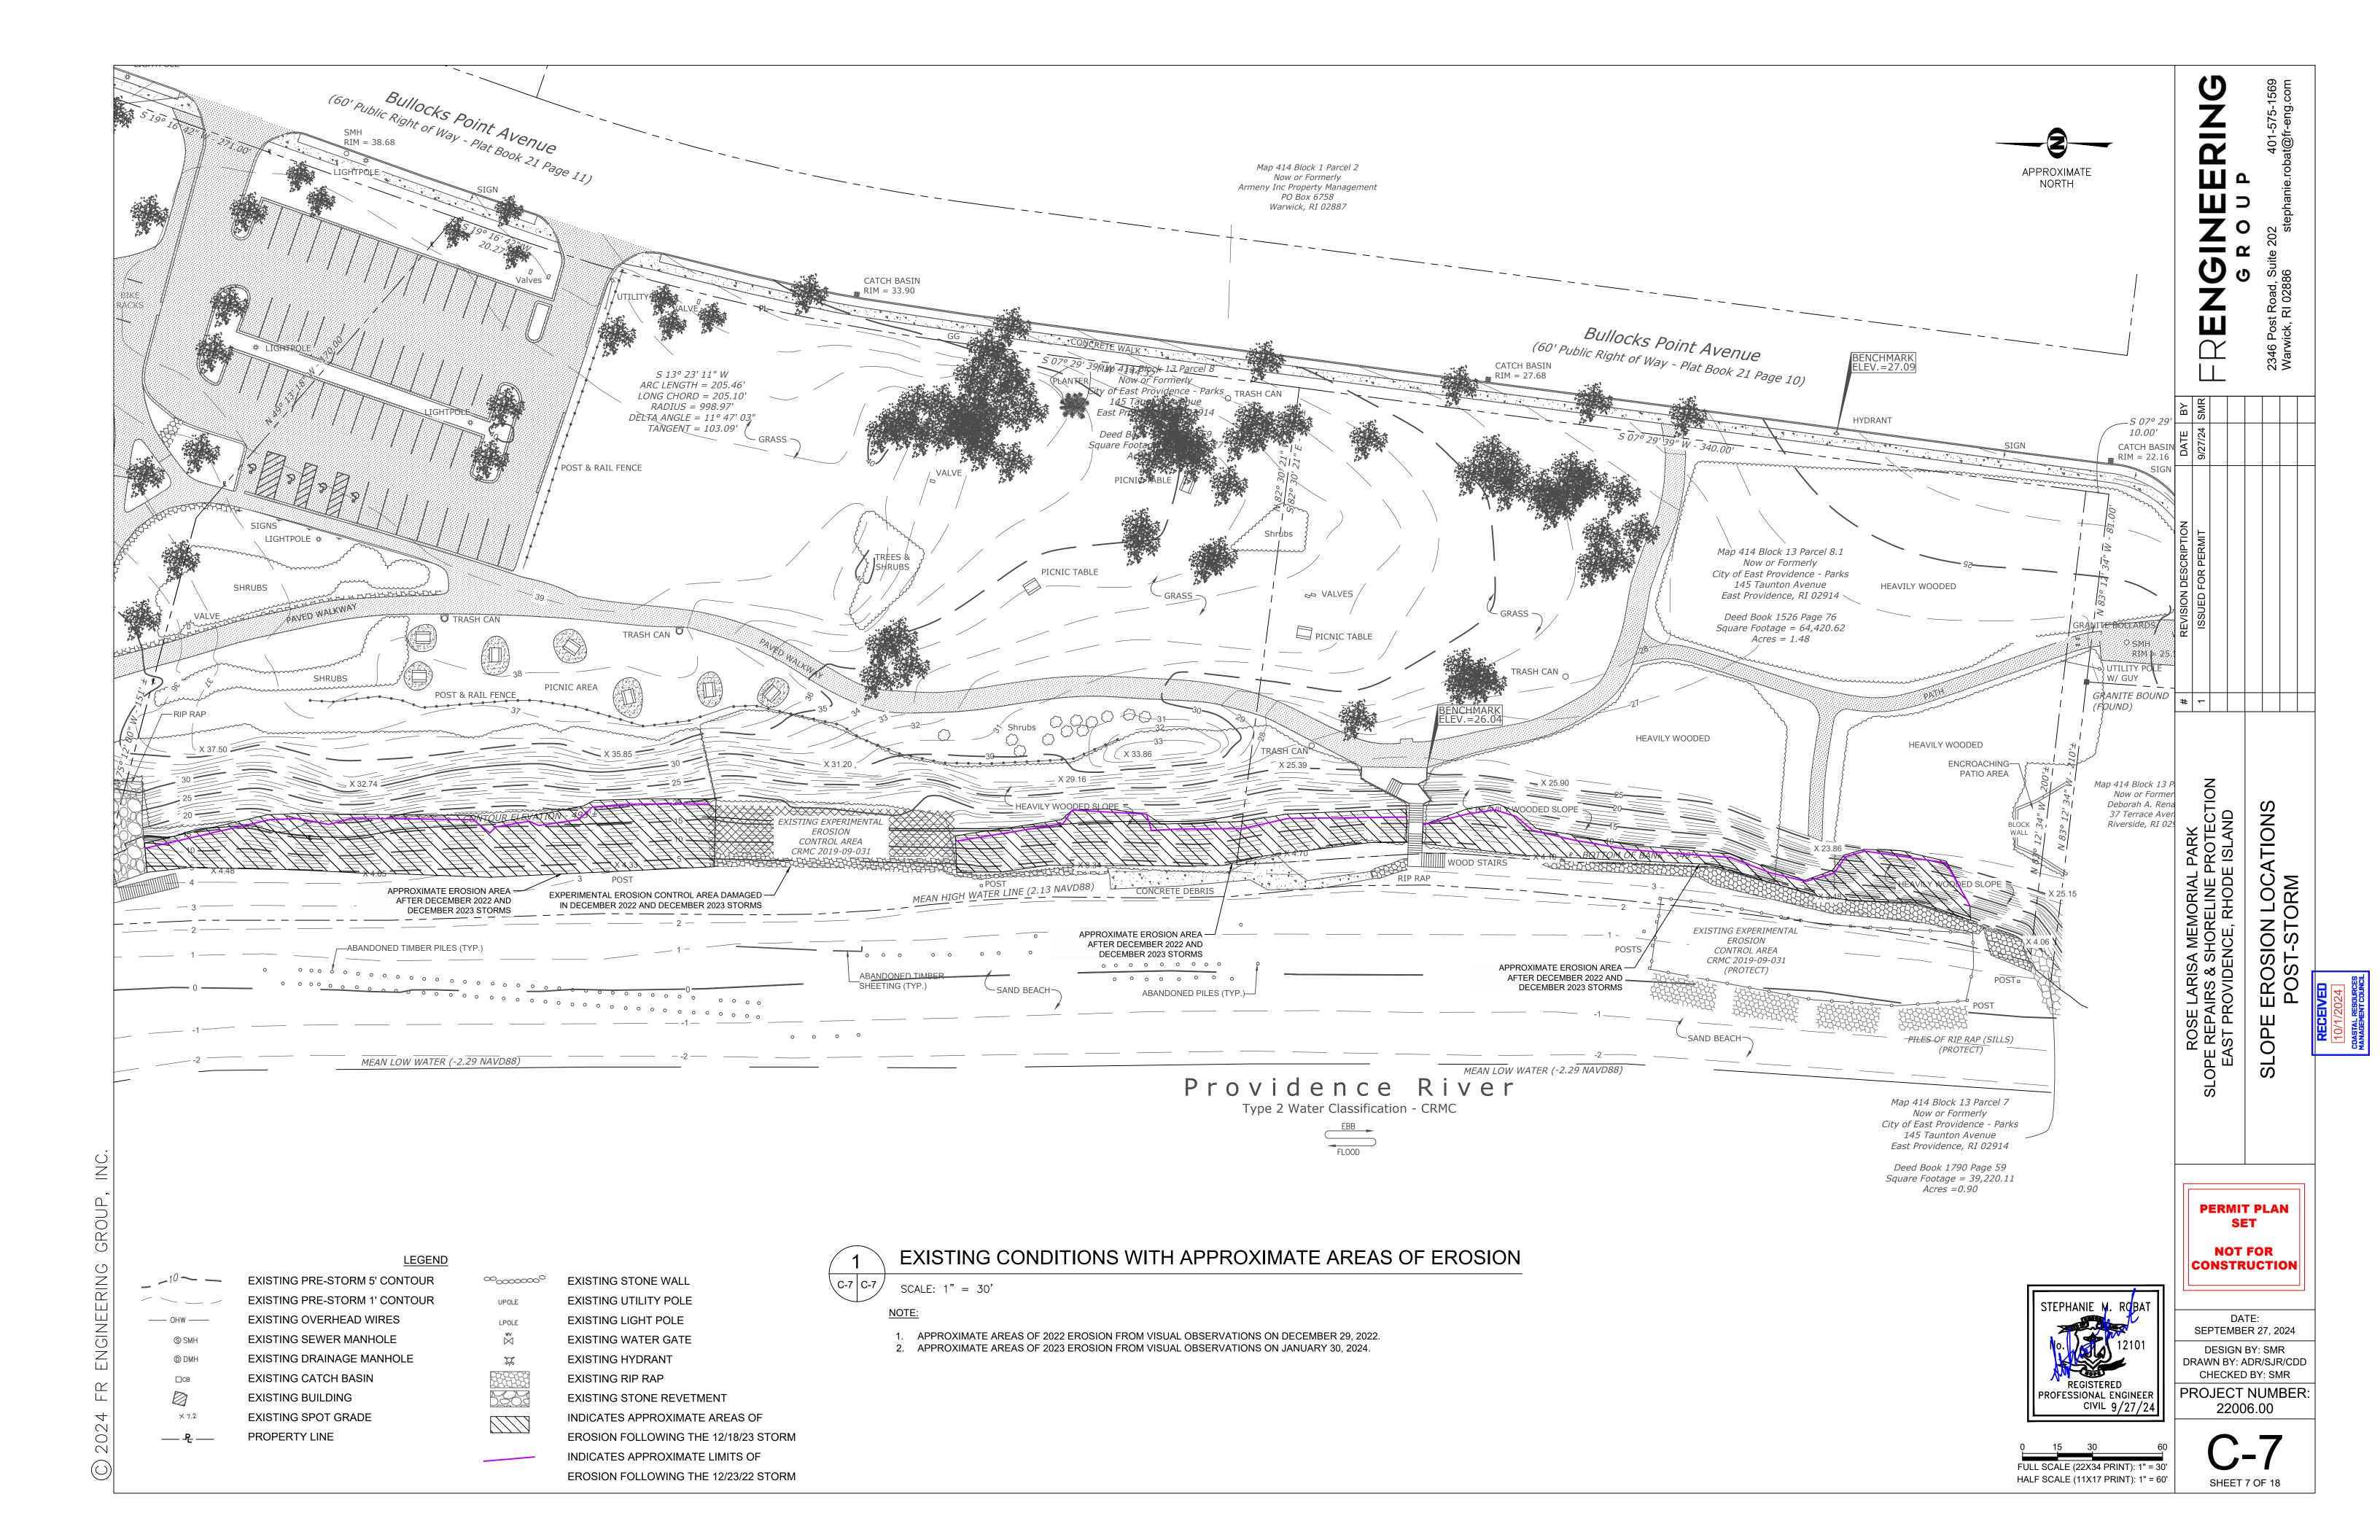

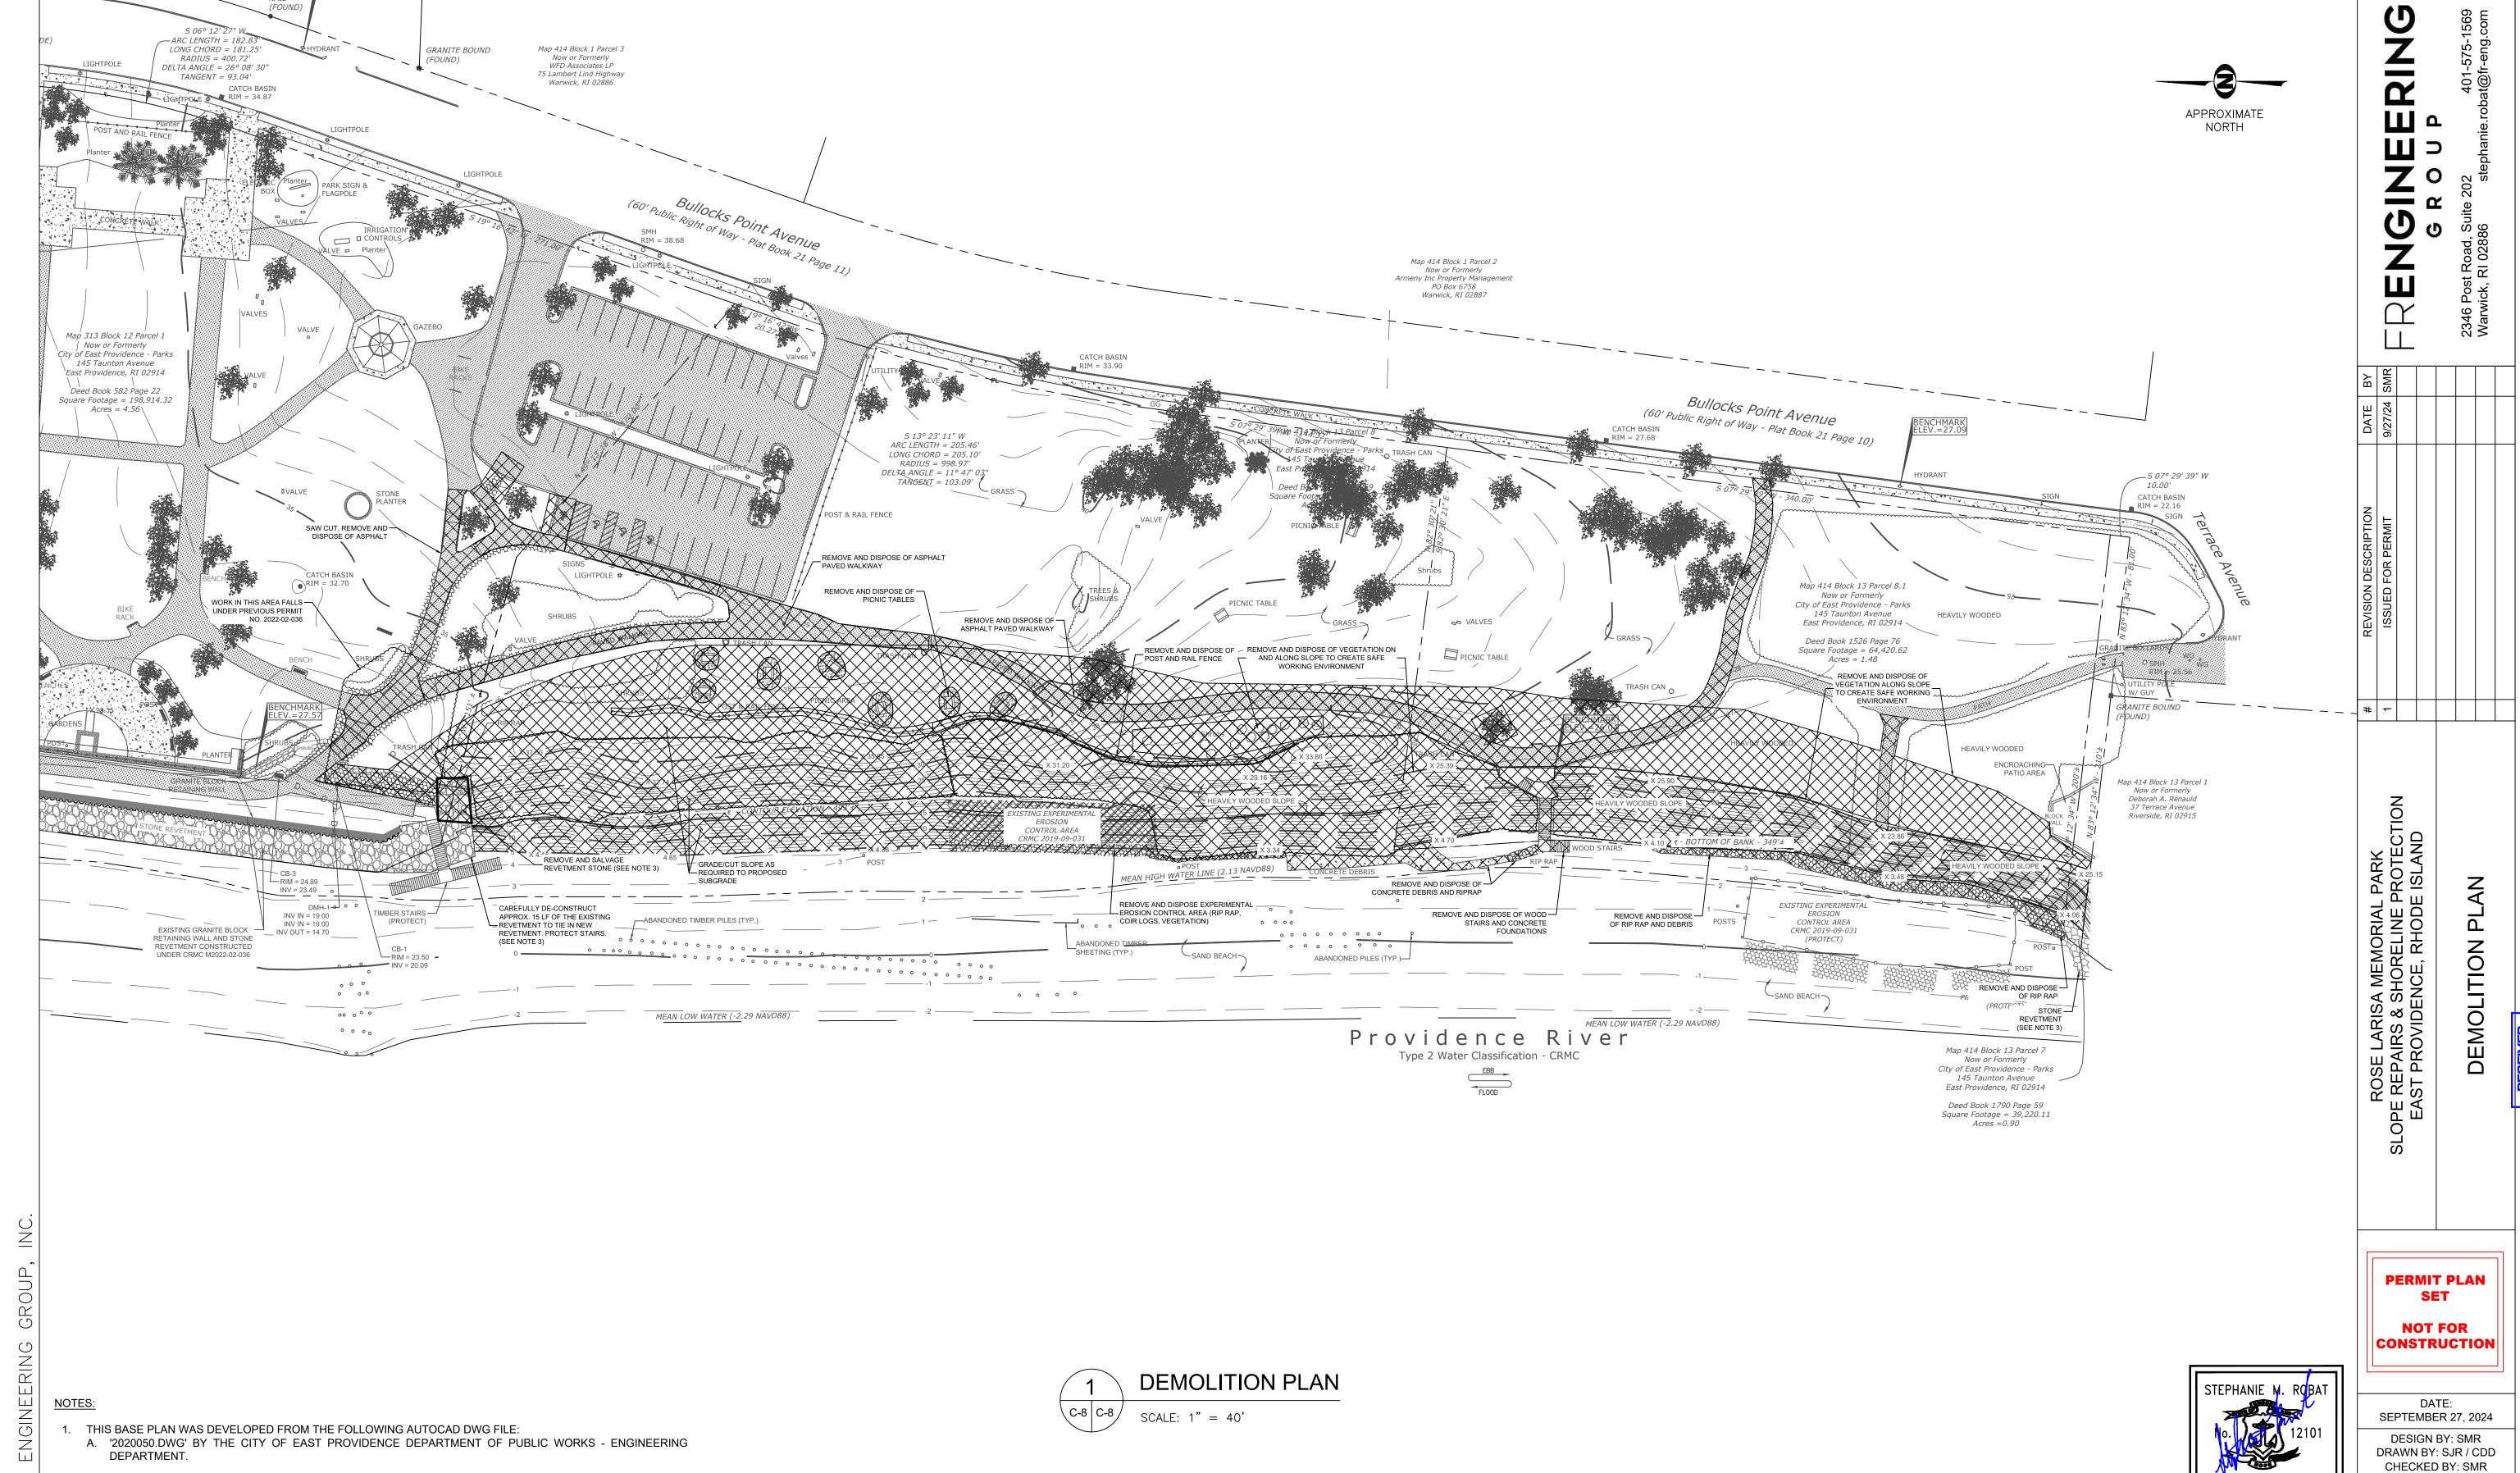

INDICATES AREA IS INCLUDED IN DEMOLITION PLAN

REGISTERED

FULL SCALE (22X34 PRINT): 1" = 40

HALF SCALE (11X17 PRINT): 1" = 80'

ROFESSIONAL ENGINEER

CIVIL 9/27/24

PROJECT NUMBER:

22006.00

SHEET 8 OF 18


THE SURVEY FOR THE BASE PLAN WAS CONDUCTED PRIOR TO THE COMPLETION OF THE NORTHERN

CONTRACTOR SHALL CAREFULLY REMOVE ARMOR STONES AT ABUTTING REVETMENT AS NEEDED TO

CONSTRUCT NEW REVETMENT WITHOUT DAMAGING THE EXISTING FILTER FABRIC. A CRANE OR SPECIALTY EXCAVATOR IS REQUIRED TO PICK UP THE STONES. USE OF AN EXCAVATOR WITHOUT A THUMB WILL NOT BE ALLOWED. DAMAGE TO ANY EXISTING STRUCTURE WILL BE REPAIRED BY THE CONTRACTOR TO THE

REVETMENT. THE LOCATION OF THE NORTHERN REVETMENT IS APPROXIMATE.

SATISFACTION OF THE CITY AND CITY'S ENGINEER AT NO COSTS TO THE CITY.

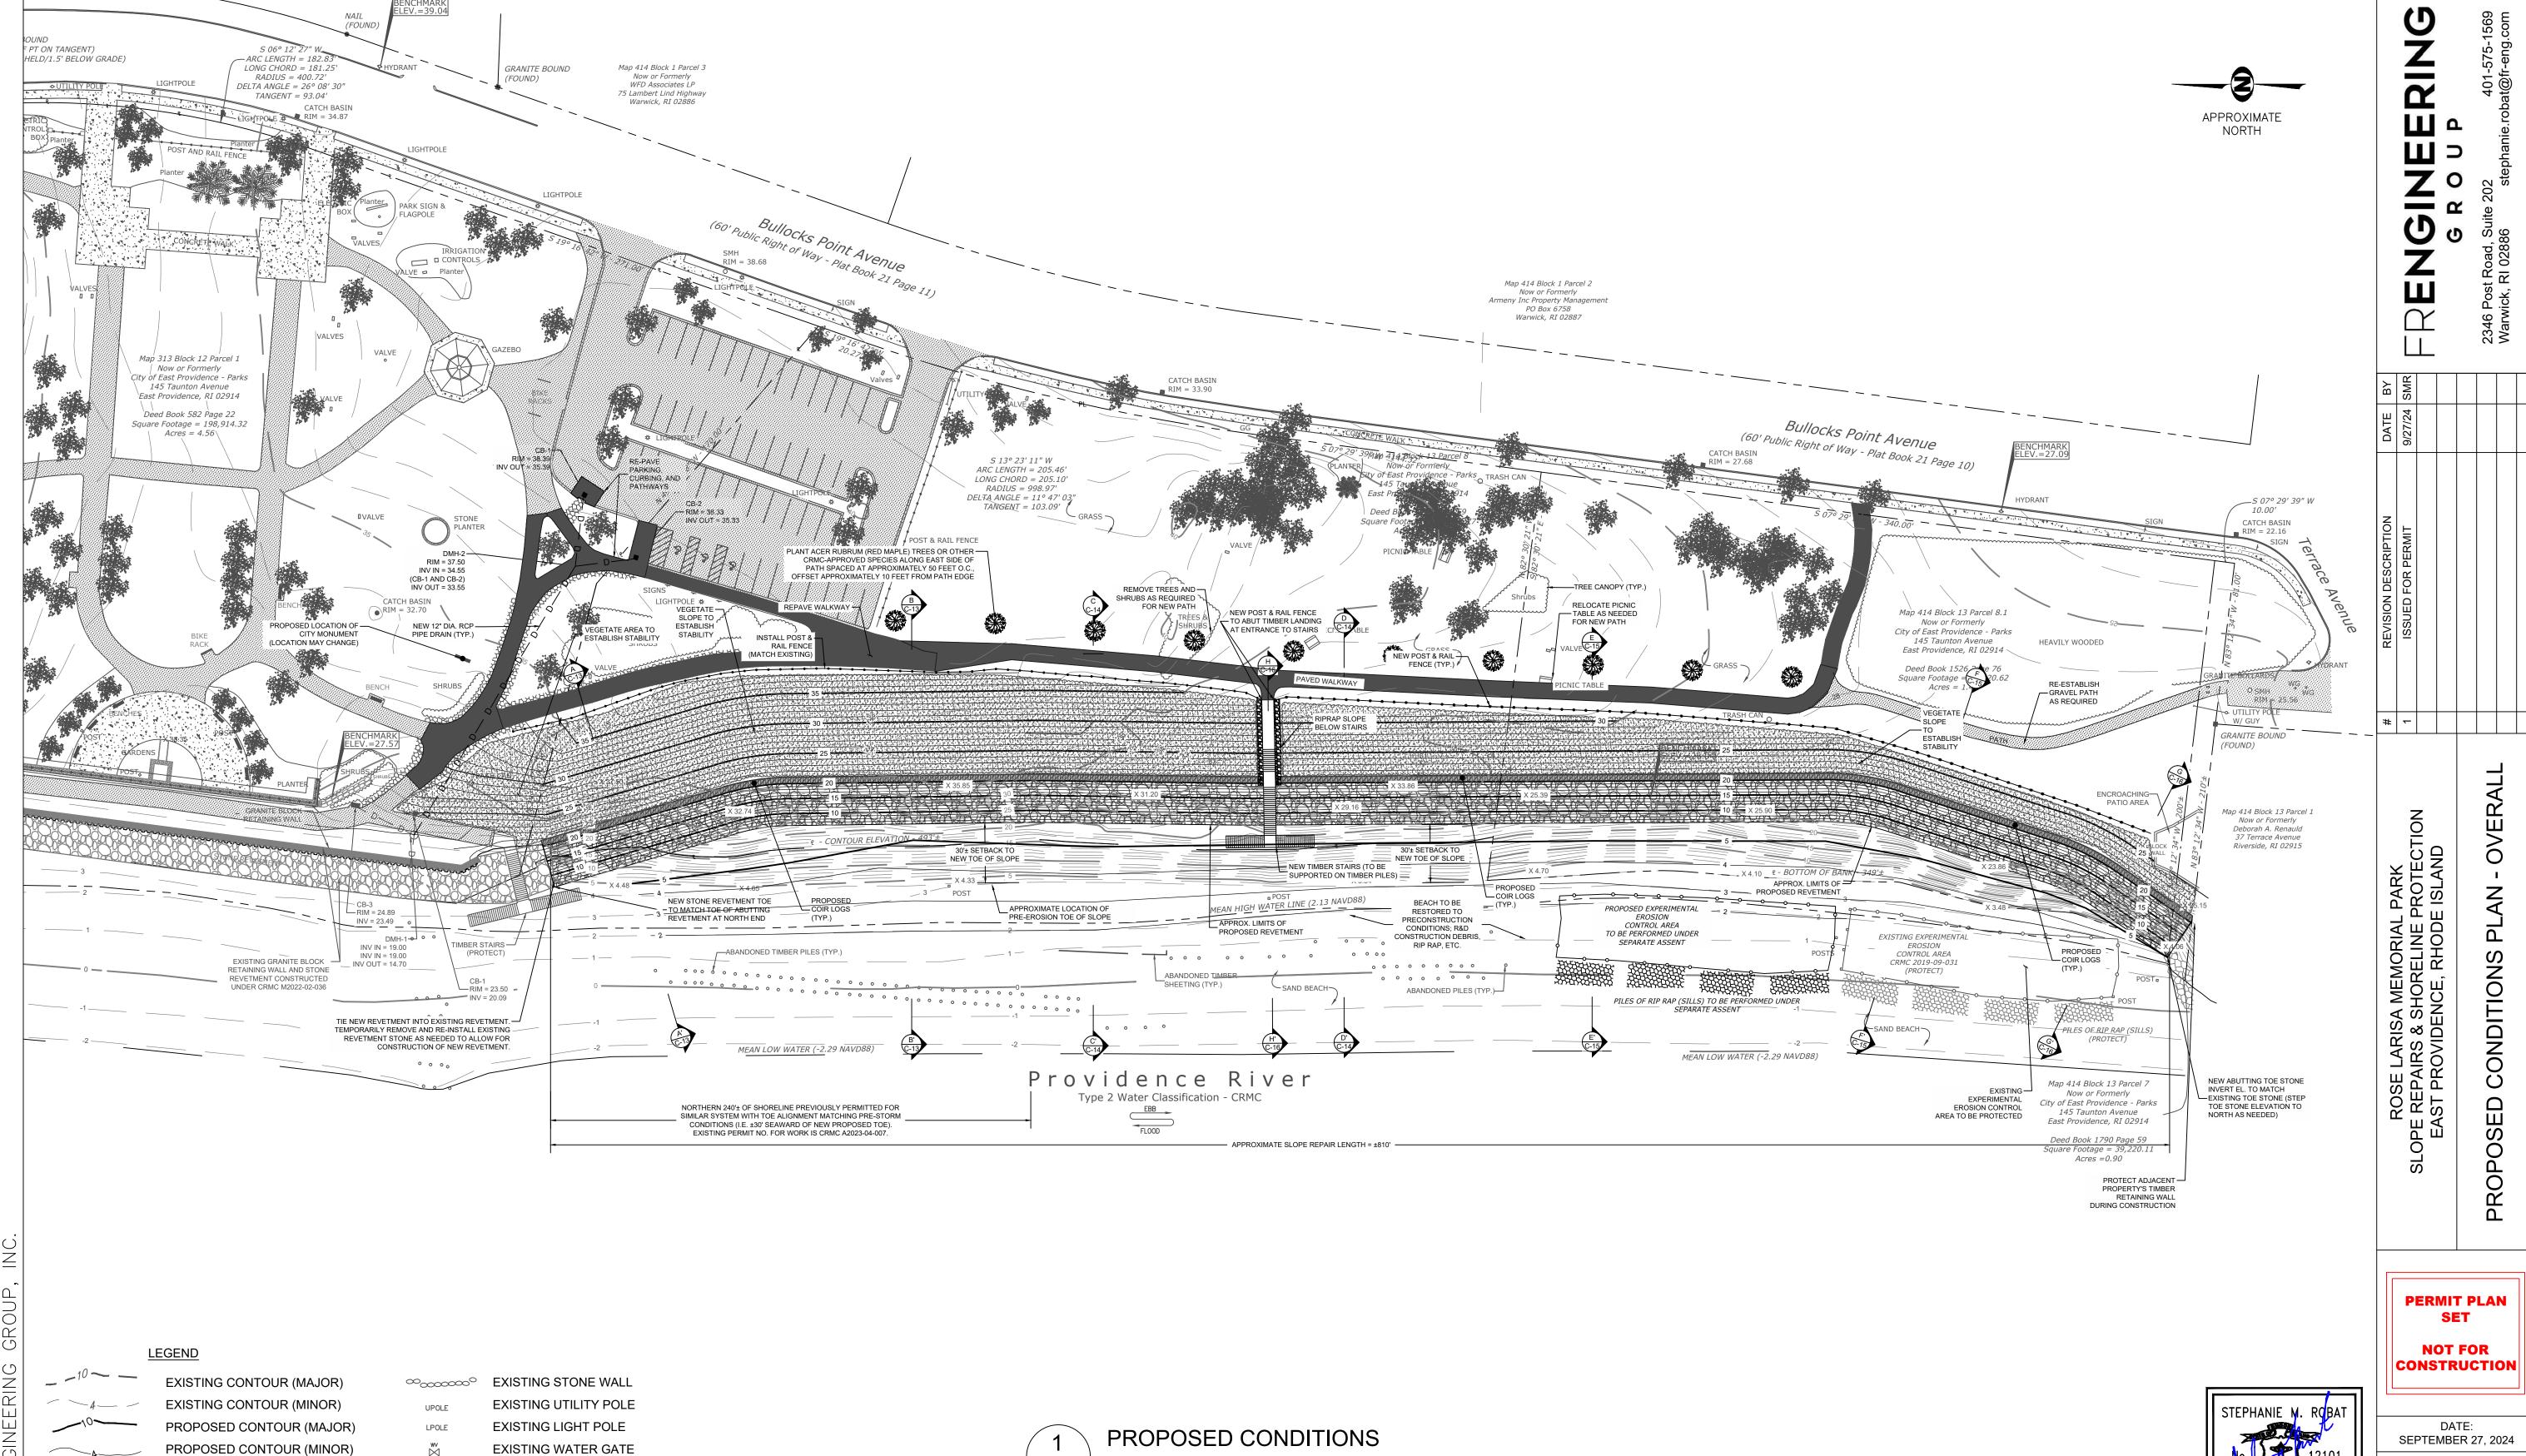

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2. CLEAN BEACH AT COMPLETION OF WORK TO ALLOW FOR RAKING.

BEACH REPLENISHMENT NEEDS.

NOTE:

SCALE: 1" = 40

1. EXCESS SAND GENERATED DURING CONSTRUCTION TO BE EVENLY DISTRIBUTED ALONG BEACH, AS NEEDED.

REMAINDER OF EXCESS SAND TO BE TRANSPORTED TO THE CITY'S YARD ON FORBES STREET FOR FUTURE

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× 7.2

EXISTING OVERHEAD WIRES

EXISTING SEWER MANHOLE

EXISTING CATCH BASIN

EXISTING SPOT GRADE

EXISTING BUILDING

EXISTING DRAINAGE MANHOLE

EXISTING HYDRANT

EXISTING STONE REVETMENT

PROPOSED VEGETATED SLOPE

PROPOSED COIR LOGS

PROPOSED NEW STONE REVETMENT

EXISTING RIP RAP

9001

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FULL SCALE (22X34 PRINT): 1" = 40' HALF SCALE (11X17 PRINT): 1" = 80' SHEET 9 OF 18

REGISTERED

ROFESSIONAL ENGINEER

CIVIL 9/27/24


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DRAWN BY: SJR / CDD

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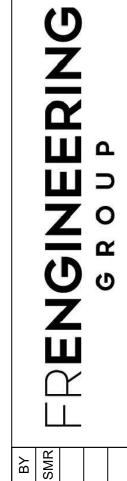
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NOTES:

- 1. A TWO ARMOR STONE LAYER REVETMENT SYSTEM IS SHOWN. A THIRD LAYER OF STONE MAY BE REQUIRED DEPENDING ON THE ACTUAL SIZE AND GEOMETRY OF THE STONES PLACED TO MEET THE MINIMUM TOP OF REVETMENT ELEVATION.
- 2. RECENTLY ERODED AREAS ARE NOT REFLECTED IN THE APPROXIMATE EXISTING GRADE SHOWN.
- 3. FEMA HAS ISSUED FIS NO. 44007CV001D, DATED JULY 19, 2023 FOR PROVIDENCE COUNTY, RHODE ISLAND. THE TOP OF THE REVETMENT STONE HAS BEEN SET TO EL. +20 FT TO REFLECT THE BFE PROVIDED FOR THE SITE IN THE REPORT. THE REVETMENT WAS DESIGNED FOR A SIGNIFICANT WAVE HEIGHT OF 7.6 FT IN ACCORDANCE WITH THE 2015 FIS TO MAINTAIN DESIGN CONSISTENCY WITH THE ADJACENT REVETMENT SYSTEMS.
- 4. CONTRACTOR TO PRUNE OR REMOVE DEAD, UNSTABLE/UNSAFE VEGETATION AS NEEDED TO CREATE A SAFE WORKING ENVIRONMENT. EXISTING TREES AND VEGETATION ALONG SLOPE NOT SHOWN FOR CLARITY.



#	REVISION DESCRIPTION	DATE
_	ISSUED FOR PERMIT	9/27/2

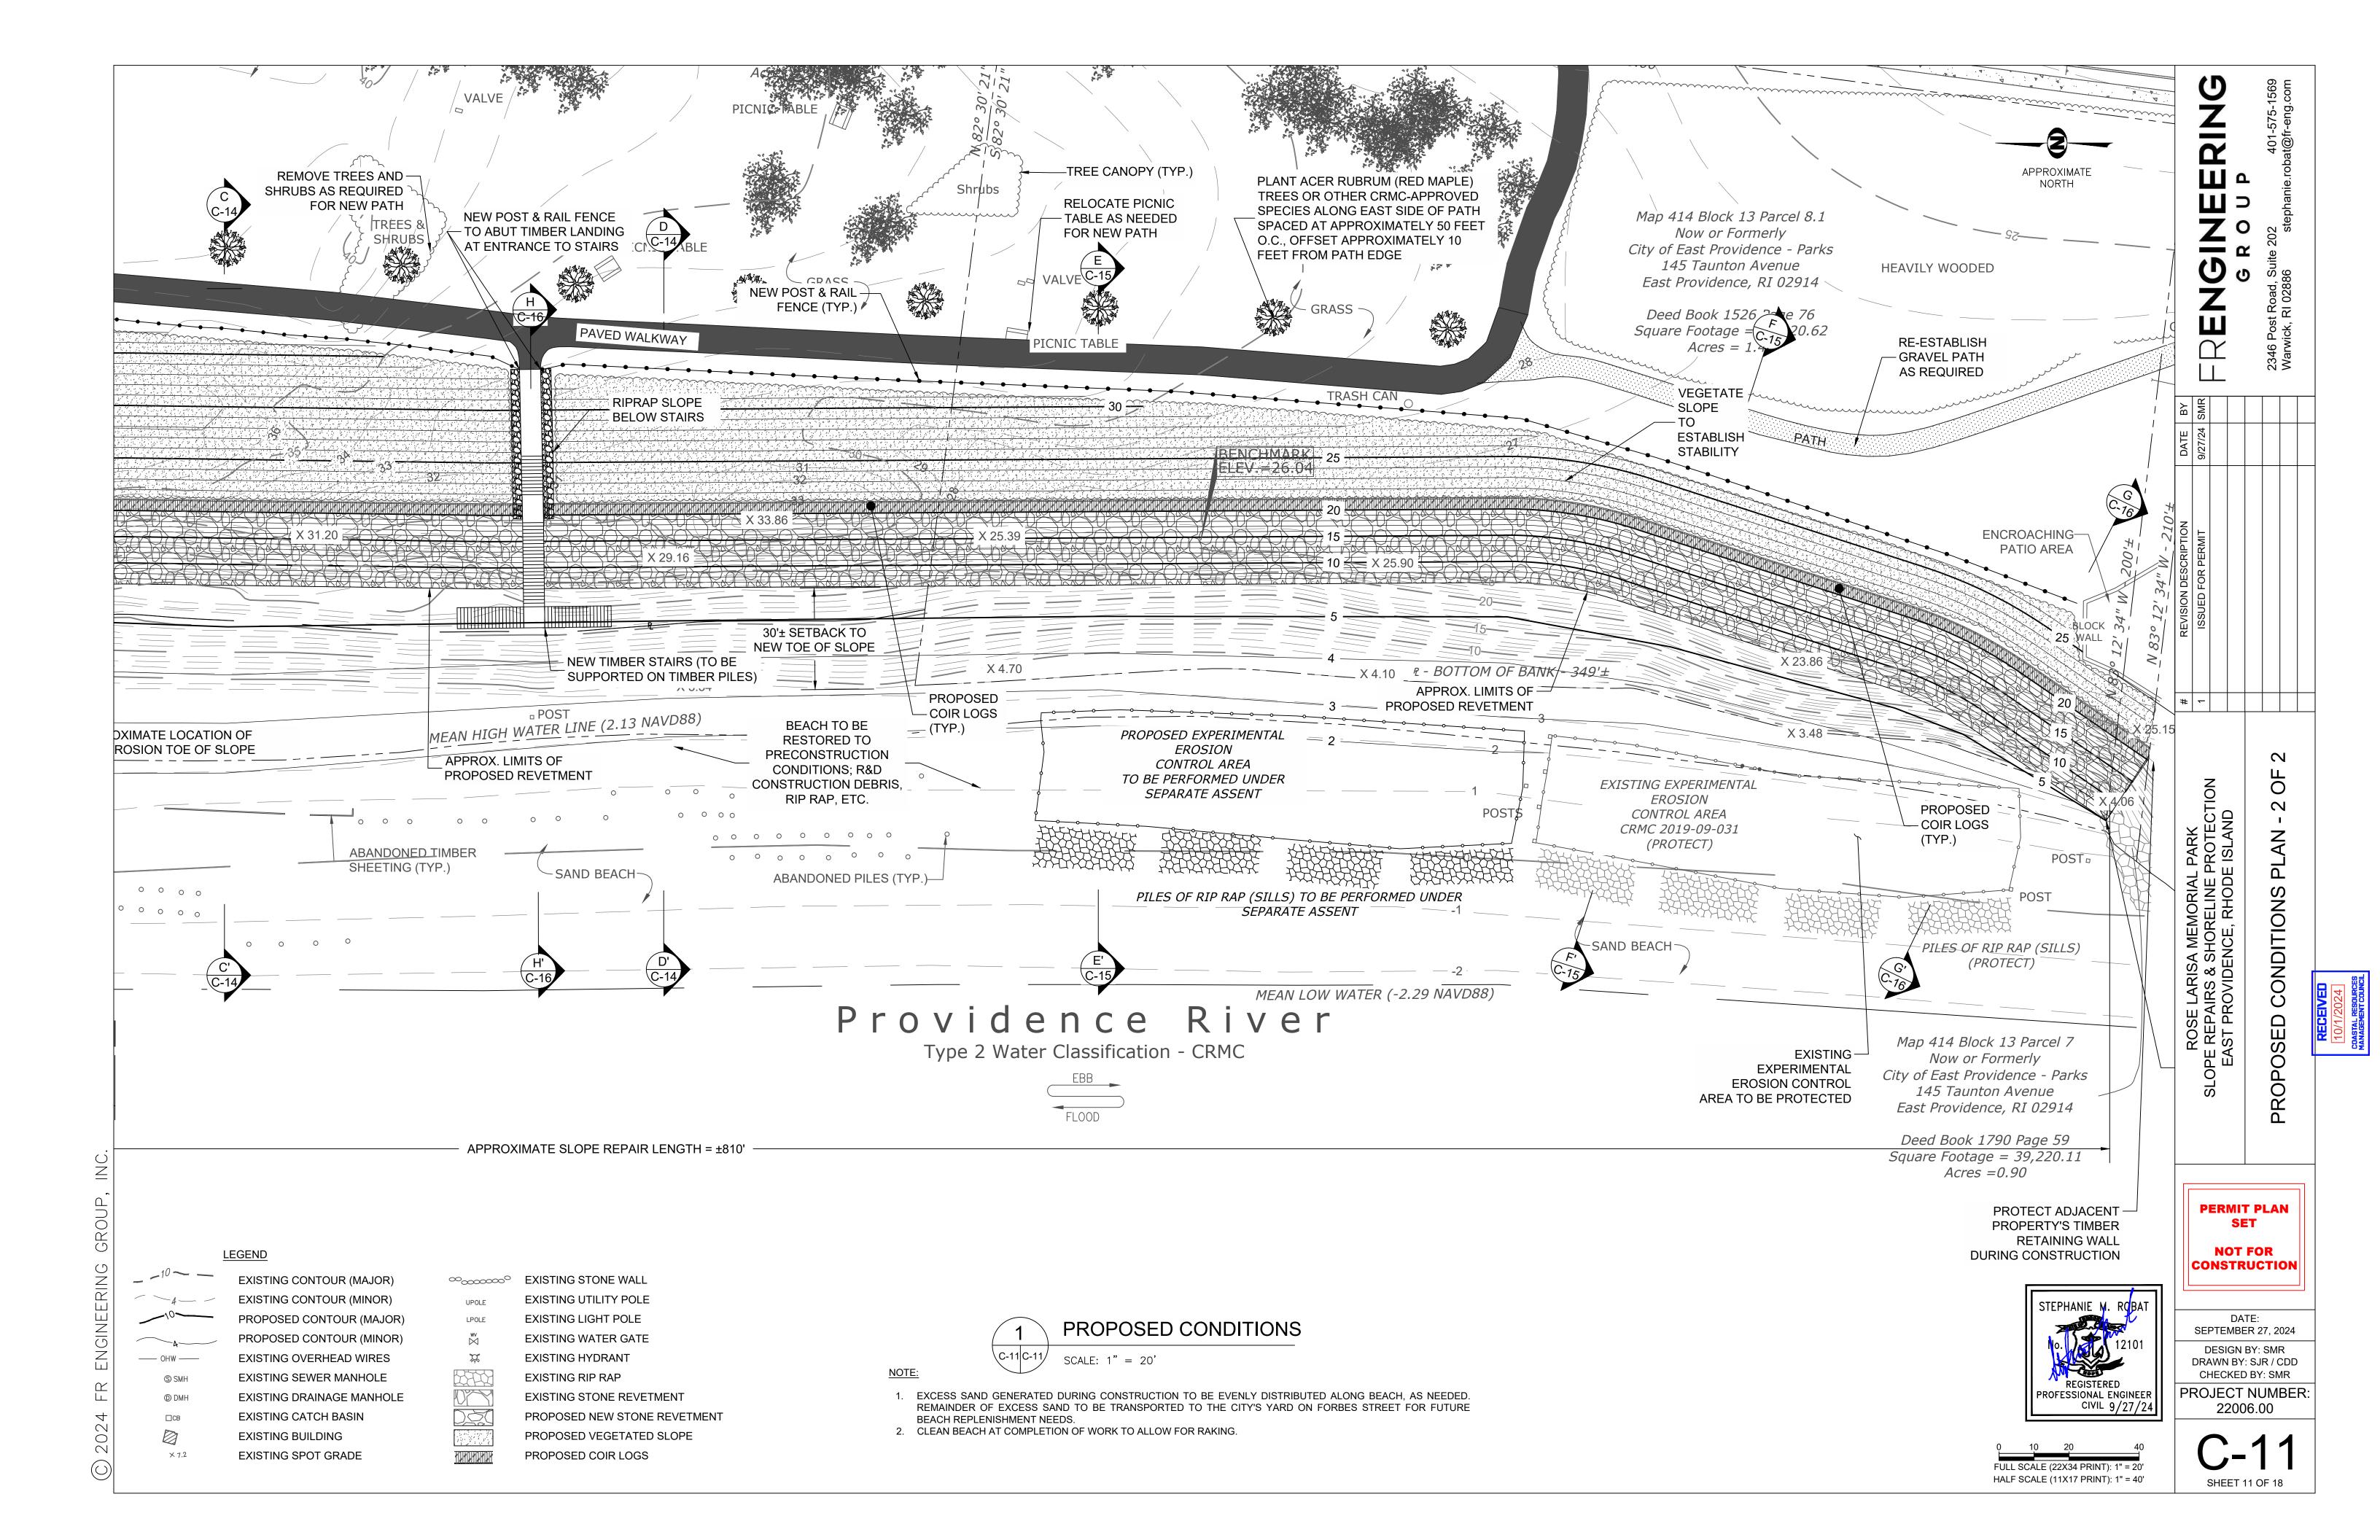ROSE LARISA MEMOSLOPE REPAIRS & SHORE EAST PROVIDENCE, F 2 SLOP


PERMIT PLAN SET **NOT FOR** CONSTRUCTION

SEPTEMBER 27, 2024

DESIGN BY: SMR


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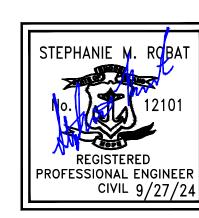
PROJECT NUMBER: CIVIL 9/27/24 22006.00 FULL SCALE (22X34 PRINT): 1" = 10

HALF SCALE (11X17 PRINT): 1" = 20' SHEET 12 OF 18

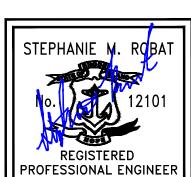

REVETMENT SECTION B-B' SCALE: 1" = 10'

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FULL SCALE (22X34 PRINT): 1" = 10 HALF SCALE (11X17 PRINT): 1" = 20'

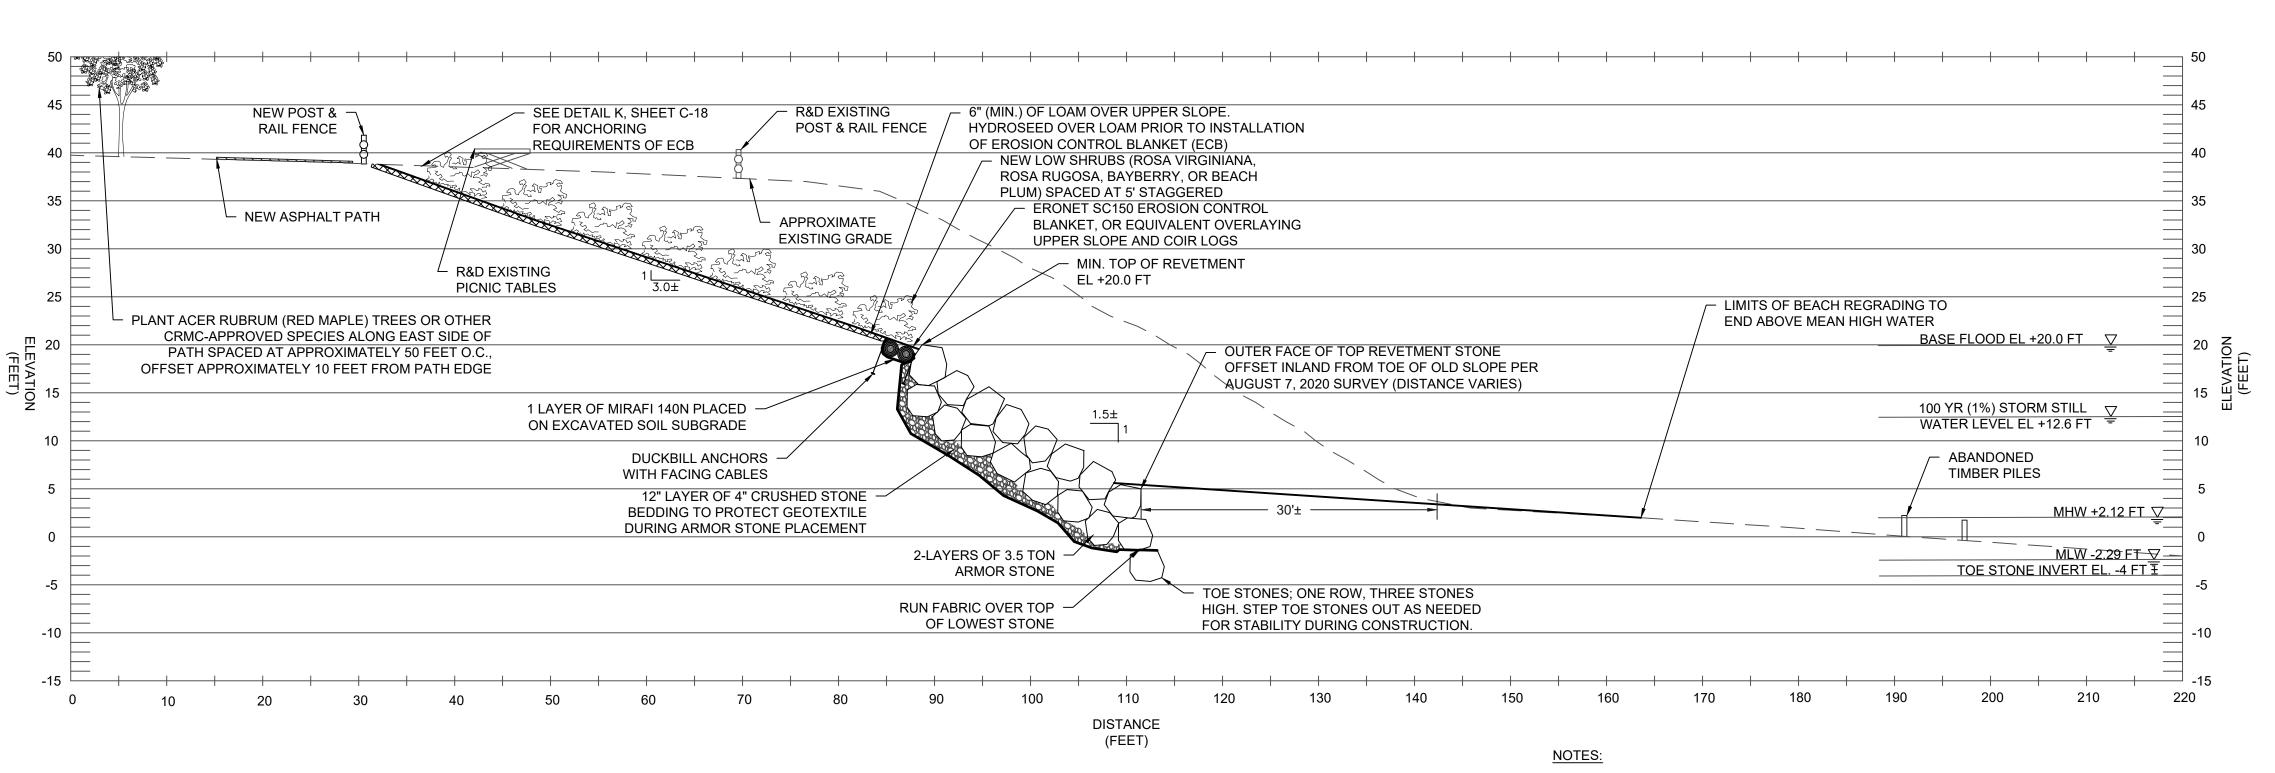PROJECT NUMBER: 22006.00 SHEET 13 OF 18

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SEPTEMBER 27, 2024

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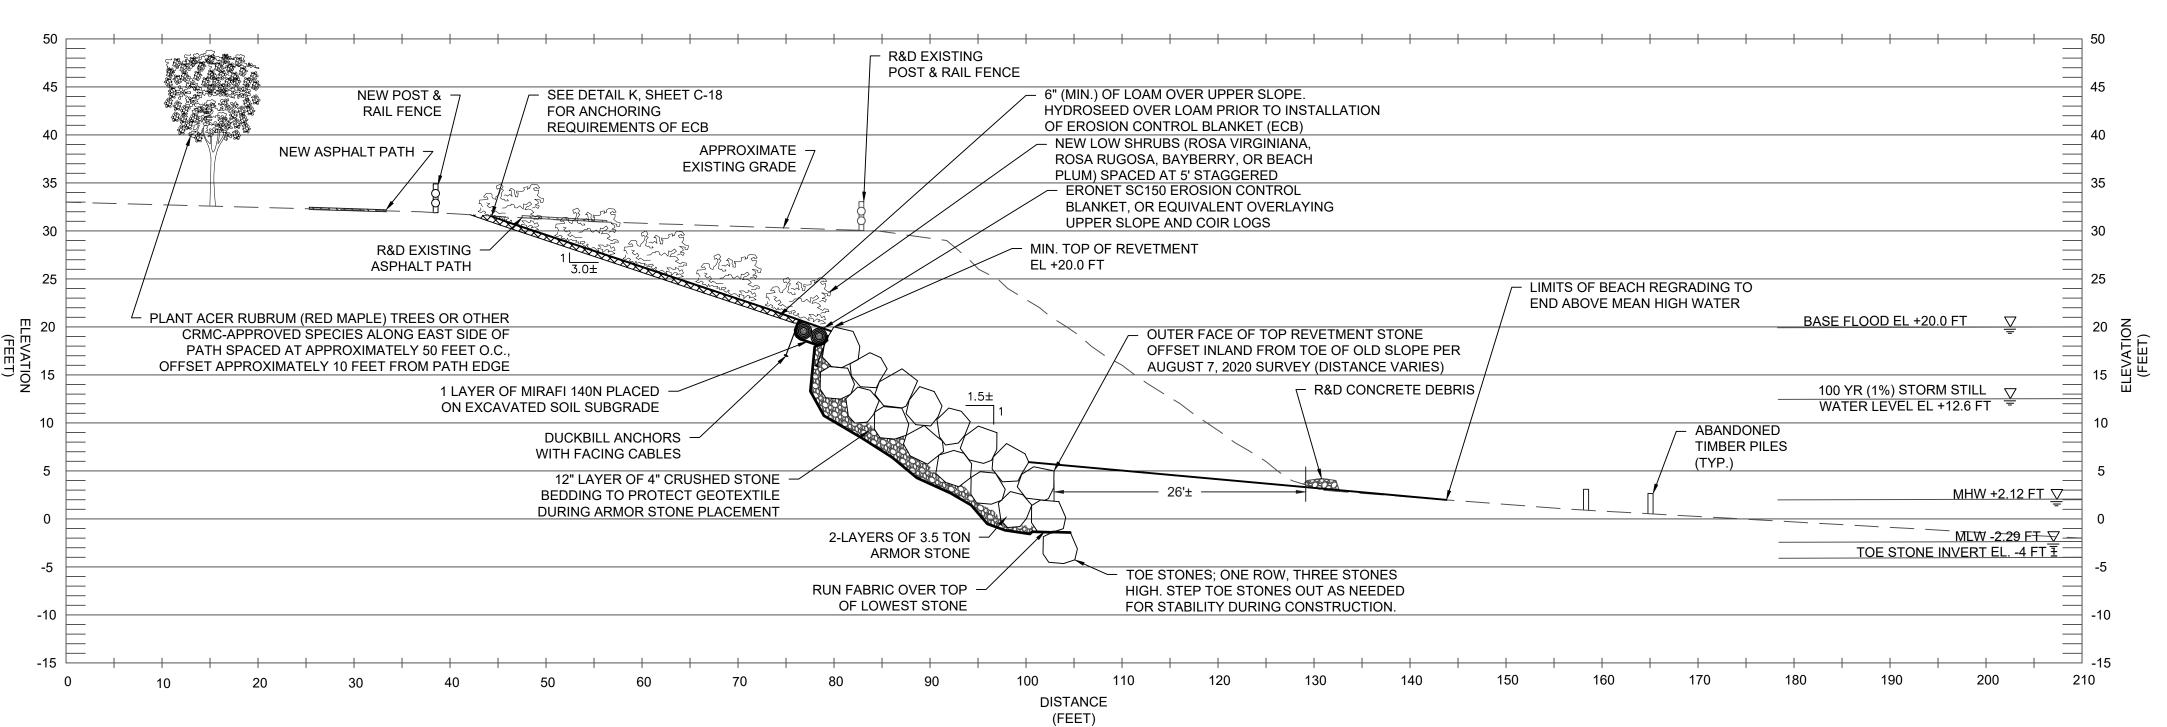
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FULL SCALE (22X34 PRINT): 1" = 10 HALF SCALE (11X17 PRINT): 1" = 20'

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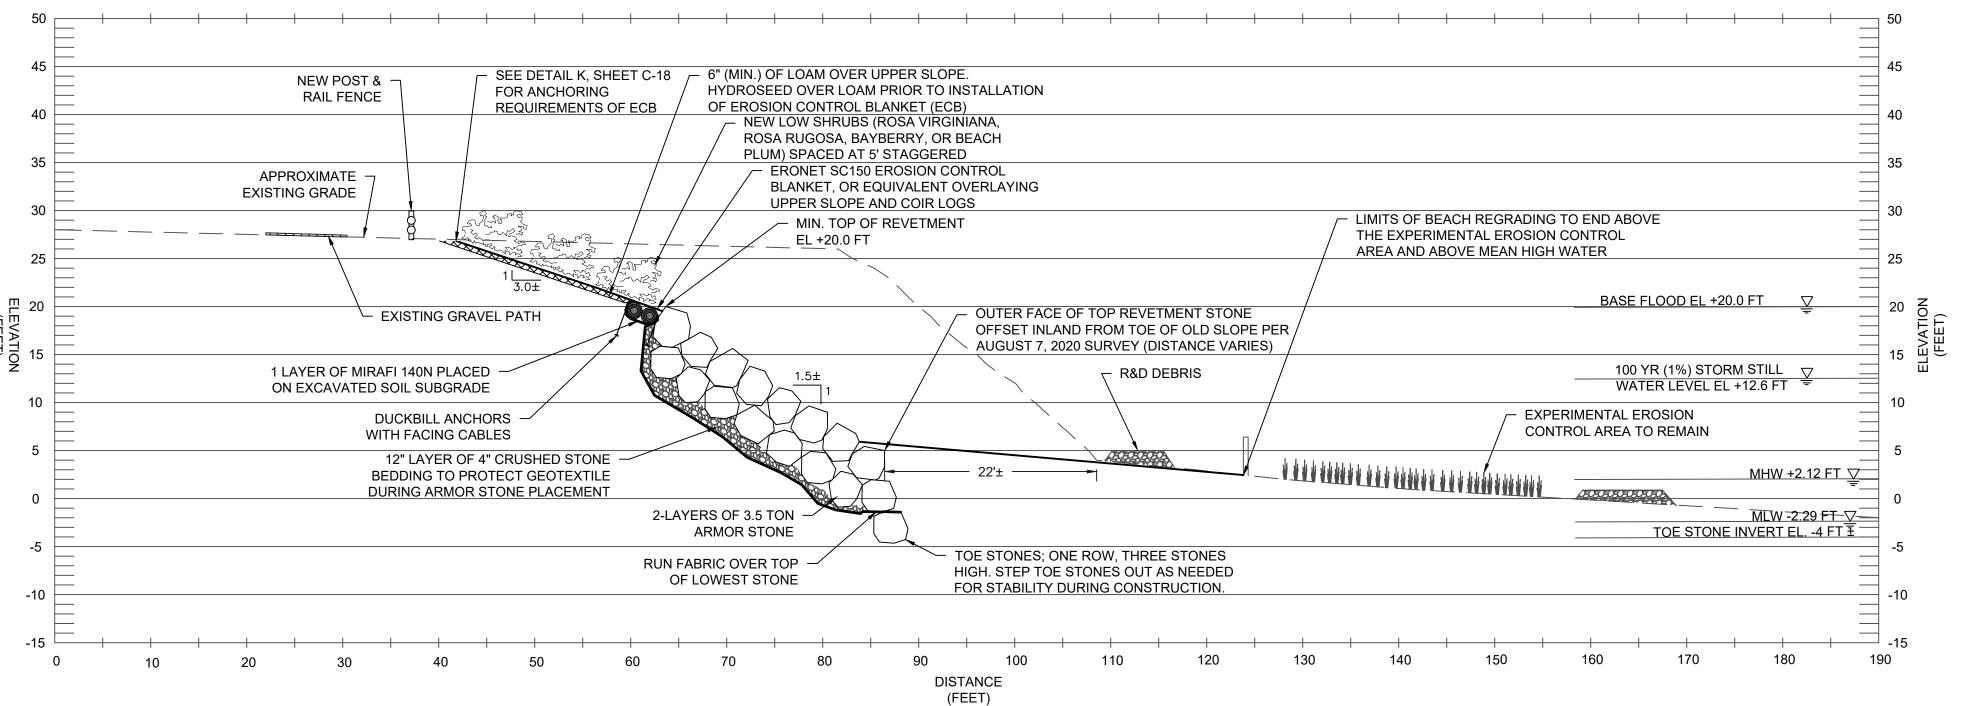
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PERMIT PLAN SET **NOT FOR** CONSTRUCTION

SEPTEMBER 27, 2024 DESIGN BY: SMR DRAWN BY: ADS / CDD CHECKED BY: SMR PROJECT NUMBER:


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SHEET 14 OF 18





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FULL SCALE (22X34 PRINT): 1" = 10 HALF SCALE (11X17 PRINT): 1" = 20'

STEPHANIE M. ROBAT ROFESSIONAL ENGINEER CIVIL 9/27/24

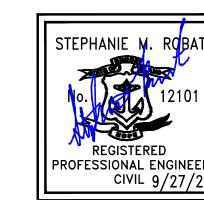SHEET 15 OF 18

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PERMIT PLAN SET

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CONSTRUCTION

SEPTEMBER 27, 2024

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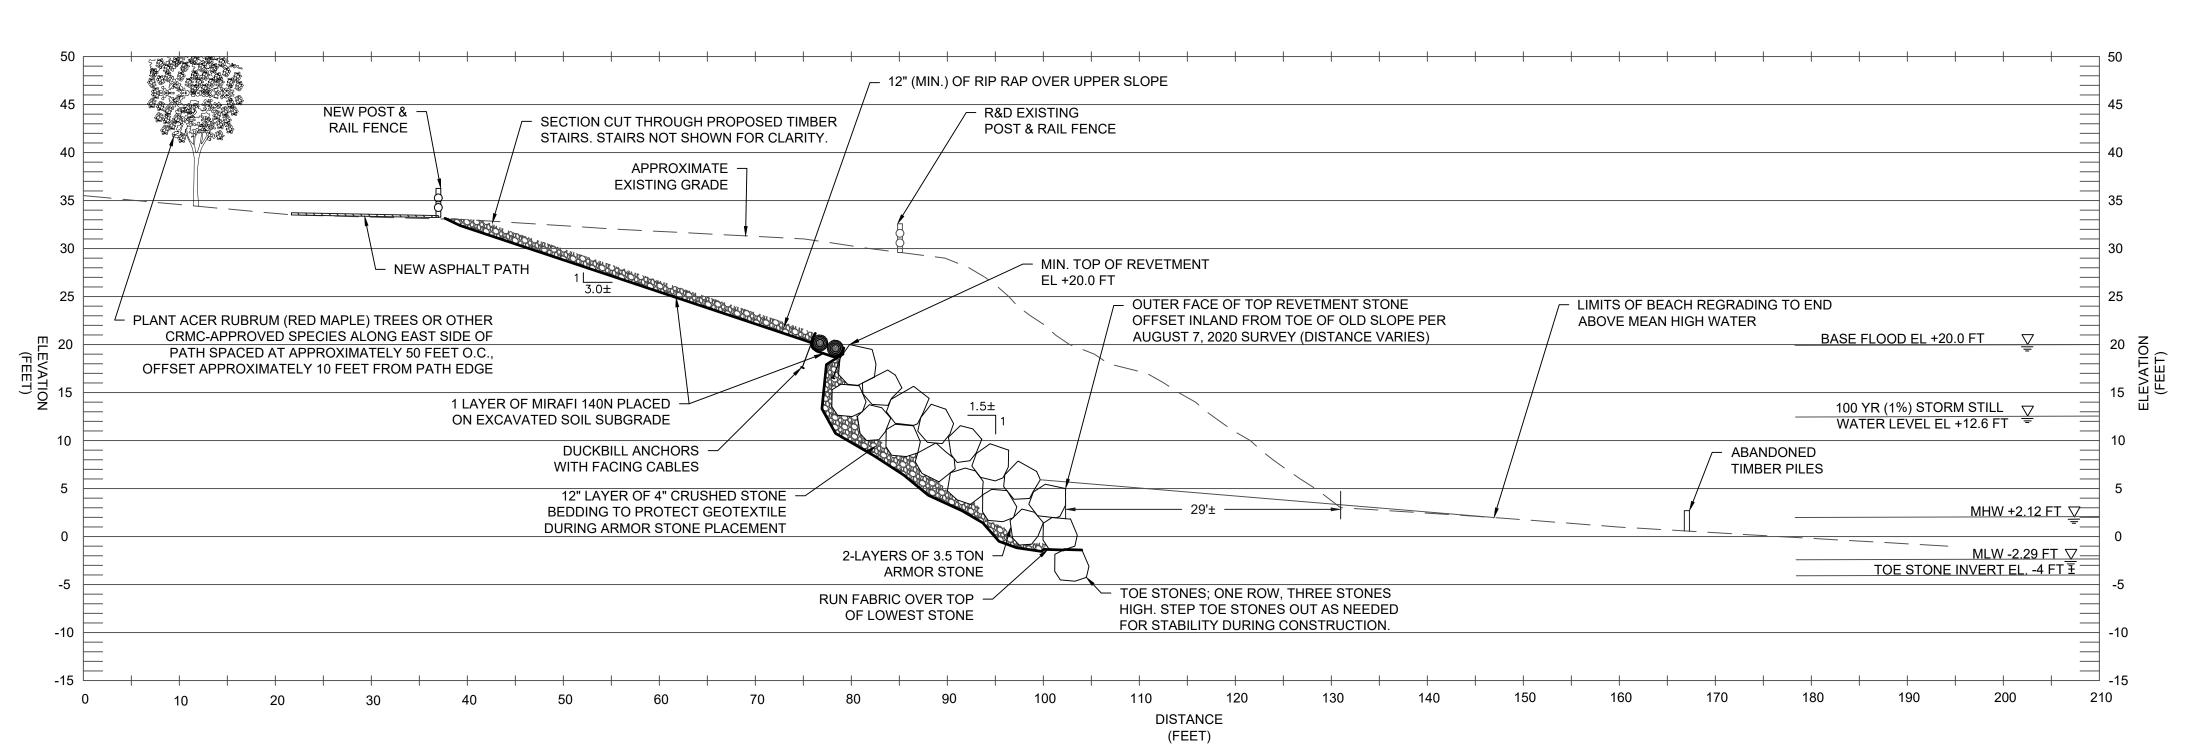
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ROSE LARISA MEMORIAI SLOPE REPAIRS & SHORELINE EAST PROVIDENCE, RHOD

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CHECKED BY: SMR PROJECT NUMBER: 22006.00

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ROSE LARISA MEMORIAI SLOPE REPAIRS & SHORELINE EAST PROVIDENCE, RHOD

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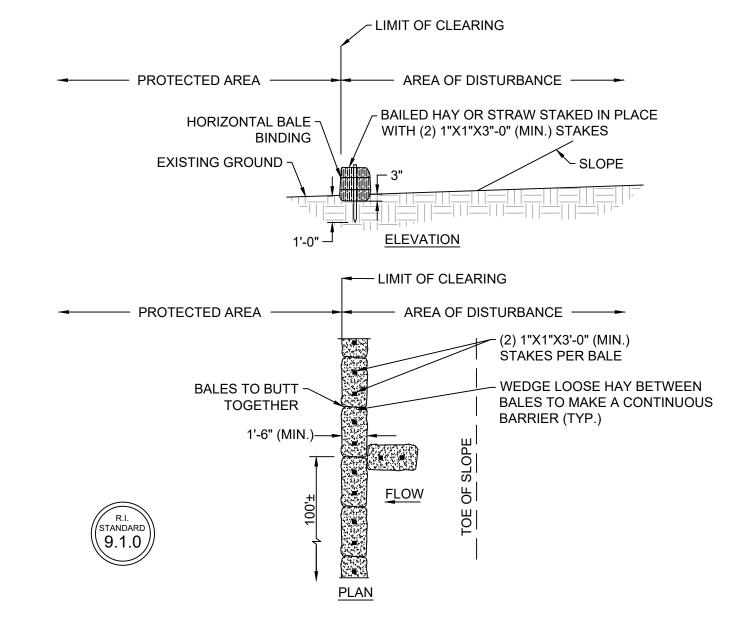
SEPTEMBER 27, 2024

DESIGN BY: SMR DRAWN BY: ADS / CDD

SHEET 16 OF 18

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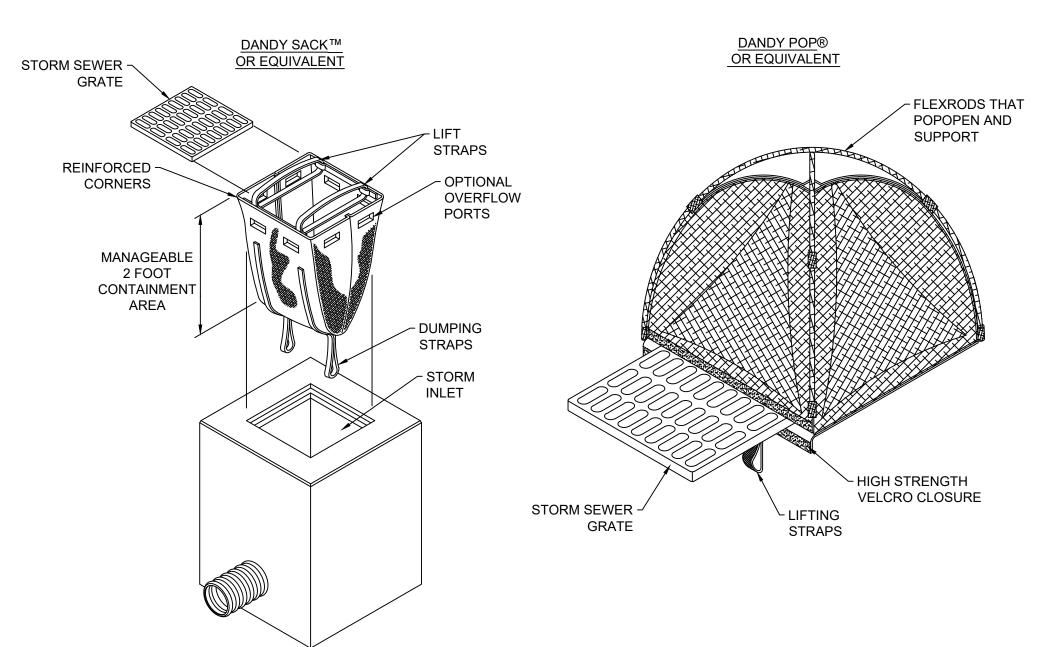
OPE S



- 1. SHALL BE IN ACCORDANCE WITH SECTION 206 OF THE RHODE ISLAND STANDARD SPECIFICATIONS.
- 2. AT APPROXIMATE 100' INTERVALS, A BALE OF HAY IS TO BUTT PERPENDICULARLY.




BALED HAY EROSION CHECK



1. SHALL BE INSTALLED AND MAINTAINED PER THE MANUFACTURER'S RECOMMENDATIONS.



CATCH BASIN SEDIMENT PROTECTION

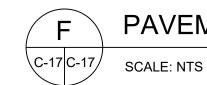

PAVEMENT

1.5" SURFACE COURSE FOR WALKING PATHS 1.5" SURFACE COURSE FOR PARKING AREAS $_{\Gamma}$ 1.5" BINDER COURSE FOR WALKING PATHS 2.5" BINDER COURSE FOR PARKING AREAS 6" BASE COURSE FOR WALKING PATHS 6" BASE COURSE FOR PARKING AREAS $_{\Gamma}$ 10" SUBBASE COURSE FOR WALKING PATHS 14" SUBBASE COURSE FOR PARKING AREAS

1. SURFACE AND BINDER COURSE SHALL CONFORM TO RIDOT BLUEBOOK M.03

BITUMINOUS PAVEMENT. 2. BASE COURSE SHALL BE GRAVEL BORROW CONFORMING TO RIDOT BLUEBOOK


M01.09, TABLE 1,I, "GRAVEL BORROW", 1A (<8 PASSING #200 SIEVE). 3. SUBBASE SHALL BE PERVIOUS FILL CONFORMING TO RIDOT BLUEBOOK M01.09,

TABLE 1, IV, "PREVIOUS FILL", TYPE D.


4. EXPOSED SUBGRADE SHALL BE PROOF ROLLED OR PROOF COMPACTED PRIOR TO PLACING SUBBASE. WEAK AREAS SHALL BE EXCAVATED AND REPLACED WITH PERVIOUS FILL COMPACTED TO A MIN. 95% OF THE MODIFIED PROCTOR DENSITY.

5. BASE AND SUBBASE COURSES SHALL BE COMPACTED TO A MIN. OF 95% OF THE MODIFIED PROCTOR DENSITY.

6. RE-STRIPE PAVEMENT WHERE NEEDED TO MATCH EXISTING CONDITIONS.

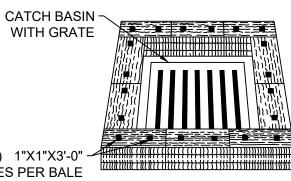


STAKES PER BALE

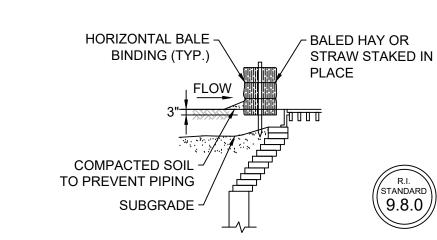


- I. SHALL BE IN ACCORDANCE WITH THE RHODE ISLAND STANDARD SPECIFICATIONS.
- 2. THIS INLET PROTECTION CAN ALSO BE USED WHEN CONSTRUCTION SEQUENCING REQUIRES A CATCH BASIN TO BE EXPOSED TO SEDIMENT FROM THE SUBGRADE. THIS WILL BE ACHIEVED BY INSTALLING THE BALED HAY AS SHOWN ON THIS DETAIL IN TO THE SUBGRADE.
- 3. THE PERIMETER CONFIGURATION OF THE BALED HAY WILL VARY DEPENDING ON THE PARTICULAR TYPE OF CATCH BASIN INLET BEING CONSTRUCTED.




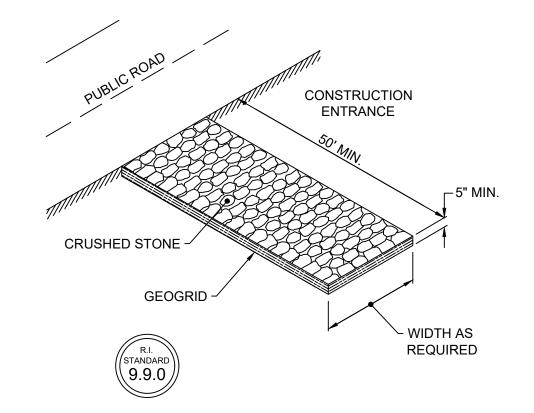


SHALL BE IN ACCORDANCE WITH SECTION 211 OF THE RHODE ISLAND STANDARD SPECIFICATIONS.



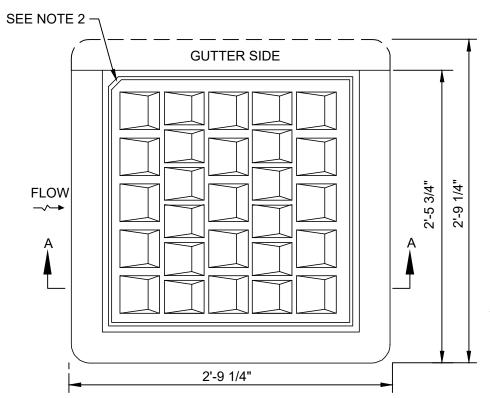

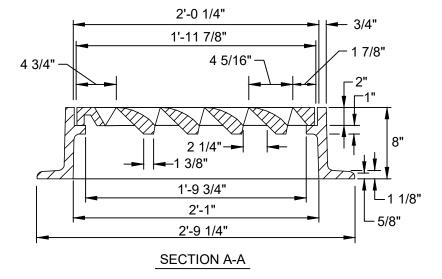


- 1. FRAME AND COVER SHALL CONFORM TO SECTION M.04 OF THE R.I. STANDARD SPECIFICATIONS.
- 2. THIS CORNER LEFT FOR "LEFT" GRATE, DIAGONALLY OPPOSITE CORNER FOR "RIGHT" GRATE TO FIT IN KEYED FRAME.

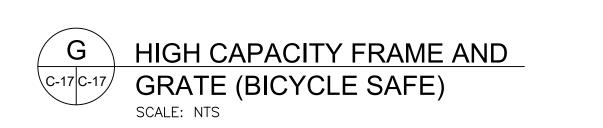



RING Z

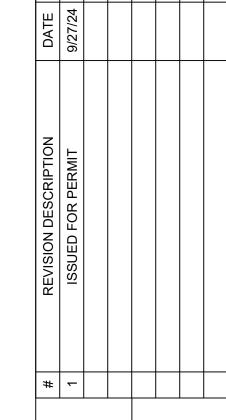

ROSE LARISA MEMORIAI OPE REPAIRS & SHORELINE EAST PROVIDENCE, RHOD **日** AL DI YPIC,

> **PERMIT PLAN** SET **NOT FOR**


DATE:

CONSTRUCTION

SEPTEMBER 27, 2024 DESIGN BY: SMR DRAWN BY: SJR / CDD CHECKED BY: SMR PROJECT NUMBER:


SHEET 17 OF 18

22006.00

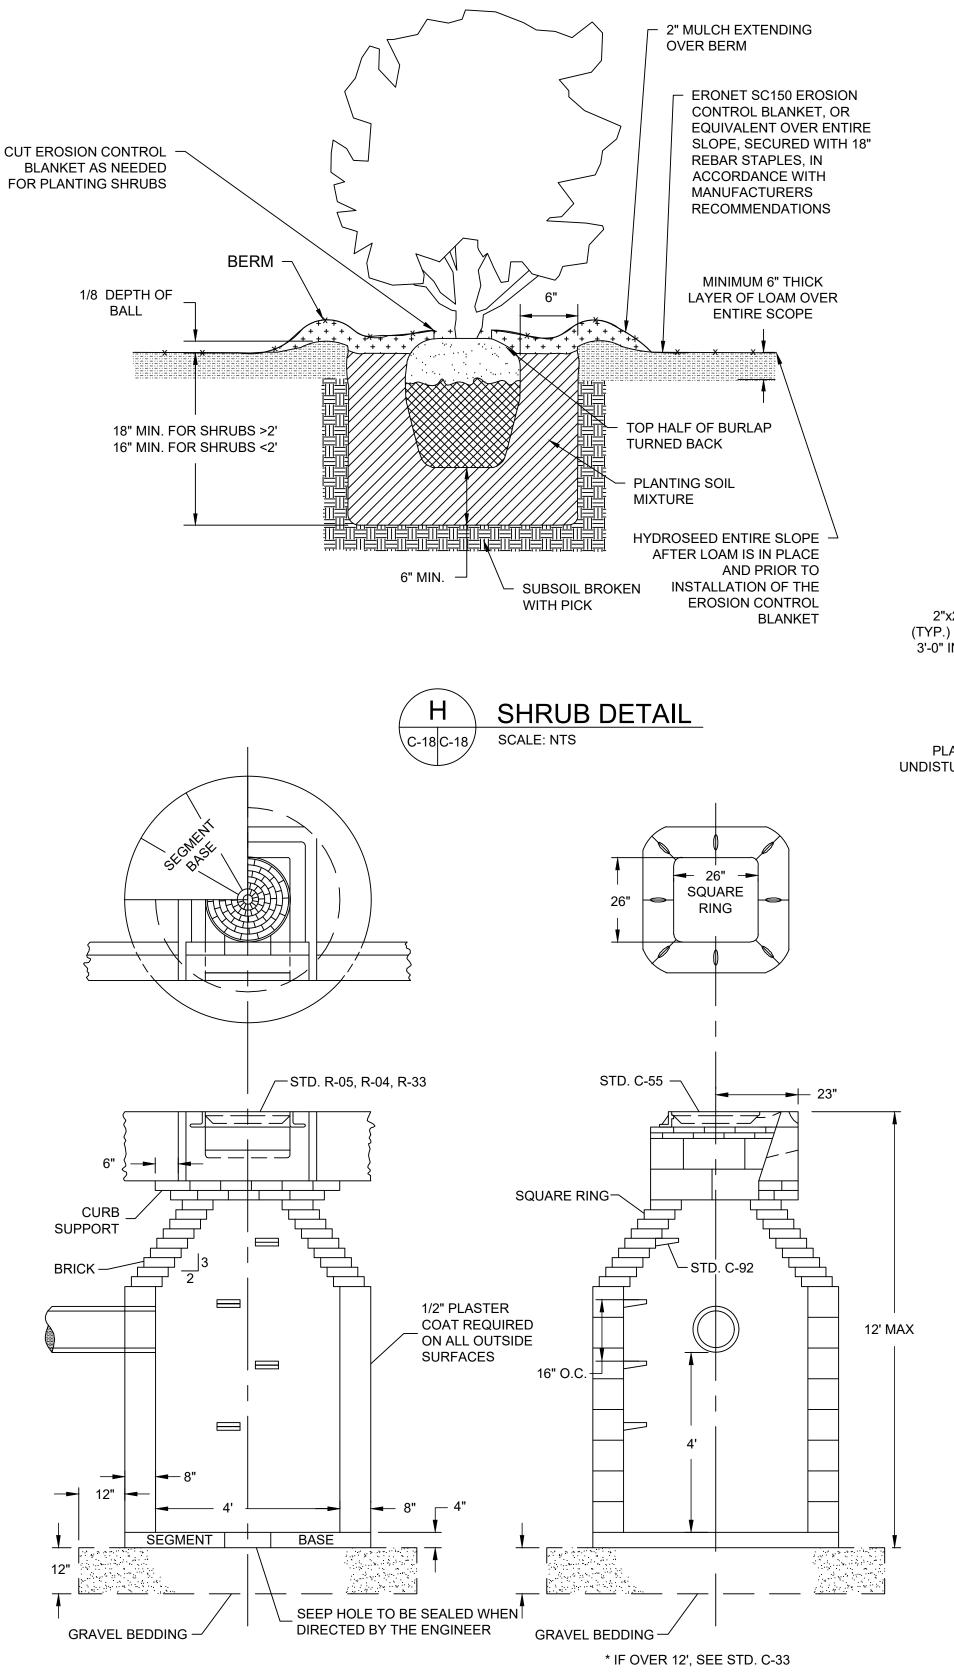


CATCH BASIN DETAIL

SCALE: NTS

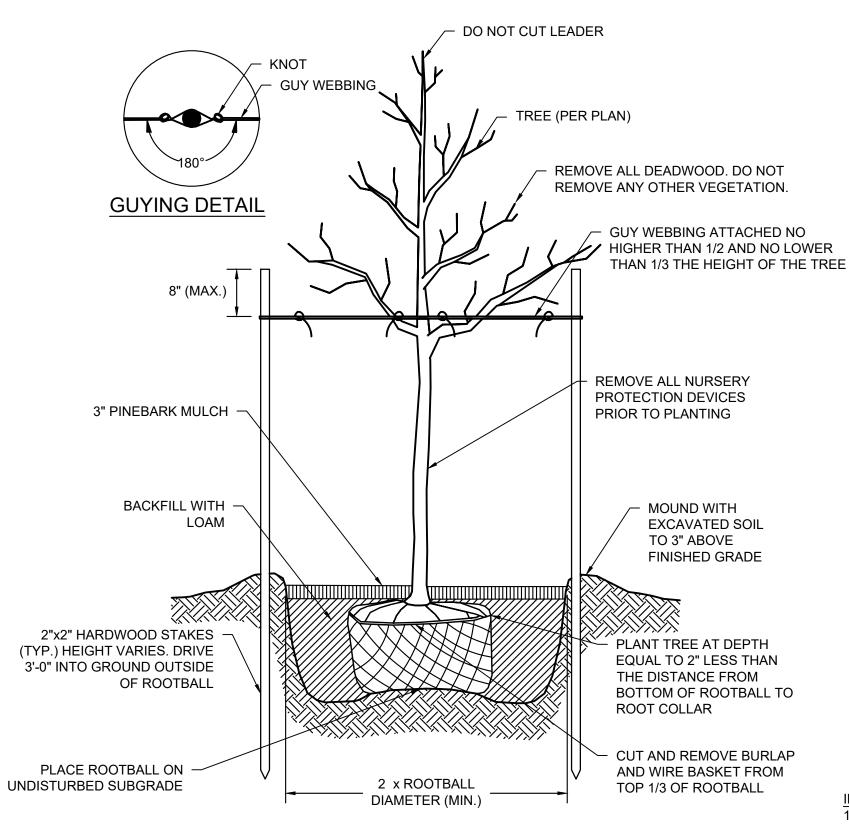




NOTE: SHALL BE IN ACCORDANCE WITH SECTION L.06 OF THE R.I. DOT STANDARD SPECIFICATIONS.

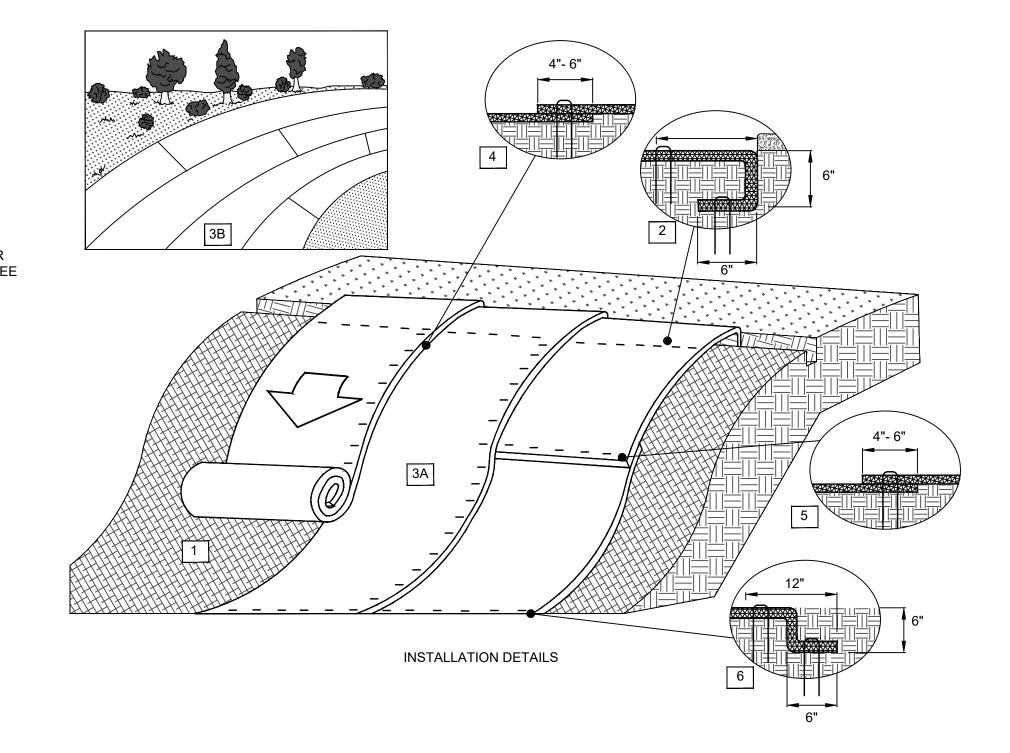

STALLATION NOTES:

1. PREPARE SOIL BEFORE INSTALLING ROLLED EROSION CONTROL PRODUCTS (RECPS), INCLUDING ANY NECESSARY APPLICATION OF LIME, FERTILIZER, AND SEED. GROUND SURFACE MUST BE FREE OF DEBRIS, ROCKS, CLAY CLODS AND RAKED SMOOTH SUFFICIENT TO ALLOW INTIMATE CONTACT OF THE RECP WITH THE SOIL OVER THE ENTIRETY OF THE INSTALLATION.

- 2. BEGIN AT THE TOP OF THE SLOPE BY ANCHORING THE RECPS IN A 6" DEEP X 6" WIDE TRENCH. ANCHOR THE RECPS WITH A ROW OF STAPLES/STAKES/PINS SPACED AT S_T APART IN THE BOTTOM OF THE TRENCH. BACKFILL AND COMPACT THE TRENCH AFTER STAPLING AND FOLD THE ROLL OVER, DOWNSLOPE. SECURE RECPS OVER COMPACTED SOIL WITH A ROW OF STAPLES/ STAKES/PINS SPACED AT S_T APART ACROSS THE WIDTH OF THE RECPS.
- 3. ROLL THE RECPS (A) DOWN OR (B) HORIZONTALLY ACROSS THE SLOPE. RECPS WILL UNROLL WITH APPROPRIATE SIDE AGAINST THE SOIL SURFACE. ALL RECPS MUST BE SECURELY FASTENED TO SOIL SURFACE BY PLACING STAPLES/ STAKES/PINS IN APPROPRIATE LOCATIONS AS SHOWN IN THE STAPLE PATTERN GUIDE. ROLLMAX RECPS AND ECBS SHOULD UTILIZE STAPLE PATTERN SHOWN IN ACCOMPANYING TABLE.
- 4. THE EDGES OF PARALLEL RECPS MUST BE STAPLED WITH APPROXIMATELY 4" 6" OVERLAP.
- 5. CONSECUTIVE RECPS SPLICED DOWN THE SLOPE MUST OVERLAPPED WITH THE UPSTREAM MAT ATOP THE DOWNSTREAM MAT (SHINGLE STYLE). THE OVERLAP SHOULD BE 4" 6".
- 6. AT THE TERMINAL END, SECURE EACH MAT ACROSS THE WIDTH WITH A ROW OF STAPLES/STAKES/PINS SPACED AT S_{T} . IF EXPOSED TO FLOW, FOOT TRAFFIC, WIND UPLIFT OR OTHER DISRUPTION, TRENCH THE TERMINAL END IN AS SHOWN IN DETAIL.
- 7. FASTENERS SHOULD PROVIDE A MINIMUM OF TWENTY POUNDS OF PULLOUT RESISTANCE.

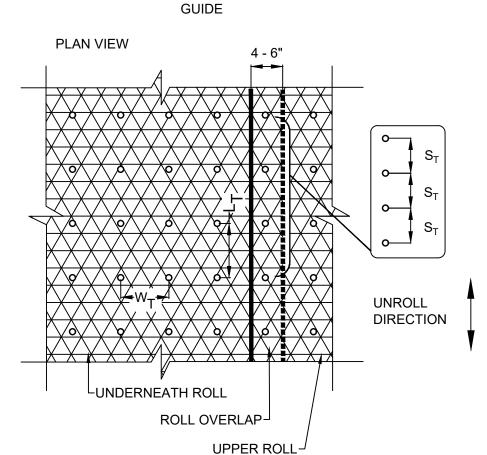

STAPLE PATTERN

o PIN / STAPLE / TWIST PIN, AS APPROPRIATE FOR FIELD CONDITIONS

DIMENSION	MEASUREMENT
W_{T}	30"
L _T	30"
S _T	18"
NOMINAL FREQUENCY	1.7 / SY
APPLICATION	ECB (DEGRADABLE)





FENGINEERING

GROUP

2346 Post Road, Suite 202

401-575-1569

REVISION DESCRIPTION DATE BY
1 ISSUED FOR PERMIT 9/27/24 SMR

ROSE LARISA MEMORIAL PARK
LOPE REPAIRS & SHORELINE PROTECT
EAST PROVIDENCE, RHODE ISLAND
TYPICAL DETAILS
2 OF 2

PERMIT PLAN SET NOT FOR

DATE:

SEPTEMBER 27, 2024

DESIGN BY: SMR

DRAWN BY: SJR / CDD

CHECKED BY: SMR

PROJECT NUMBER:

C-18
SHEET 18 OF 18

22006.00