CHASE MARINA

169 RIVERSIDE DRIVE TIVERTON, RHODE ISLAND

PERMITTING


OCTOBER, 2025

PREPARED FOR:




RHODE ISLAND DEPARTMENT
OF ENVIRONMENTAL MANAGEMENT
301 GREAT ISLAND ROAD
NARRAGANSETT RHODE ISLAND

DESIGNED BY:

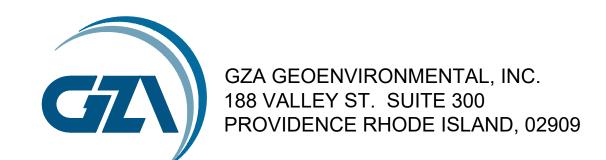



PROJECT LOCUS MAP

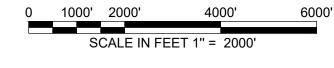


SOURCE: USGSSTORE.GOV

BASE MAP FROM THE FOLLOWING USGS QUADRANGLE MAP:


TIVERTON, RHODE ISLAND (2021), FALL RIVER, MASSACHUSETTS (2021)

DIGITAL TOPOGRAPHIC MAPS PROVIDED BY USGSSTORE.GOV.

CONTOUR ELEVATIONS REFERENCE NAVD 88,
CONTOURS ARE SHOWN IN FEET AT 10 FOOT INTERVALS

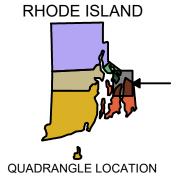

PROJECT VICINITY MAP

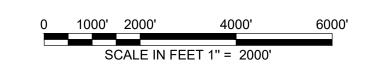

BASE MAP DEVELOPED FROM RIGIS AERIAL IMAGERY PUBLISHED IN APRIL 2019.

INDEX OF DRA

SHEET TITLI


- COVER SHEET AND INDEX OF DRAWINGS
 GENERAL NOTES
- GENERAL NOTE:
- EXISTING CONDITIONS PLAN
- TEMPORARY CONTROLS PLAN PHASE I
- TEMPORARY CONTROLS DETAILS
- 7 DEMOLITION PLAN
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- PROPOSED TIMBER DETAILS PHASE I
- 12 PROPOSED GANGWAY-DOCK DETAILS PHASE I
 13 PROPOSED BULKHEAD-OUTFALL DETAILS PHASE I
- PROPOSED CONDITIONS AND FINAL CONDITIONS
- PLAN PHASE II
- 5 PROPOSED CONDITIONS SECTIONS PHASE II

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10-22-2025

COASTAL RESOURCES
MANAGEMENT COUNCIL

MATTHEW J. PAGE

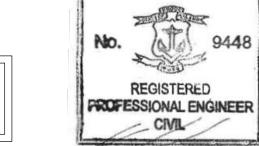

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- 1. BASE MAP DEVELOPED FROM ELECTRONIC DRAWING FILE 8630A TOPO SHIPPED 2024-09-16, PREPARED BY DOUCET SURVEY AND TRANSMITTED TO GZA ON SEPTEMBER 16, 2024...
- 2. BATHYMETRIC SURVEY PERFORMED BY GZA IN SEPTEMBER, 2024...
- LOCATION OF OVERHEAD BRIDGE APPROXIMATED USING GOOGLE EARTH IMAGERY.

GENERAL NOTES

- 1. LOCATIONS OF UNDERGROUND UTILITIES ARE APPROXIMATE ONLY, AND ARE NOT WARRANTED TO BE CORRECT. ADDITIONAL UTILITIES MAY EXIST WHICH ARE NOT INDICATED ON THESE PLANS. ALL EXISTING UTILITIES SHALL BE VERIFIED FOR SERVICE, SIZE, INVERT ELEVATION, LOCATION, ETC. PRIOR TO ANY CONSTRUCTION WORK IN THE VICINITY THEREOF. THE CONTRACTOR MUST NOTIFY DIGSAFE (PHONE NUMBER: 811) AT LEAST 3 FULL WORKING DAYS PRIOR TO ANY CONSTRUCTION. APPROPRIATE MUNICIPAL DEPARTMENTS MUST ALSO BE NOTIFIED. NOTIFY OWNER AND ENGINEER IN WRITING OF ANY AND ALL DISCREPANCIES PRIOR TO COMMENCING WORK.
- 2. THE CONTRACTOR SHALL BE RESPONSIBLE FOR FINDING, VERIFYING, AND RE-SETTING (IF NECESSARY) CONTROL POINTS AND BENCHMARKS FOR THE WORK OF THE CONTRACT OR OTHERWISE ESTABLISHING
- 3. THE RESPONSIBILITY FOR SAFETY IN, ON, OR ABOUT THE JOBSITE SHALL BE THAT OF THE CONSTRUCTION CONTRACTOR. THESE DRAWINGS DO NOT INCLUDE COMPONENTS WHICH MAY BE NECESSARY FOR CONSTRUCTION SAFETY.
- 4. THE CONTRACTOR SHALL BE RESPONSIBLE FOR THE MEANS AND METHODS OF CONSTRUCTION, EXCEPT WHERE SPECIFICALLY DETAILED IN THE PLANS. LIKEWISE, THE CONTRACTOR SHALL BE RESPONSIBLE FOR THE SEQUENCE OF THE WORK, EXCEPT WHERE SPECIFICALLY DETAILED IN THE PLANS.
- 5. THE CONTRACTOR SHALL BE RESPONSIBLE FOR ALL SURFACE AND GROUNDWATER CONTROL DURING THE WORK OF THE CONTRACT. TEMPORARY WATER CONTROL MEASURES SHALL BE, AT MINIMUM, AS REQUIRED BY THE PROJECT PLANS, SPECIFICATIONS, AND PERMIT CONDITIONS. THE CONTRACTOR SHALL BE RESPONSIBLE FOR ALL ADDITIONAL MEASURES NECESSARY FOR WATER CONTROL NECESSARY TO EXECUTE THE WORK OF THE CONTRACT "IN THE DRY". WATER CONTROL MEASURES ARE SUBJECT TO SPECIFIC LIMITS AND CONDITIONS AS MAY BE SHOWN ON THE PLANS.
- 6. ACCESS TO THE SITE SHALL BE FROM RIVERSIDE DRIVE. THE CONTRACTOR SHALL RESTORE ALL AREAS DISTURBED BY CONSTRUCTION AS PER THE PLANS AND SPECIFICATIONS. WHERE NO SPECIFIC INSTRUCTION IS GIVEN, RESTORATION SHALL BE TO THE ORIGINAL CONDITION OR BETTER AND AT NO ADDITIONAL COST TO THE OWNER. THE CONTRACTOR IS SPECIFICALLY INFORMED THAT THE RESTORATION REQUIREMENT APPLIES TO ALL AREAS DISTURBED AS A RESULT OF THE PROJECT, INCLUDING ACCESS ROADS.
- 7. CONTRACTOR STAGING AREAS SHALL BE WITHIN LIMITS OF WORK AS DELINEATED ON THE PLANS. THE CONTRACTOR SHALL USE THESE AREAS AND THESE AREAS ONLY FOR ON-SITE PARKING, OFFICE TRAILERS (IF NECESSARY), EQUIPMENT AND MATERIAL STORAGE, ETC. THE CONTRACTOR SHALL BE RESPONSIBLE FOR ANY NECESSARY SIGNAGE, FENCING, SAFETY, SEDIMENT/EROSION CONTROL, IMPROVEMENTS, RESTORATIONS, ETC. IN THESE AREAS. AREAS WITHIN THE LIMITS OF THE WORK MAY BE USED FOR TEMPORARY STORAGE, HAUL ROADS, PARKING, ETC.; HOWEVER, NO ADDITIONAL CONSIDERATIONS OR PAYMENT WILL BE MADE FOR WORK NECESSARY TO RE-GRADE AND RESTORE SUCH AREAS TO PRE-CONSTRUCTION CONDITIONS OR RELOCATE ANY MATERIALS OR EQUIPMENT TEMPORARILY STORED WITHIN THE LIMITS OF THE WORK. IF THE CONTRACTOR REQUIRES AND IDENTIFIES ADDITIONAL STAGING AREAS ON THE OWNER'S PROPERTY, THE CONTRACTOR SHALL MAKE A WRITTEN REQUEST TO THE OWNER AND ENGINEER DESCRIBING THE NEED AND LOCATION OF THE PROPOSED AREA. NO GUARANTEE IS MADE THAT ADDITIONAL STAGING AREAS WILL BE MADE AVAILABLE.
- 8. PRIOR TO THE START OF WORK, THE CONTRACTOR SHALL DEVELOP, SUBMIT, AND MAINTAIN AN EMERGENCY CONTACT LIST WITH NAMES AND PHONE NUMBERS (DAY AND NIGHT) OF ALL KEY PERSONNEL INVOLVED WITH THE PROJECT. THE LIST SHALL SPECIFICALLY INCLUDE THE PERSON FROM THE CONTRACTOR WHO SHALL BE RESPONSIBLE FOR ENVIRONMENTAL COMPLIANCE. THE LIST SHALL BE PROVIDED TO THE OWNER, ENGINEER, AND RIDEM AND UPDATED AS NEEDED.
- 9. THE CONTRACTOR IS RESPONSIBLE FOR ALL PENALTIES AND DELAYS DUE TO NON-COMPLIANCE WITH PERMIT CONDITIONS.
- 10. THE CONTRACTOR SHALL VERIFY ALL DIMENSIONS IN THE FIELD.

EROSION AND SEDIMENTATION CONTROL

- TEMPORARY CONTROL OF EROSION AND SEDIMENT DISCHARGE IS REQUIRED THROUGHOUT THE DURATION OF THE PROJECT AND UNTIL PROPOSED STABILIZATION IS ACHIEVED. IT IS THE CONTRACTOR'S RESPONSIBILITY TO PROTECT THE AREAS WITHIN THE LIMITS OF WORK AND BEYOND FROM SEDIMENT AND/OR POLLUTANTS ORIGINATING FROM ANY WORK DONE ON OR IN SUPPORT OF THE PROJECT, INCLUDING SEDIMENT DUE TO EROSION FROM STORMWATER RUNOFF.
- 2. THE CONTRACTOR SHALL BE RESPONSIBLE FOR IMPLEMENTING ALL TEMPORARY SEDIMENT AND EROSION CONTROL MEASURES NECESSARY TO EXECUTE AND COMPLETE THE WORK OF THE CONTRACT, IN COMPLIANCE WITH THE TERMS AND CONDITIONS CONTAINED IN THE CONTRACT, PROJECT PERMITS AND ALL STATE AND LOCAL ORDINANCES THAT APPLY. CONTROLS SHOWN ON THE CONTRACT DRAWINGS SHALL BE CONSIDERED MINIMUM REQUIREMENTS. THE CONTRACTOR SHALL EMPLOY WHATEVER SUPPLEMENTARY MEASURES NECESSARY TO PROTECT WATER, AND ADJACENT AREAS FROM DISTURBANCE OR DISCHARGE OF SEDIMENTS.
- 3. ALL NECESSARY PRECAUTIONS SHALL BE TAKEN TO PREVENT MIGRATION INTO WATER BY SILT, SEDIMENT, FUELS, SOLVENTS, LUBRICANTS, CONCRETE, OR ANY OTHER POLLUTANTS ASSOCIATED WITH CONSTRUCTION PROCEDURES.
- 4. ACTUAL LOCATION OF EROSION CONTROLS AND BEST MANAGEMENT PRACTICES (BMP) MAY VARY DUE TO FIELD CHANGES, ONGOING CONSTRUCTION, ACCESS NEEDS, WEATHER, ETC. THE CONTRACTOR SHALL BE RESPONSIBLE FOR IDENTIFYING THESE CHANGES AND ADJUSTING EROSION CONTROLS AND BMP LOCATIONS ACCORDINGLY. IN PARTICULAR, THE CONTRACTOR SHALL COORDINATE THE INSTALLATION AND RELOCATION OF BMPS WITH PROJECT PHASING, AS NECESSARY.
- 5. ALL EROSION CONTROLS AND BMPS SHALL REMAIN IN PLACE, EXCEPT AS OTHERWISE NECESSARY, UNTIL CONSTRUCTION IS COMPLETED AND PROPOSED STABILIZATION IS ACHIEVED. ALL CONTROLS AND BMPS SHALL BE SUBJECT TO INSPECTION BY THE OWNER AND THEIR REPRESENTATIVE AT ANYTIME
- 6. ADDITIONAL EROSION CONTROL BARRIERS SHALL BE INSTALLED AT THE DIRECTION OF THE ENGINEER TO MINIMIZE THE THREAT OF ADVERSE IMPACT DURING THE CONSTRUCTION PROCESS. AN ADEQUATE SUPPLY OF REPLACEMENT EROSION CONTROL BARRIERS WILL BE AVAILABLE ON-SITE FOR EMERGENCY PURPOSES.
- 7. PERIODIC INSPECTION, MAINTENANCE, AND CLEANING OF TEMPORARY EROSION AND SEDIMENT CONTROL MEASURES AND BMPS ARE REQUIRED. ALL CONTROLS AND BMPS SHALL BE INSPECTED EVERY 7 DAYS AND WITHIN 24 HOURS OF RAINFALL EVENTS OF 0.5 INCHES OR GREATER. ROUTINE INSPECTION AND MAINTENANCE WILL REDUCE THE CHANCE OF POLLUTING STORMWATER BY FINDING AND CORRECTING PROBLEMS BEFORE THE NEXT RAIN EVENT. THE CONTRACTOR WILL BE REQUIRED TO KEEP
- CONTRACTOR SHALL PROVIDE AND MAINTAIN TURBIDITY CURTAINS AND IS RESPONSIBLE FOR DETERMINING LAYOUT AND INSTALLATION PROCEDURES IN ACCORDANCE WITH CONTRACT DOCUMENTS.

A WRITTEN, UPDATED SITE MAINTENANCE LOG DOCUMENTING INSPECTION AND MAINTENANCE ACTIVITY.

9. TURBIDITY CURTAINS SHALL BE INSTALLED TO SURROUND THE LIMIT OF WORK, AS NEEDED, INCLUDING BUT NOT LIMITED TO DEMOLITION AND WALL CONSTRUCTION

WATER CONTROL NOTES

- 1. TEMPORARY WATER CONTROL BY THE CONTRACTOR SHALL BE PERFORMED AS SPECIFIED IN THE CONTRACT DOCUMENTS.
- 2. THE CONTRACTOR SHALL BE RESPONSIBLE FOR ALL TEMPORARY WATER CONTROL, SURFACE WATER AND GROUNDWATER CONTROL, NECESSARY TO EXECUTE AND COMPLETE THE WORK OF THE CONTRACT SUBJECT TO THE RESTRICTIONS CONTAINED IN THE CONTRACT AND PROJECT PERMITS. CONTROLS SHOWN IN THE CONTRACT DRAWINGS SHALL BE CONSIDERED MINIMUM REQUIREMENTS. THE CONTRACTOR SHALL EMPLOY WHATEVER SUPPLEMENTARY MEASURES NECESSARY TO PROTECT THE
- 3. ALL TEMPORARY WATER CONTROL MEASURES SHALL BE IMPLEMENTED IN CONJUNCTION WITH APPROPRIATE SEDIMENT AND EROSION CONTROL MEASURES SO AS TO MINIMIZE TO THE GREATEST EXTENT POSSIBLE RELEASE OF SEDIMENT INTO WATER BODIES AND POTENTIAL EROSION OF SOIL.
- 4. ANY TEMPORARY PUMPS USED AT THE SITE MUST BE PROPERLY BAFFLED AGAINST EXCESSIVE NOISE. PUMPS OR GENERATORS WHICH USE LIQUID FUEL MUST BE PLACED WITHIN AN IMPERMEABLE SECONDARY CONTAINMENT AREA WITH SUFFICIENT CAPACITY TO CONTAIN THE FULL VOLUME OF THE
- 5. WATER PUMPED FROM THE EXCAVATIONS MUST BE PASSED THROUGH A PUMPED WATER FILTER BAG OR OTHER SUCH BEST MANAGEMENT PRACTICE FEATURE PRIOR TO BEING DISCHARGED BACK TO A WATER BODY. DISCHARGE WATER SHALL MEET APPROPRIATE WATER QUALITY STANDARDS.
- 6. PUMPED WATER DISCHARGE AREAS MUST BE PROPERLY PROTECTED TO PREVENT EROSION BY HIGH VELOCITY FLOW.

CONSTRUCTION NOTES:

1. THE CONTRACTOR AND/OR SUBCONTRACTORS MUST SHOW EVIDENCE OF PRIOR EXPERIENCE AND SUCCESSFUL COMPLETION OF THE TYPE OF REPAIR WORK INDICATED.

LAYOUT NOTES:

- 1. ALL LINES ARE PERPENDICULAR OR PARALLEL TO THE LINES FROM WHICH THEY ARE MEASURED UNLESS
- 2. WALL LAYOUTS SHALL BE FIELD ADJUSTED TO PROVIDE THE MINIMUM WALKWAY OR GROUND FEATURE DIMENSIONS AS SHOWN ON THE PLANS.

LOAM AND SEED NOTES:

- 1. CONTRACTOR SHALL APPLY FERTILIZER AND LOAM TO PREPARE TOPSOIL SURFACE IN ACCORDANCE WITH THE MANUFACTURER'S RECOMMENDATIONS.
- 2. CONTRACTOR SHALL SEED ENTIRE DISTURBED AREA AS INDICATED IN THE PROJECT DOCUMENTS.
- 3. CONTRACTOR SHALL MULCH ENTIRE SEEDED AREA WITH STRAW MULCH TO HEP DEVELOP AN ACCEPTABLE STAND OF GRASS.
- 4. CONTRACTOR SHALL BE RESPONSIBLE FOR MAINTAINING THE SEEDED AREA THROUGH ONE GROWING SEASON, MAINTENANCE INCLUDES MOWING, WATERING, AND RE-SEEDING AS REQUIRED TO DEVELOP A SATISFACTORY STAND OF HEALTHY GRASS.

DEMOLITION NOTES:

- 1. EXCAVATED MATERIALS SUSPECTED OF CONTAMINATION SHALL BE SEPARATED, AND WRAPPED IN POLYTHENE SHEETING STOCKPILED ON-SITE FOR EVALUATION BY THE ENGINEER.
- 2. CONTRACTOR SHALL EXERCISE EXTREME CAUTION TO AVOID DAMAGE TO ANY EXISTING UTILITIES AND STRUCTURES TO REMAIN IN PLACE DURING CONSTRUCTION AND/OR AFTER CONSTRUCTION IS COMPLETE.
- 3. ALL MATERIALS REMOVED AND NOT SPECIFIED TO BE SALVAGED OR REUSED SHALL BECOME THE PROPERTY OF THE CONTRACTOR AND LEGALLY DISPOSED OF OFF-SITE.

MATERIAL NOTES:

1. MATERIAL AND PRODUCT REQUIREMENTS, WHERE REFERENCED AS RIDOT, THE REQUIREMENT REFERS TO THE RHODE ISLAND DEPARTMENT OF TRANSPORTATION STANDARD SPECIFICATIONS FOR ROAD AND BRIDGE DESIGN "BLUE BOOK". LATEST EDITION.

GRAVEL BORROW: M.01.02.1

CRUSHED STONE: M.01.06

COMMON FILL: M.01.01

LOAM: L.01.01.1 / M.18.01

FILTER FABRIC: NON-WOVEN FABRIC, INERT TO UV LIGHT, EQUAL IN PROPERTIES TO MIRAFI 180N OR APPROVED EQUAL

2. REINFORCING SHALL HAVE A MINIMUM OF 2 INCHES OF COVER WHEN CONCRETE IS CAST AGAINST FORMWORK. FOR CONCRETE CAST AGAINST EARTH, THE COVER SHALL BE 3 INCHES MINIMUM.

CONCRETE NOTES:

CONCRETE - 28-DAY COMPRESSIVE STRENGTH OF 5,000 PSI MINIMUM

3/4 INCH MAXIMUM AGGREGATE SIZE AIR CONTENT OF 5.0% - 7.0%

COLD WEATHER OR HOT WEATHER REQUIREMENTS AS APPLICABLE AND AS DETERMINED BY THE ENGINEER

CEMENT - PORTLAND CEMENT, ASTMC 150, TYPE II

REINFORCING STEEL NOTES:


REINFORCING BAR: ASTM A 615, GRADE 60, GALVANIZED ASTM A 123, ASTM A 153

DOWELS: ASTM A 615, GRADE 60, GALVANIZED ASTM A 123, ASTM A 153

GROUT: TWO-COMPONENT TYPE EPOXY ADHESIVE SIKADUR 32, HI MOD OR

APPROVED EQUAL **DESIGN CRITERIA:**

- AMERICAN CONCRETE INSTITUTE, ACI 318, (LATEST EDITION)
- STEEL CONSTRUCTION MANUAL, AMERICAN INSTITUTE OF STEEL CONSTRUCTION (LATEST EDITION)
- WELDING OF STRUCTURAL AND MISCELLANEOUS STEEL STRUCTURAL WELDING CODE (LATEST EDITION) RHODE ISLAND BUILDING CODE

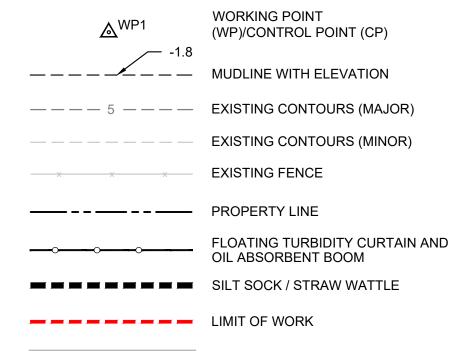

GRAVEL ROAD CONCRETE WALL

TREES


VEHICLE DIRECTION OF TRAVEL



LEGEND


TREES TO BE PROTECTED

UTILITIES LEGEND:

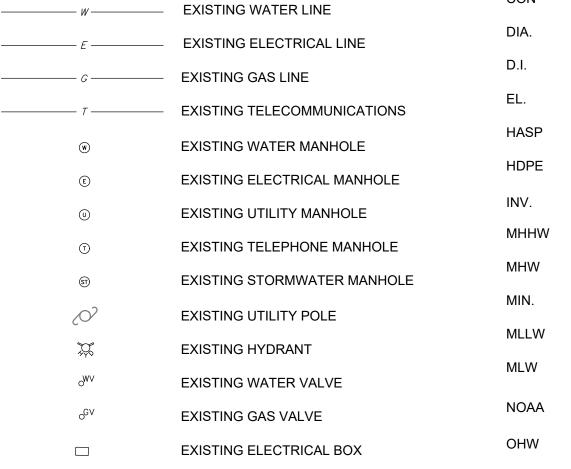



HEALTH AND SAFETY PLAN HIGH-DENSITY POLYETHYLENE MEAN HIGH, HIGH WATER MEAN LOW, LOW WATER NATIONAL OCEANIC AND ATMOSPHERIC

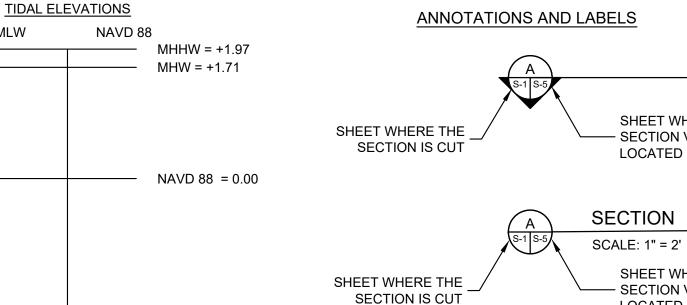


TIDAL ELEVATIONS ARE REFERENCED TO NOAA STATION 8450948, ANTHONY POINT, TIVERTON, RI.

-0.18 MLLW = -2.22

MLW = -2.07

SURVEY AND PROJECT DATUM:

- 1. ALL ELEVATIONS SHOWN ON PLANS ARE IN U.S. FEET AND REFERENCE THE NORTH AMERICAN VERTICAL DATUM OF 1988 (NAVD88).
- COORDINATES ARE BASED ON NORTH AMERICAN DATUM OF 1983 (NAD83), RHODE ISLAND STATE PLANE. EASTERN ZONE, U.S. FEET (RI83-EF).
- CONTRACTOR SHALL MAINTAIN ADEQUATE SURVEY CONTROL AT ALL TIMES TO ESTABLISH AND MAINTAIN ALL LINES AND ELEVATIONS.

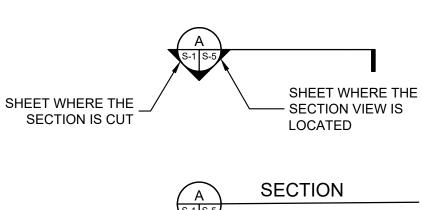



ABBREVIATIONS AND ACRONYMS


CITY OF NEWPORT

DIAMETER

DUCTILE IRON

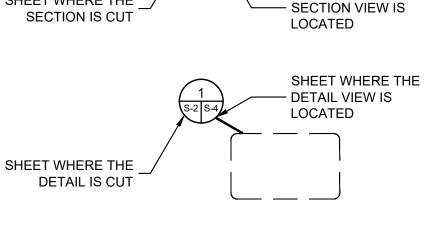

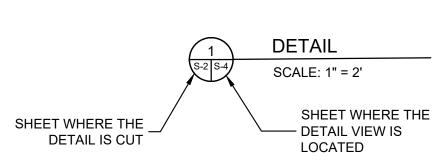

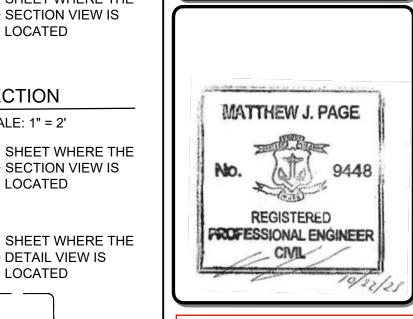

Known for excellence.


Built on trust


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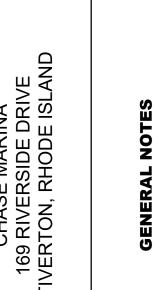
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COASTAL RESOURCE








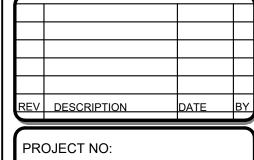

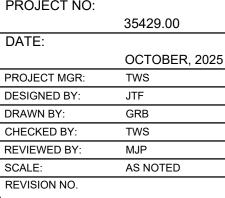DRAWING SHEET NO. 2 OF 15

APPROVED:

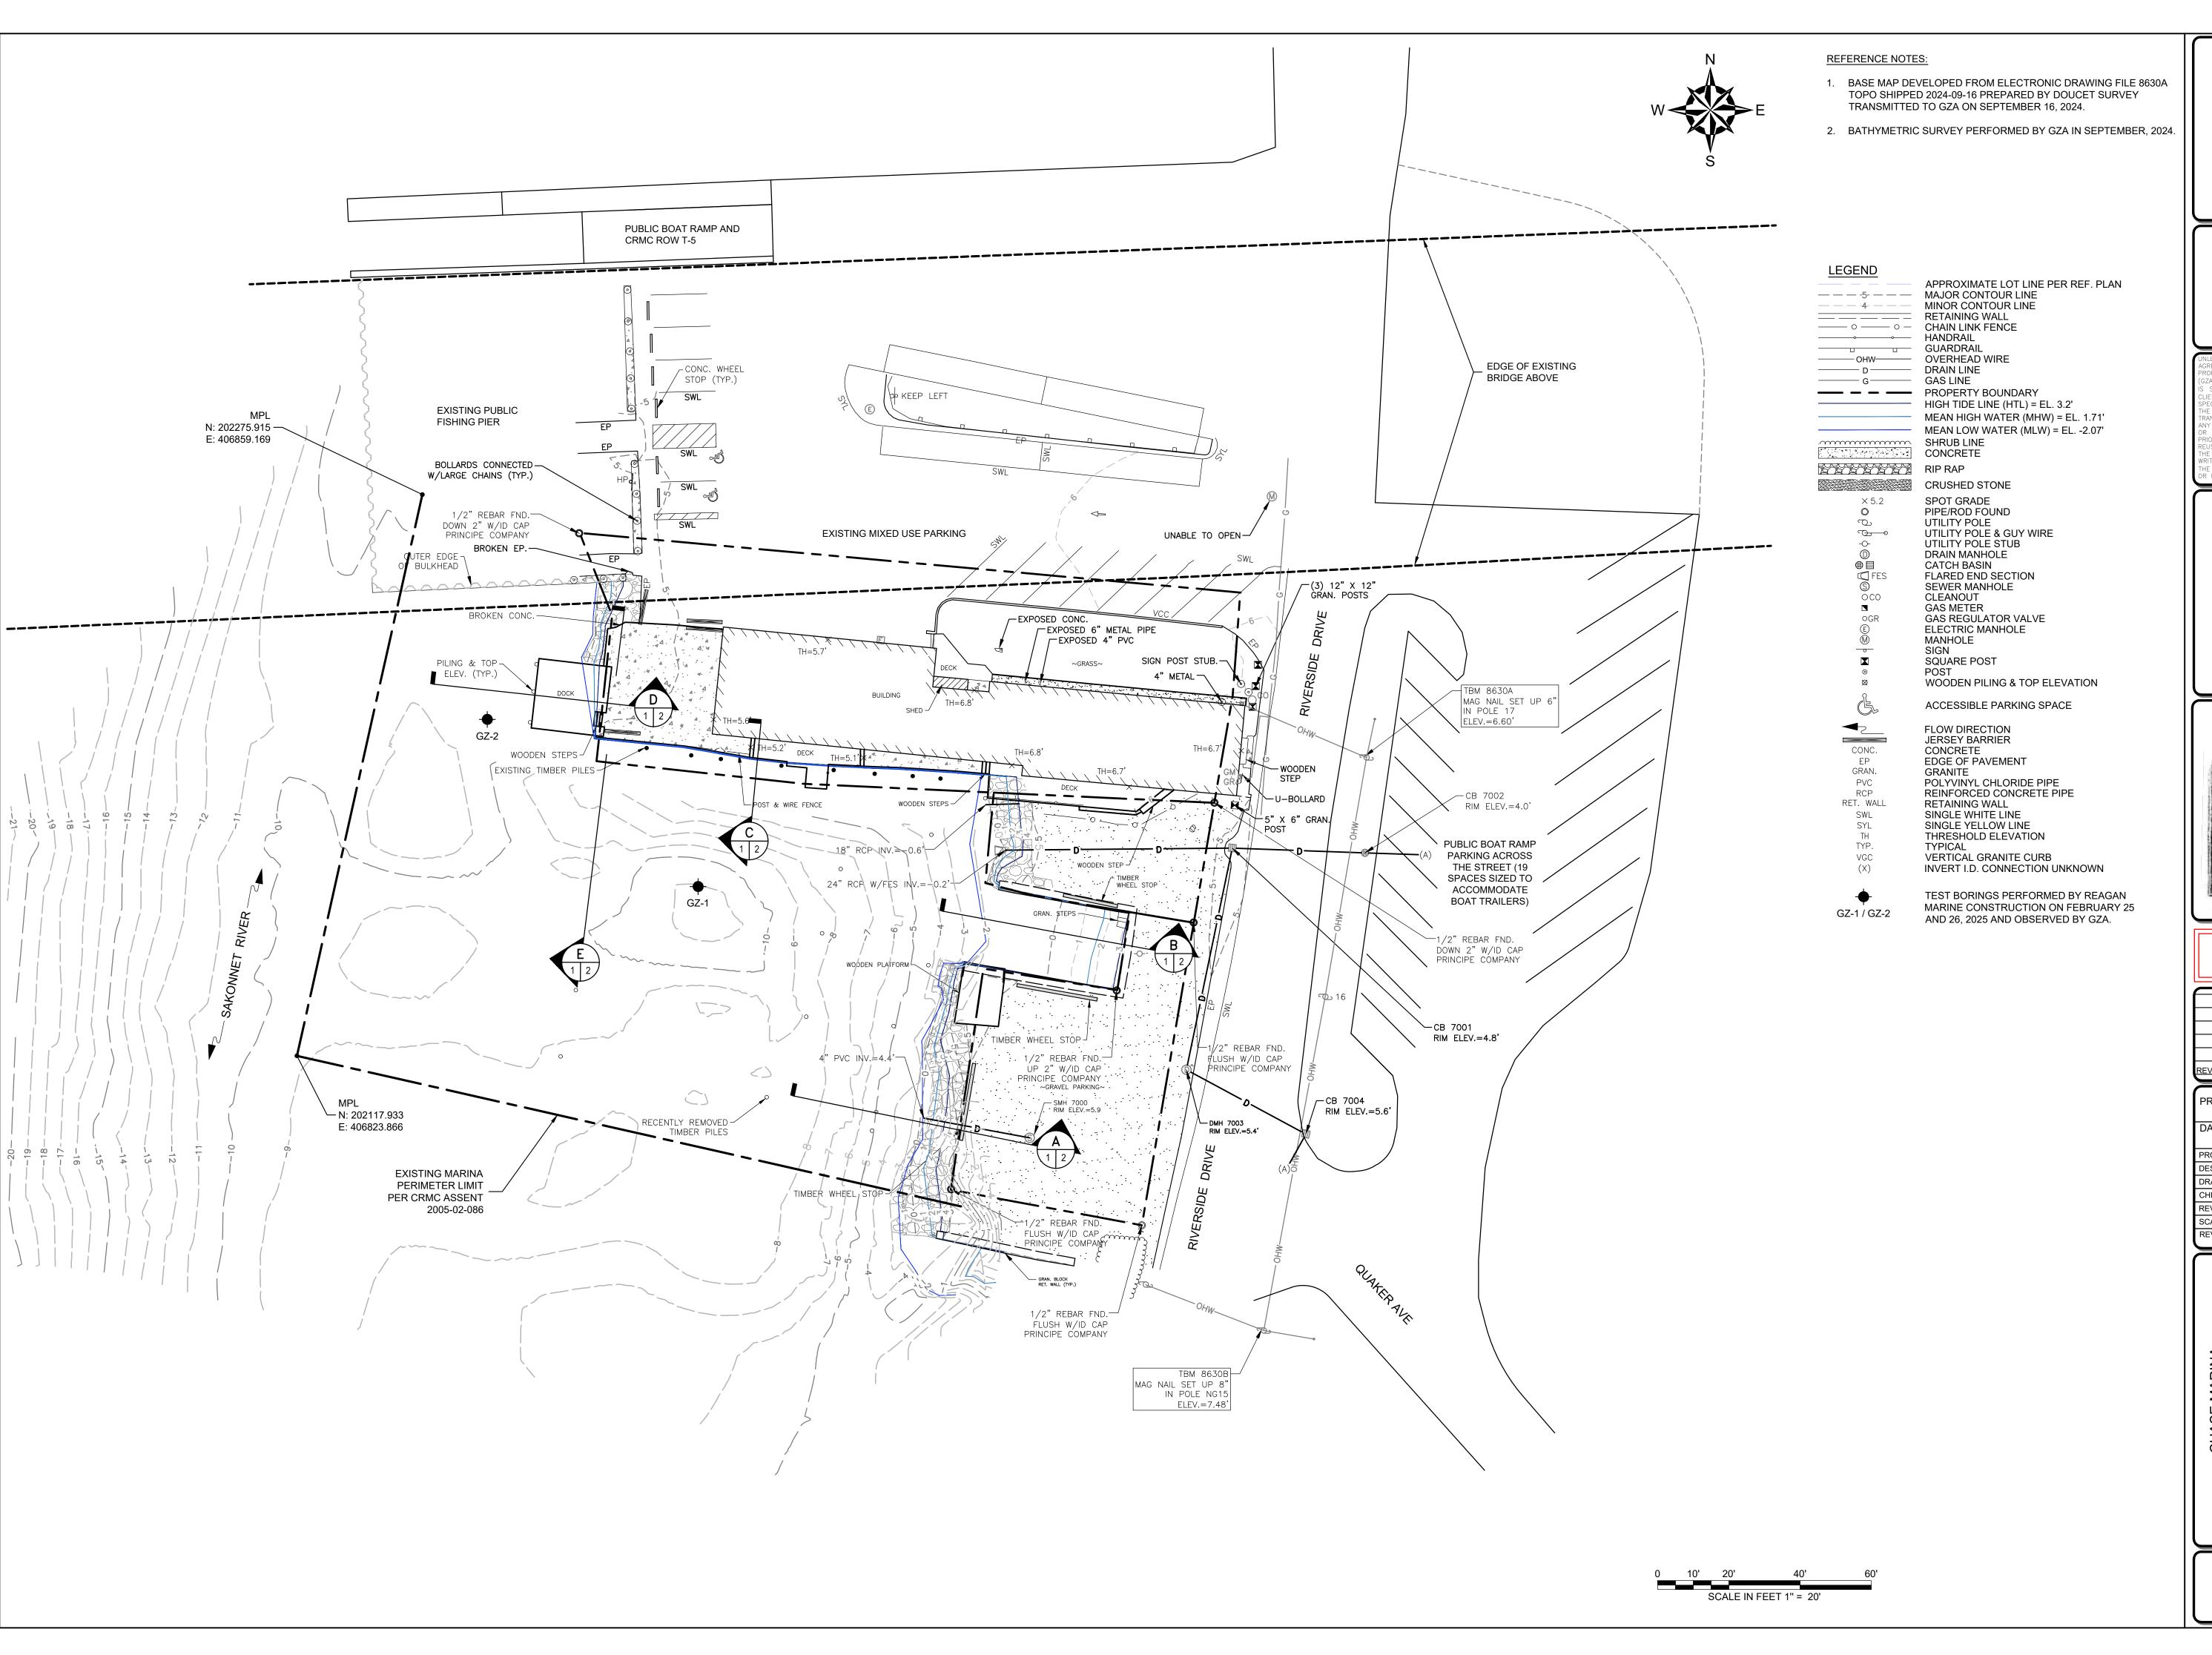


PREPARED FOI



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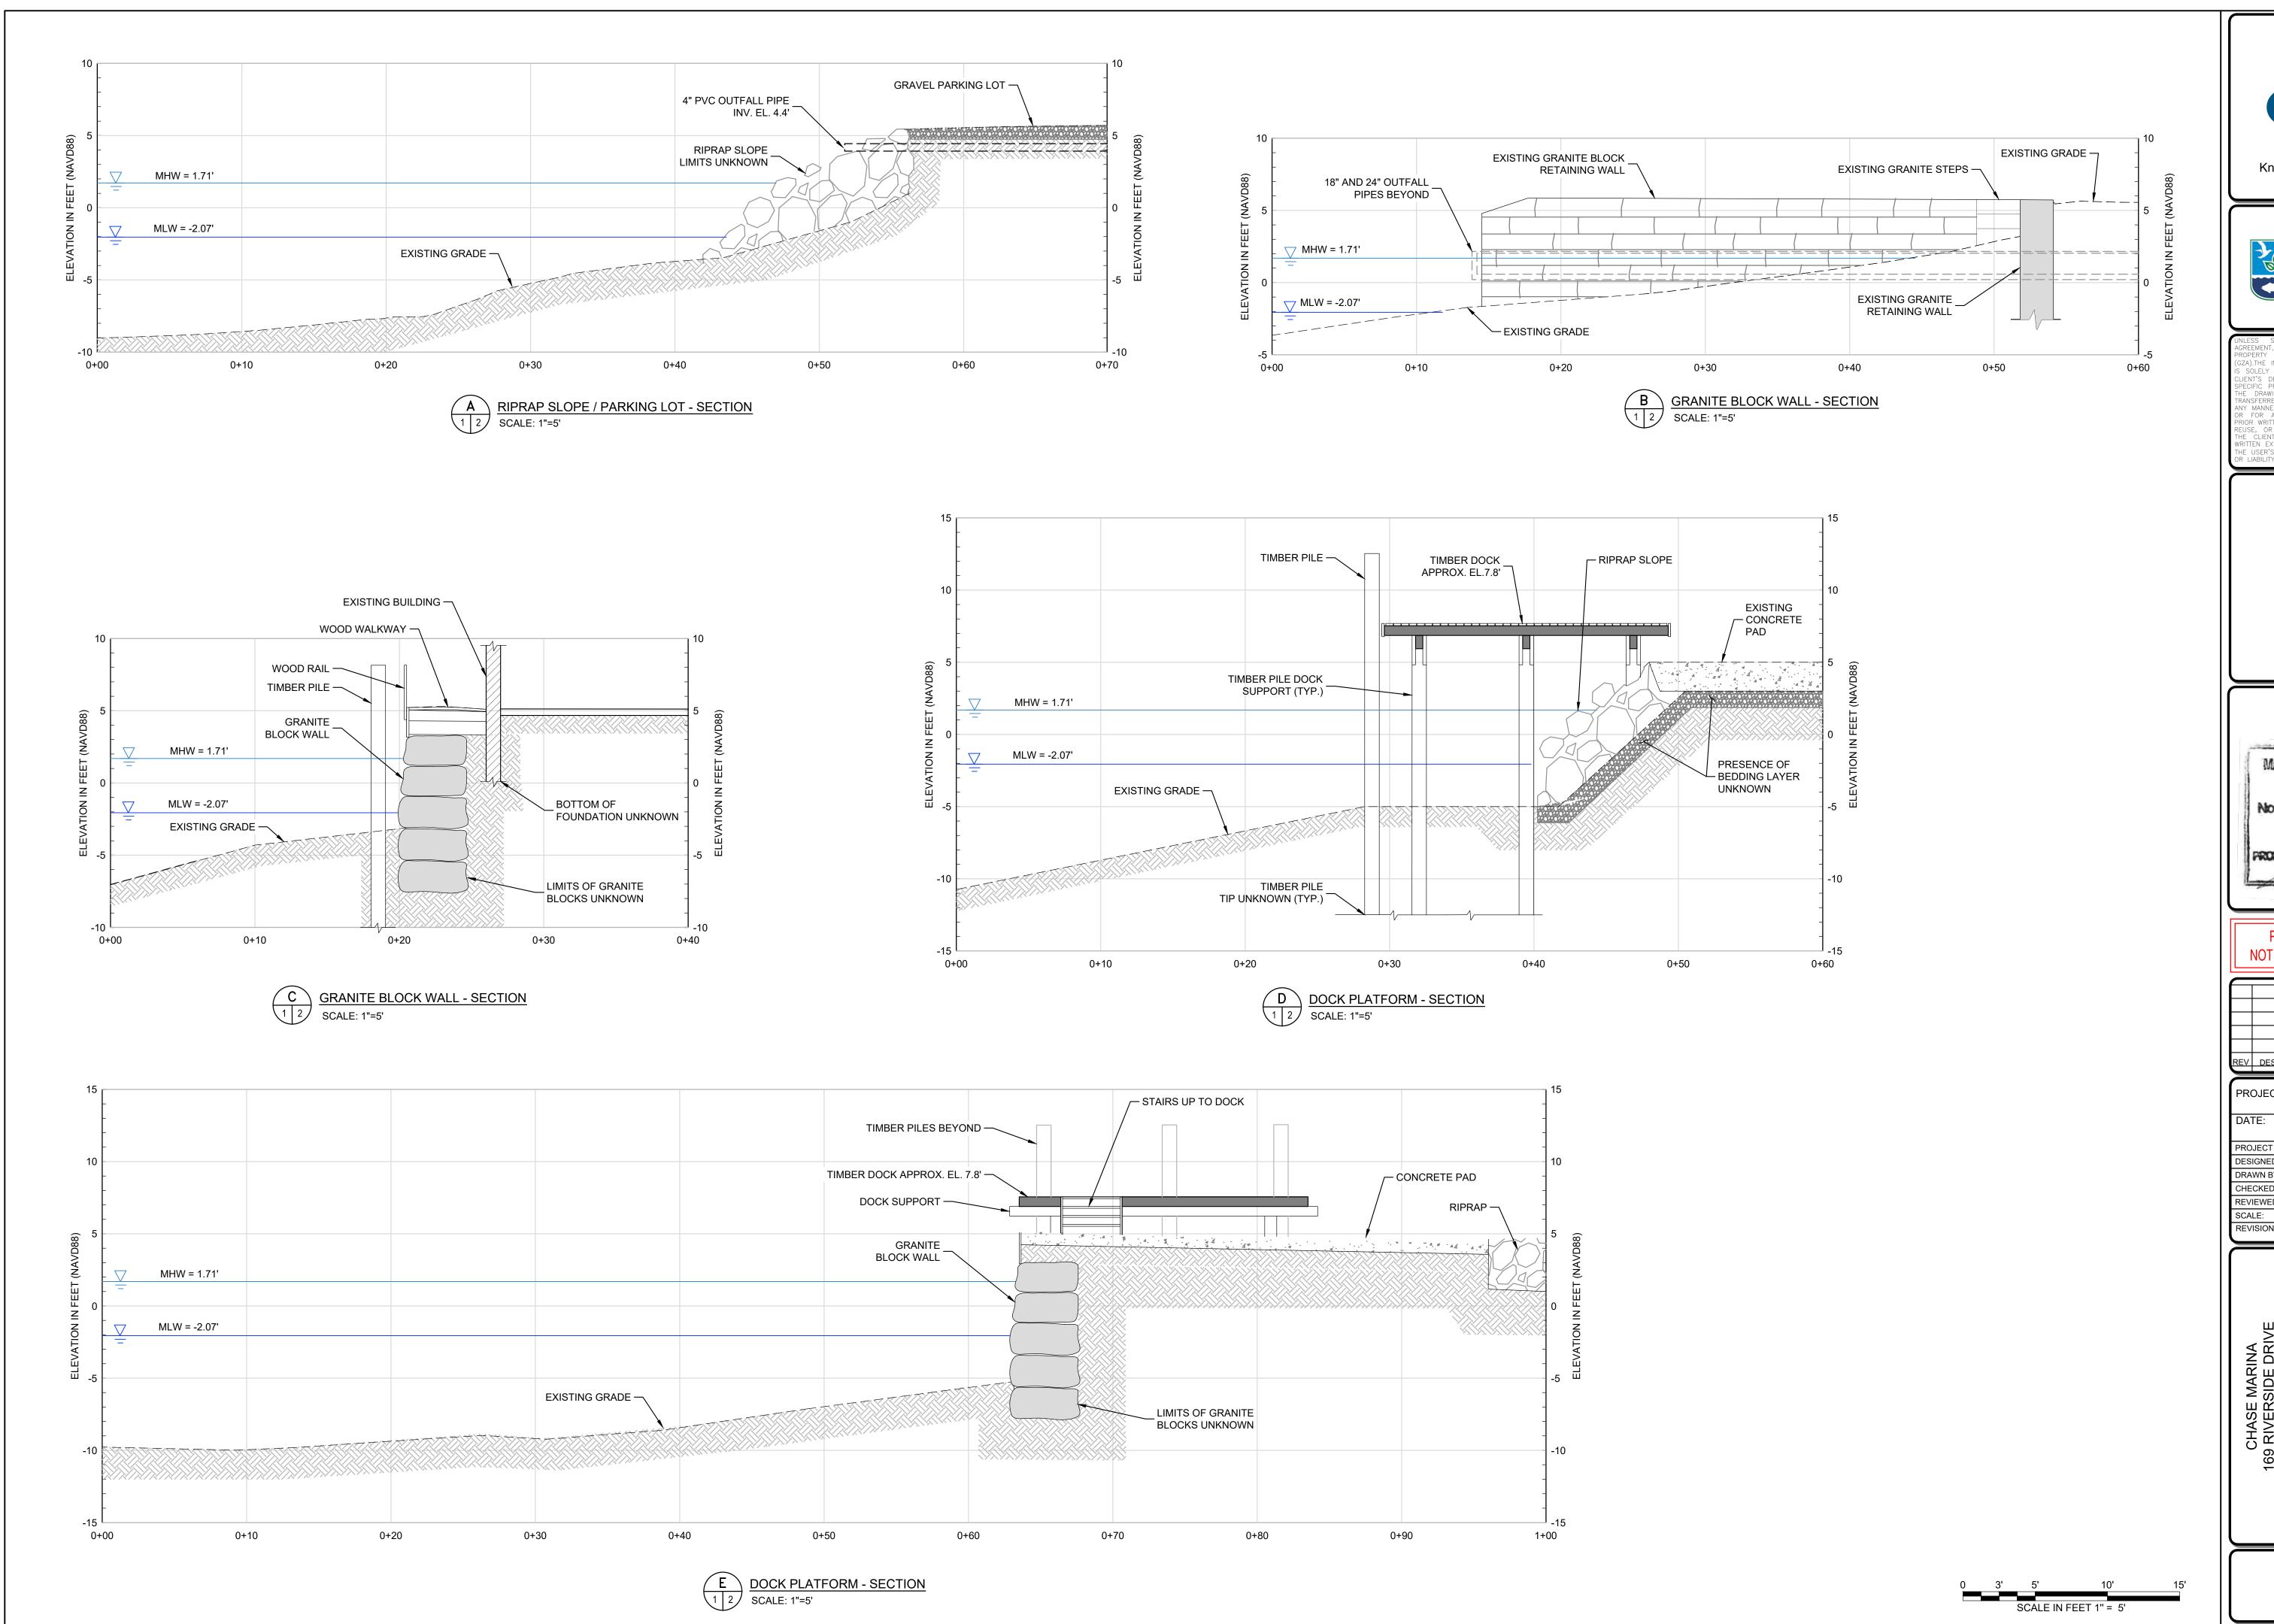
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PROJECT NO:	
	35429.00
DATE:	
	OCTOBER, 2025
PROJECT MGR:	TWS
DESIGNED BY:	JTF
DRAWN BY:	GRB
CHECKED BY:	TWS
REVIEWED BY:	MJP
SCALE:	AS NOTED
REVISION NO.	

EXISTING CONDITIONS PLAN
CHASE MAKINA 169 RIVERSIDE DRIVE TIVERTON, RHODE ISLAND

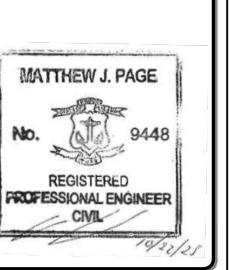DRAWING

3
SHEET NO. 3 OF 15






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10-22-2025

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REV	DESCRIPTION	DATE	BY

PROJECT NO:

35429.00

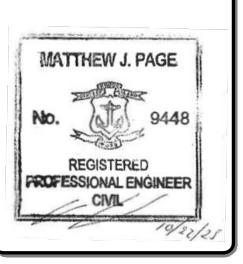DATE:

OCTOBER, 2025

PROJECT MGR: TWS

DESIGNED BY: JTF

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CHECKED BY: TWS

REVIEWED BY: MJP


SCALE: AS NOTED

REVISION NO.


169 RIVERSIDE DRIVE
TIVERTON, RHODE ISLAND
EXISTING CONDITIONS SECTIONS

DRAWING

4
SHEET NO. 4 OF 15

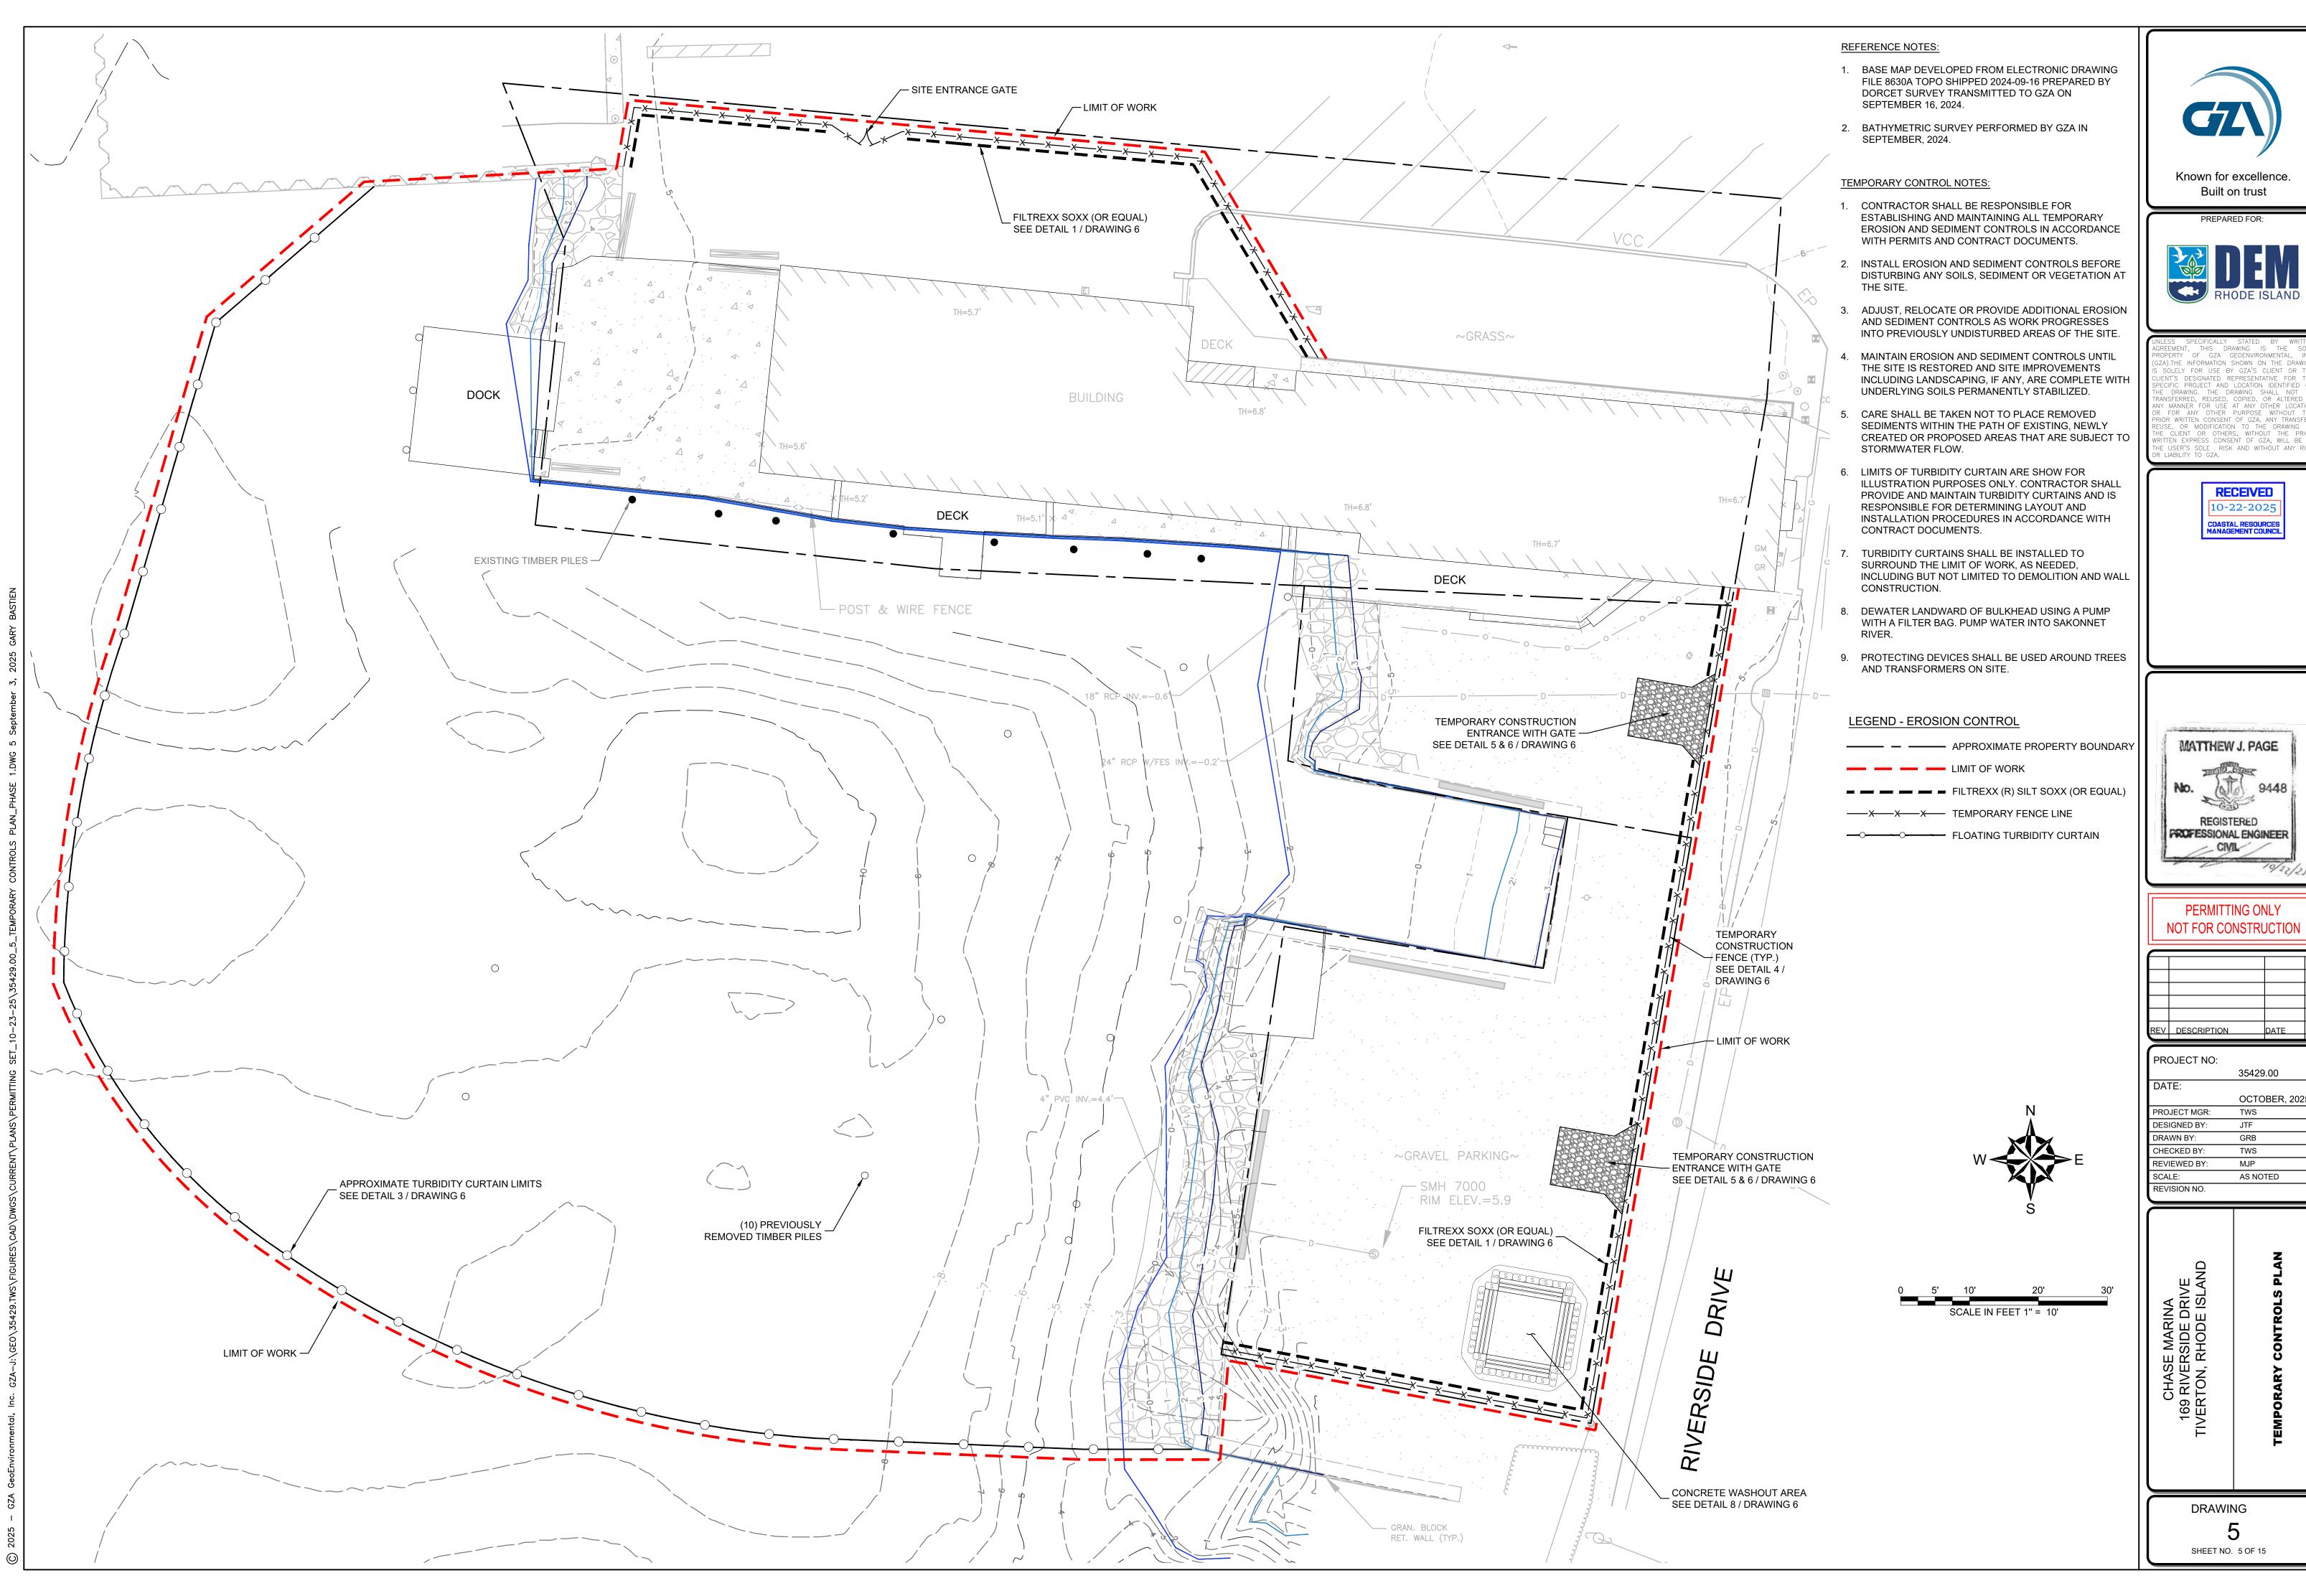



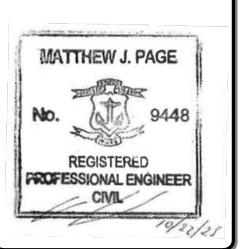


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REV	DESCRIPTION		DATE	BY
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PROJECT NO:				

OCTOBER, 2025


- 1. ALL MATERIAL TO MEET FILTREXX® SPECIFICATIONS.
- 2. STAKES/REBAR PINS SHALL HAVE PROTECTIVE CAPS INSTALLED TO PREVENT FALL INJURY.




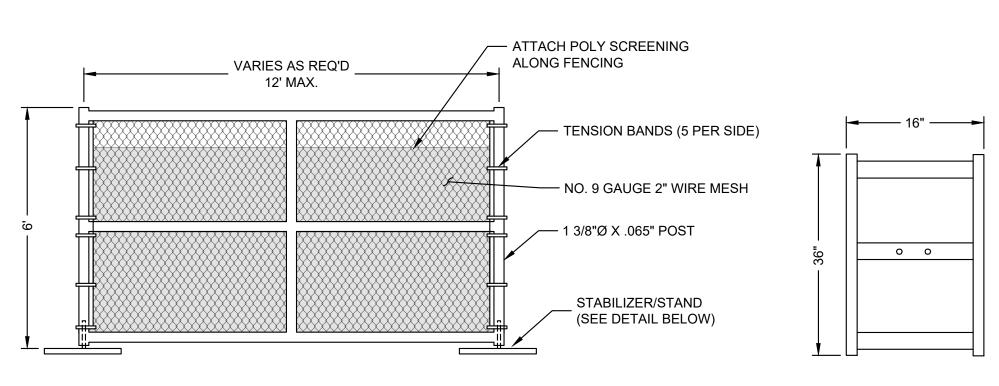


TEMPORARY CONSTRUCTION FENCING NOTES:

- 1. FENCES SHALL BE CONSTRUCTED WITH A TOP AND BOTTOM RAIL.
- 2. GATES MUST REMAIN IN GOOD WORKING ORDER AND MUST BE CLOSED AND SECURED DURING NON-WORKING HOURS.
- 3. GATES SHALL BE CONSTRUCTED SO THAT THEY SWING IN TOWARDS THE CONSTRUCTION SITE.
- 4. GATES MUST BE CONSTRUCTED WITH THE SAME DESIGN CHARACTERISTICS AS THE TEMPORARY CONSTRUCTION FENCE.

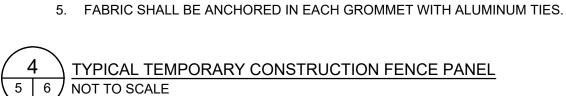

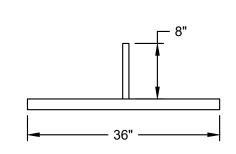

TYPICAL FENCE STABILIZER/STAND NOT TO SCALE

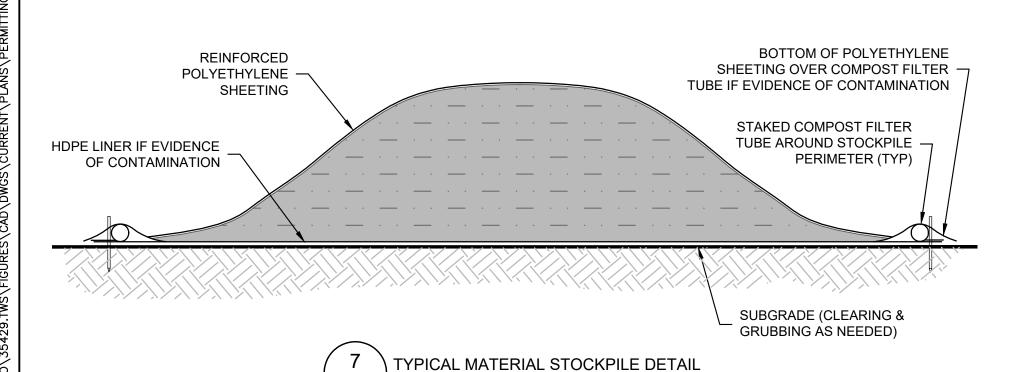


SOIL STOCKPILE NOTES:

- 1. SOIL STOCKPILES SHALL BE PLACED ON AND COVERED WITH POLYETHYLENE SHEETING AT ALL TIMES TO PREVENT DUST OR IS SUSPECTED OF CONTAMINATION.
- 2. SHEETING COVERING STOCKPILE SHALL BE MAINTAINED TIGHTLY IN PLACE BY USING SANDBAGS ON ROPES WITH A MAXIMUM 10'-0" GRID SPACING IN ALL DIMENSIONS.
- 3. MINIMUM 12" OVERLAP OF ALL SEAMS REQUIRED.


- 6 NOT TO SCALE

- 4. STOCKPILE SIDE SLOPES SHALL BE NO STEEPER THAN 3 (HORIZONTAL) TO 1 (VERTICAL).
- 5. STOCKPILE SHALL BE SURROUNDED BY EROSION CONTROLS AS SHOWN.

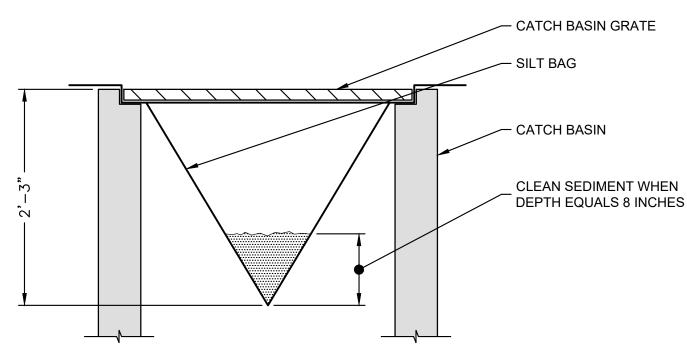



- SEDIMENT BAG INLET PROTECTION TO BE SILT SACK MANUFACTURED BY ATLANTIC CONSTRUCTION FABRICS INC. RICHMOND, VA OR APPROVED EQUAL.
- 2. STORM WATER CATCH BASINS OR DRAINS SHALL BE PROTECTED FROM MATERIALS RUN-OFF. CONTRACTOR SHALL INSTALL SILT SACKS WITHIN EACH CATCH BASIN IN THE VICINITY OF ANY WORK AREAS IN ACCORDANCE WITH MANUFACTURER'S RECOMMENDATIONS. CONTRACTOR SHALL USE ALL BMP'S NECESSARY TO PROTECT THESE INLETS FROM SEDIMENT AND DEBRIS.



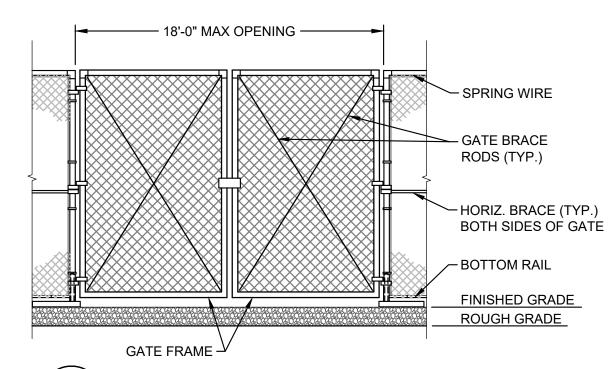


TYPICAL TEMPORARY CONSTRUCTION 5 6 DOUBLE SWING GATE

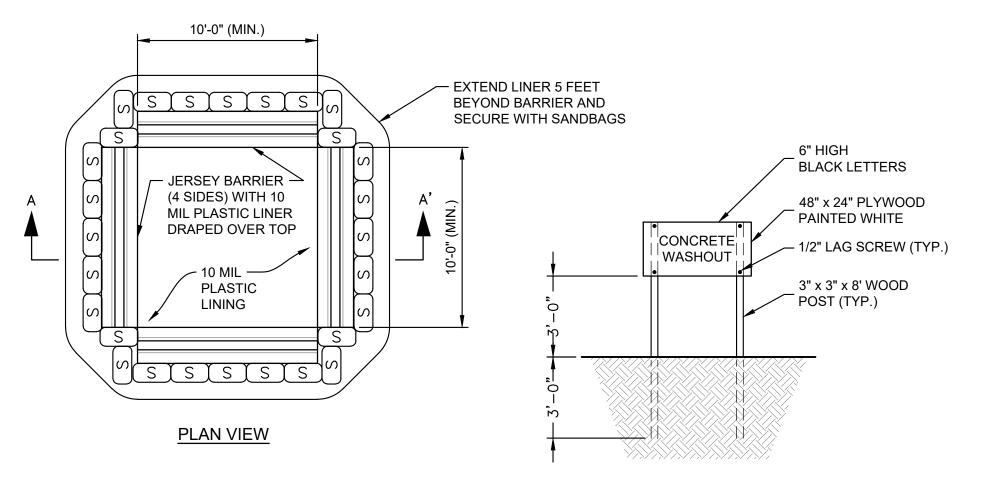

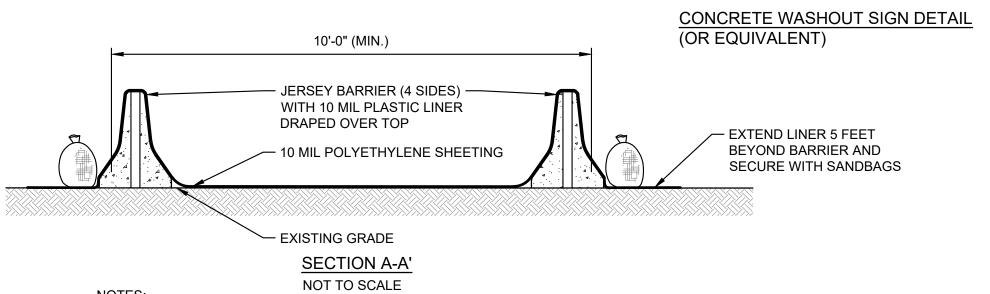


1. SUMPS TO BE CLEANED AND WASTE CONCRETE AND WATER REMOVED AND PROPERLY DISPOSED OF UPON COMPLETION OF WORK.

> CONCRETE WASHOUT AREA NOT TO SCALE

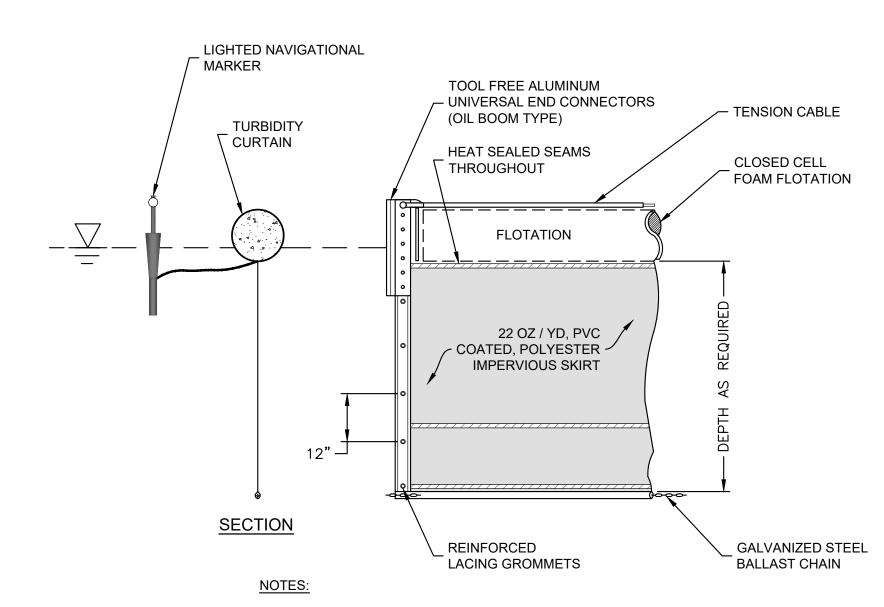

- 1. REFER TO SECTION 01 57 00 TEMPORARY CONTROLS FOR MINIMUM REQUIREMENTS OF TURBIDITY CURTAINS.
- 2. END OF CURTAIN SHALL BE ANCHORED SECURELY AT THE SHORELINE ABOVE MEAN HIGH WATER ELEVATION IN ACCORDANCE WITH MANUFACTURERS SPECIFICATIONS.
- 3. TURBIDITY CURTAINS SHALL BE INSPECTED REGULARLY TO DETERMINE IF ALL COMPONENTS ARE FUNCTIONING PROPERLY.



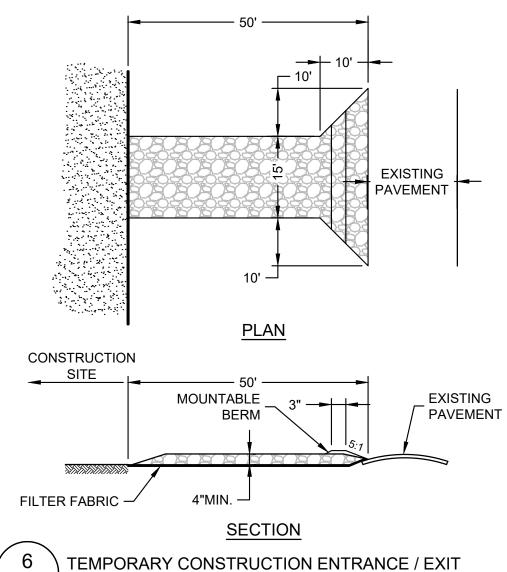

NOT TO SCALE


- 1. STONE SIZE USE 2" STONE (MINIMUM) TO 6" STONE (MAXIMUM). 2. LENGTH - GREATER THAN OR EQUAL TO 50 FEET WITH THICKNESS OF 4".
- 3. WIDTH FIFTEEN (15) FOOT TYP., BUT NOT LESS THAN FULL WIDTH AT POINTS WHERE INGRESS OR EGRESS OCCURS.
- 4. SURFACE WATER ALL SURFACE WATER FLOWING OR DIVERTED TOWARD CONSTRUCTION ENTRANCES SHALL BE PIPED ACROSS ENTRANCE. IF PIPING IS IMPRACTICAL, MOUNTABLE BERM SHALL BE PERMITTED.
- 5. MAINTENANCE THE ENTRANCE SHALL BE MAINTAINED IN A CONDITION WHICH SHALL PREVENT TRACKING OR FLOWING OF SEDIMENT ONTO PUBLIC RIGHTS-OF-WAY. THIS MAY REQUIRE PERIODIC TOP DRESSING AND ADDITIONAL STONE AS CONDITIONS DEMAND AND REPAIR OR CLEANOUT OF ANY MEASURES USED TO TRAP SEDIMENT. ALL SEDIMENT SPILLED, DROPPED, WASHED OR TRACKED ONTO PUBLIC RIGHTS-OF-WAY MUST BE REMOVED IMMEDIATELY.
- PERIODIC INSPECTION AND NEEDED MAINTENANCE SHALL BE PROVIDED.
- 7. THE CLEAN STONE SHOULD BE INSTALLED OVER A GEOTEXTILE FABRIC. GEOTEXTILE FABRIC MAY BE OMITTED FOR PERMANENT CONSTRUCTION ENTRANCES-EXITS ON A CASE-BY-CASE BASIS WITH THE APPROVAL OF THE NATIONAL GRID ENVIRONMENTAL.
- 8. FOLLOWING CONSTRUCTION, THE CONSTRUCTION ENTRANCE / EXIT SHALL BE REMOVED AND THE AREA GRADED, SEEDED, AND MULCHED AS NEEDED. ENTRANCE / EXITS MAY REMAIN DEPENDING UPON FUTURE ACCESS NEEDS AND / OR PROJECT-SPECIFIC APPROVALS BUT REQUIRES APPROVALS FROM THE NATIONAL GRID ENVIRONMENTAL AND PROPERTY LEGAL




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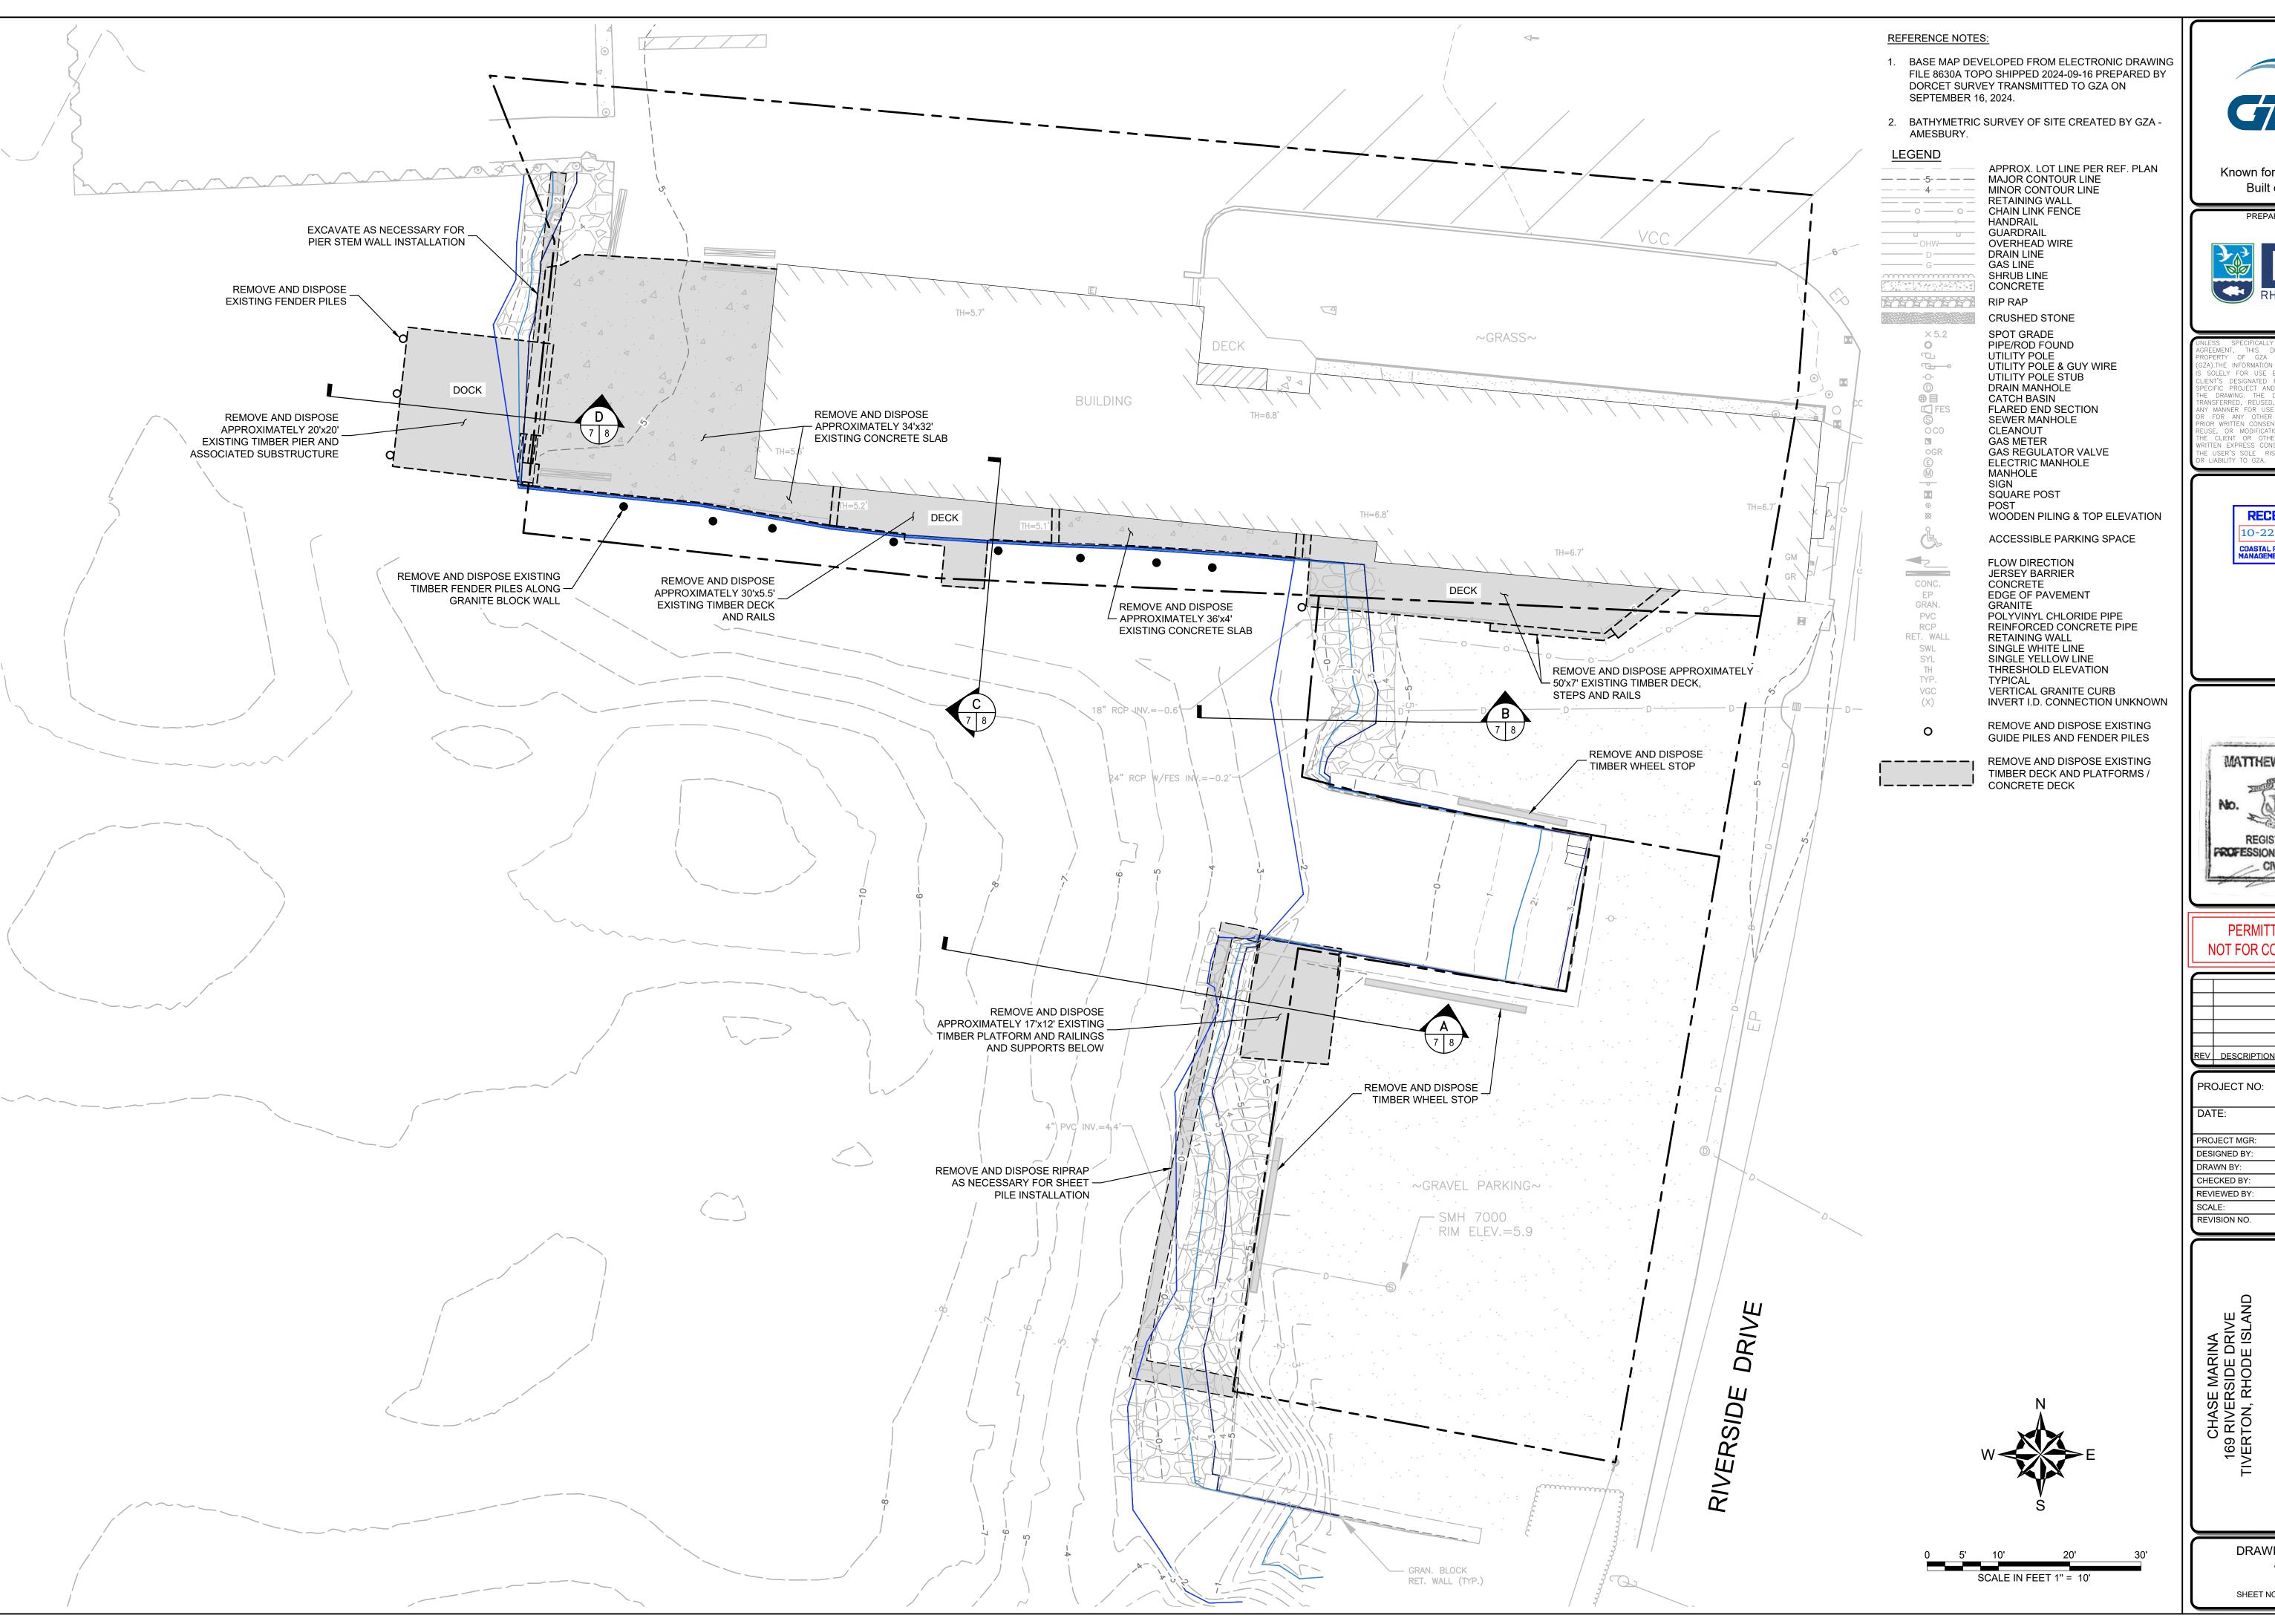


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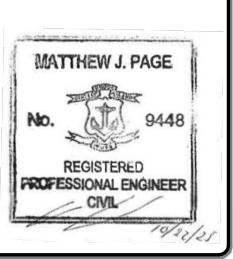
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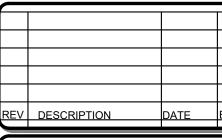


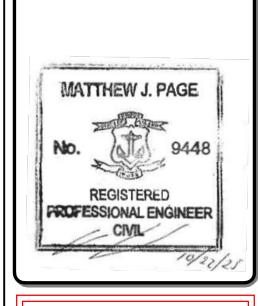

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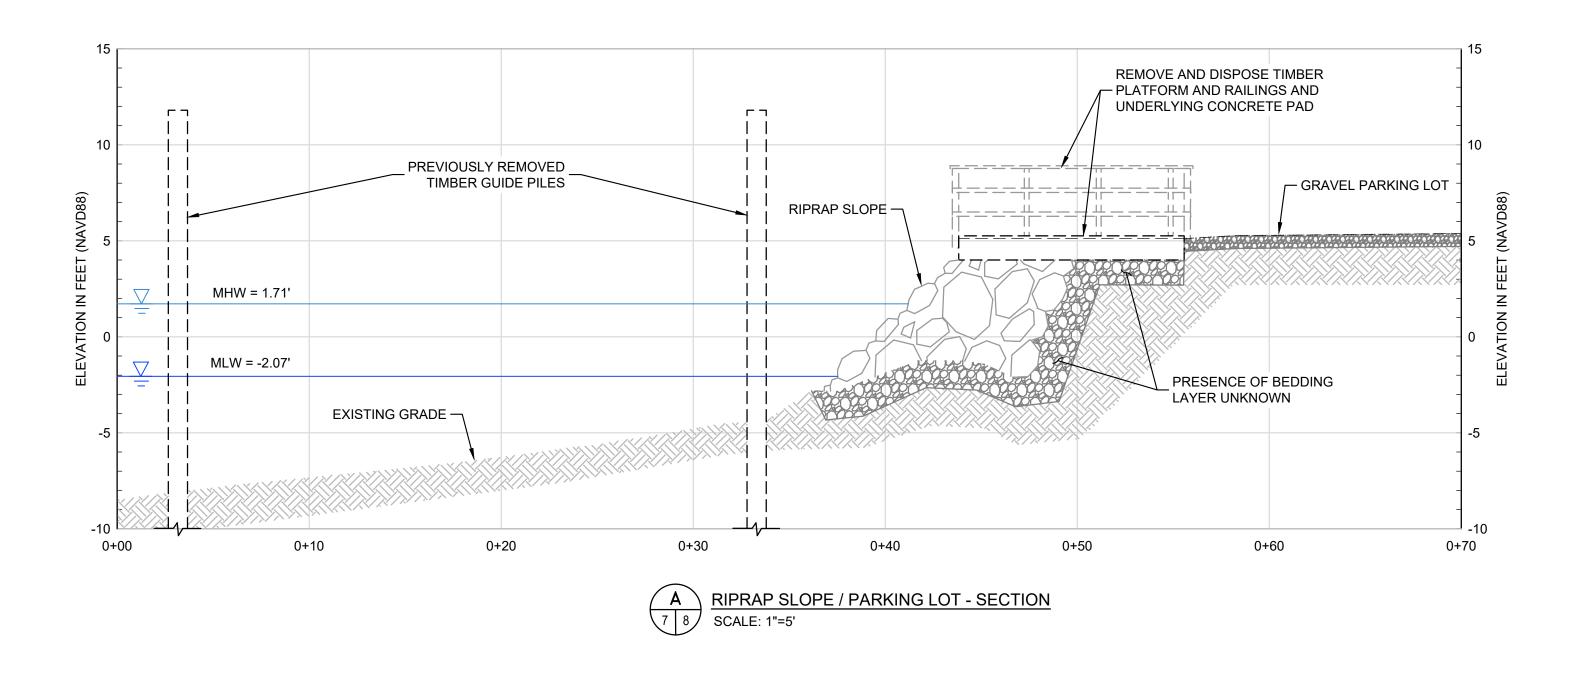



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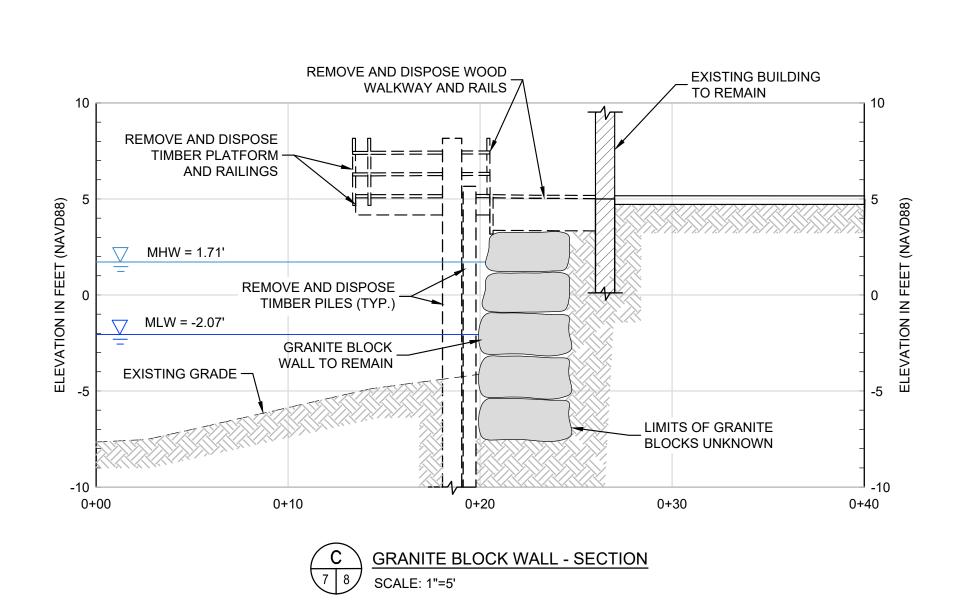
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DATE:	
	OCTOBER, 2025
PROJECT MGR:	TWS
DESIGNED BY:	JTF
DRAWN BY:	GRB
CHECKED BY:	TWS
REVIEWED BY:	MJP
SCALE:	AS NOTED
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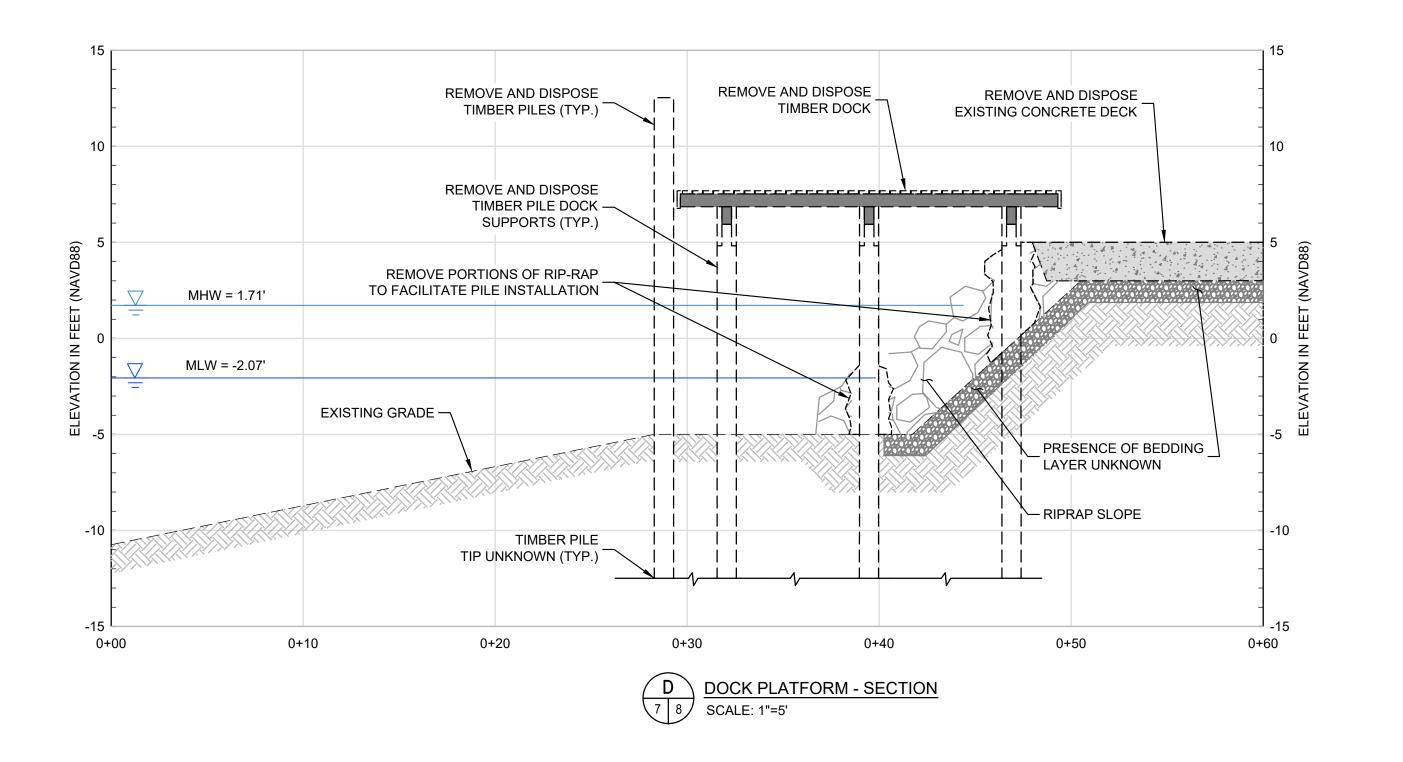
DRAWING SHEET NO. 7 OF 15

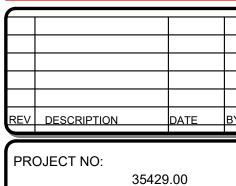



B
7 8 RIPRAP SLOPE / PARKING LOT - SECTION
SCALE: 1"=5"



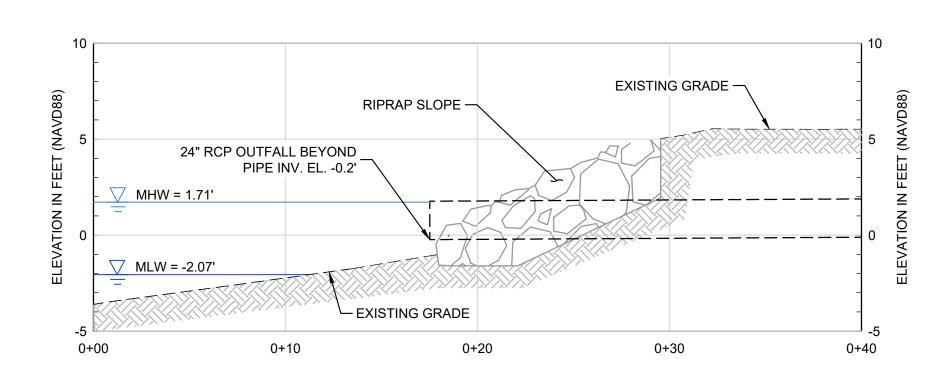


NOTES:

 LIMITS AND EXTENT OF BELOW GRADE RIPRAP, BEDDING LAYERS, BUILDING FOUNDATIONS, AND STONE WALLS ARE UNKNOWN.




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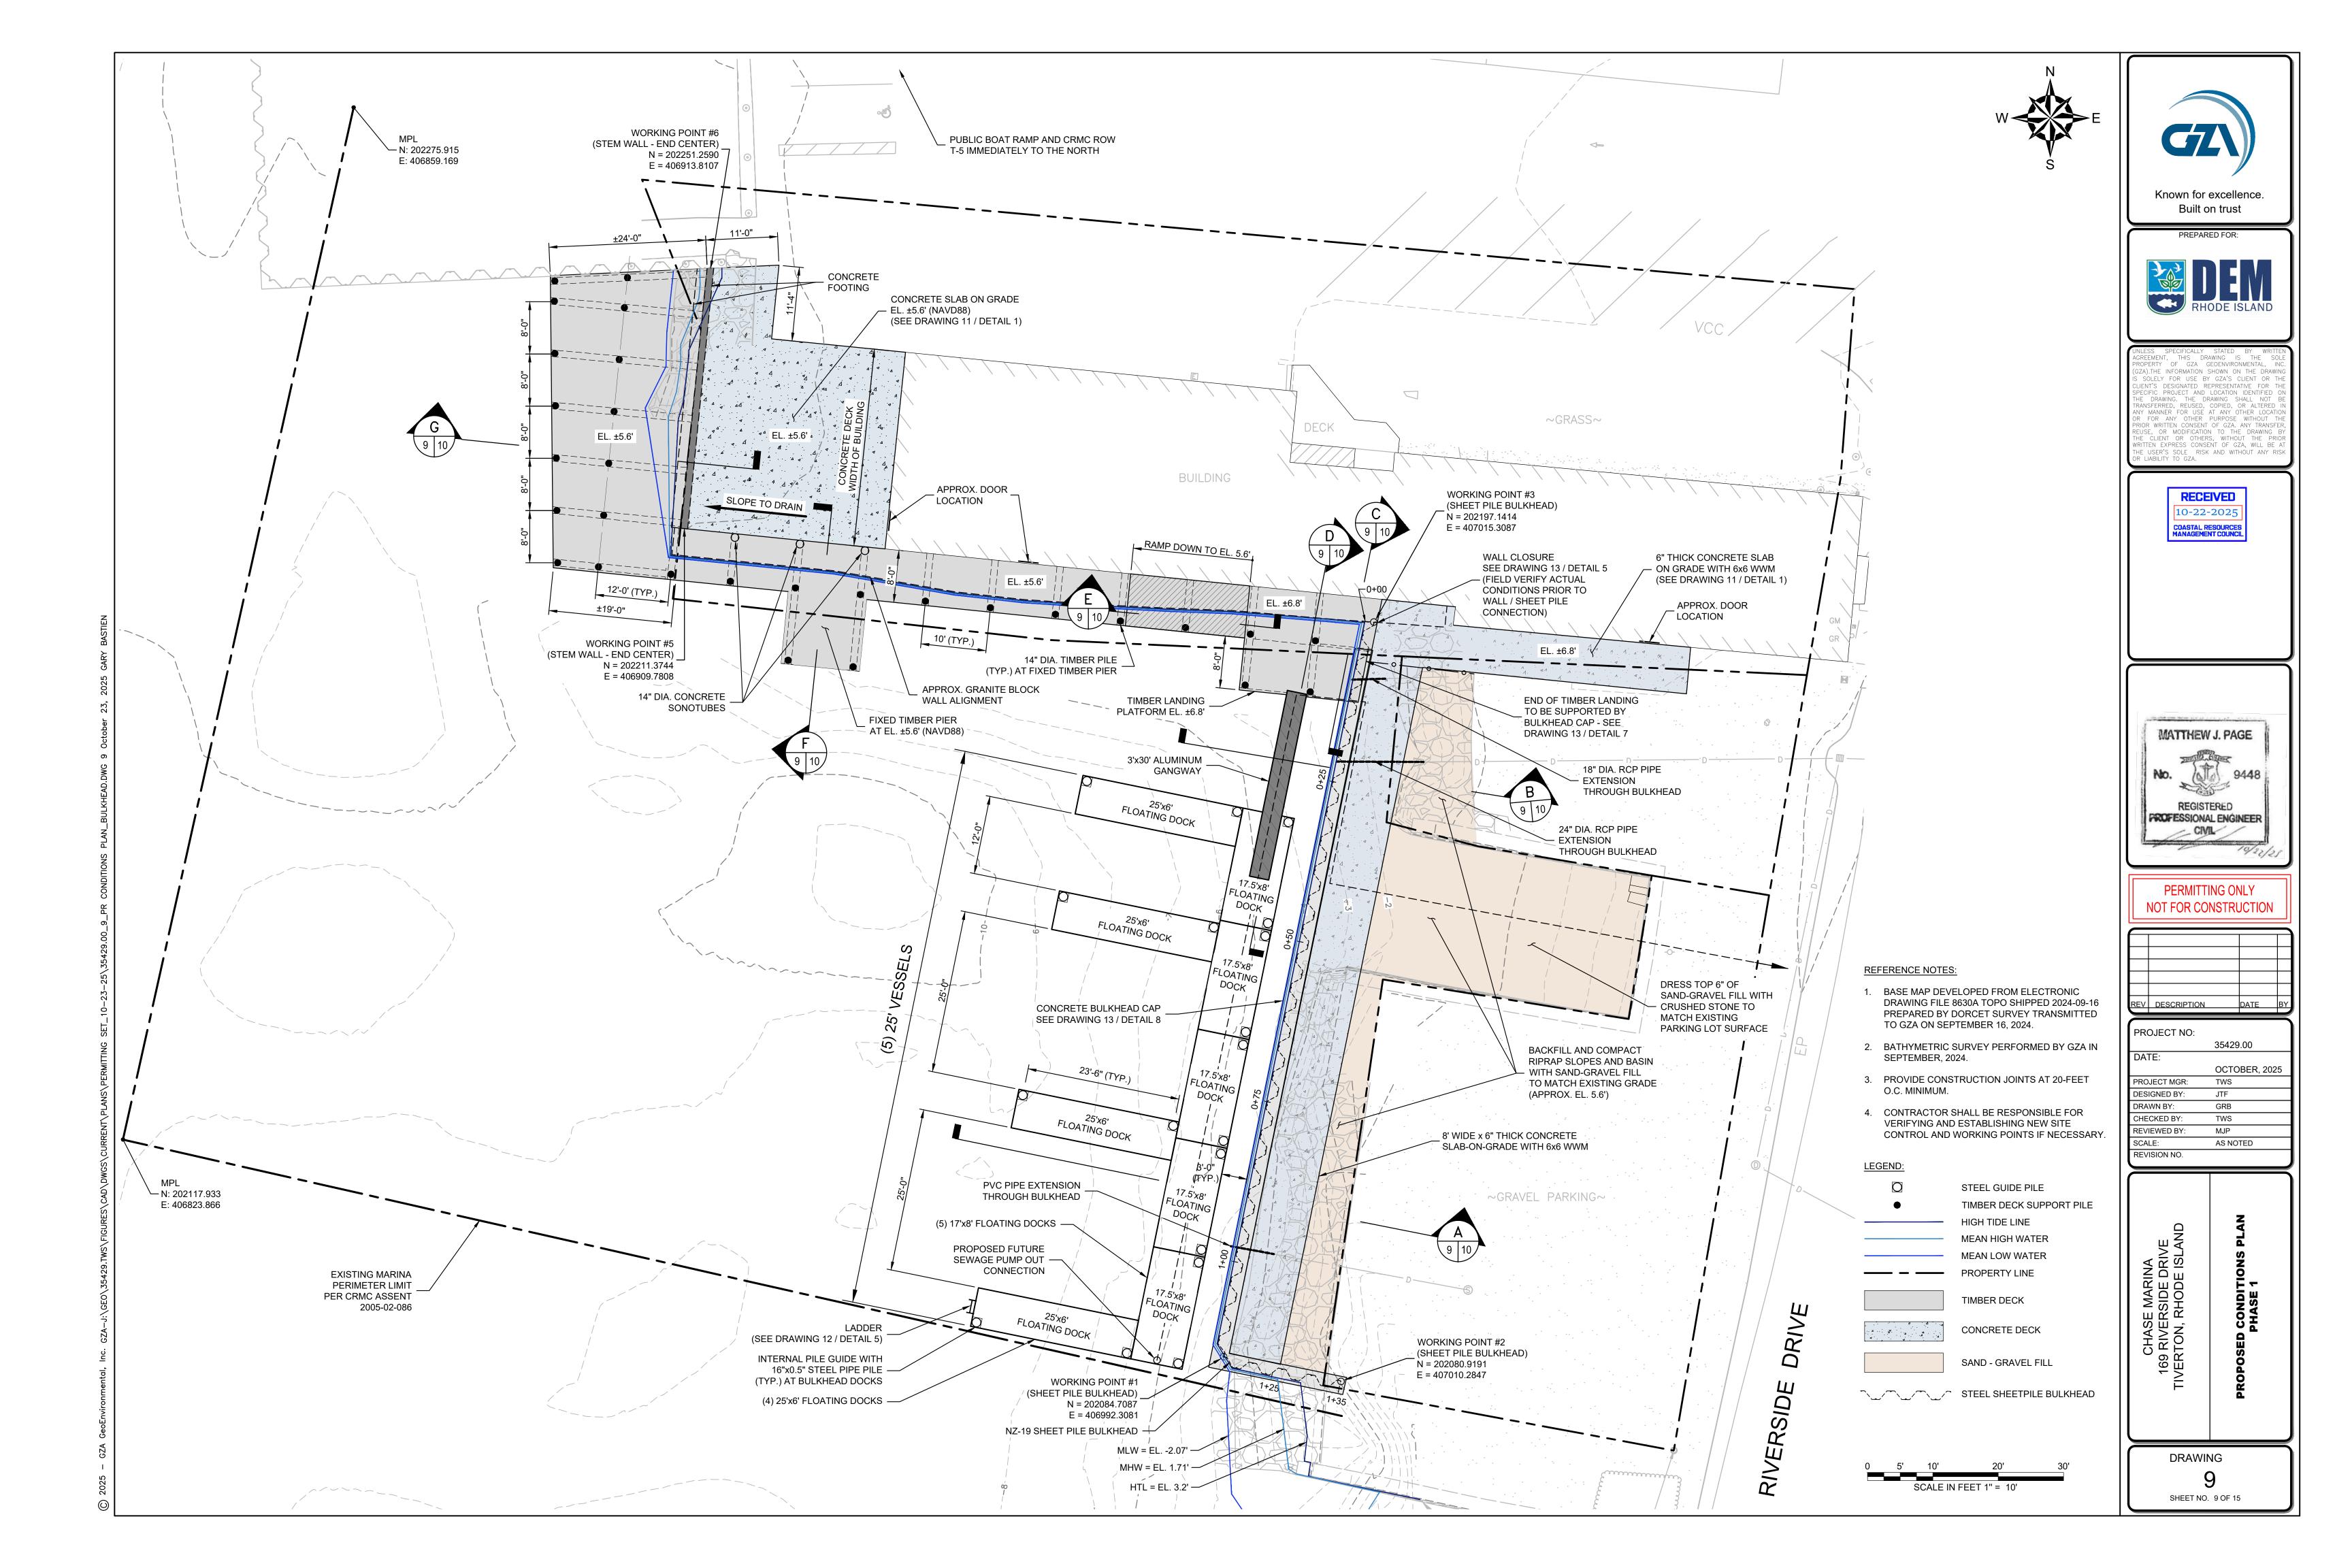
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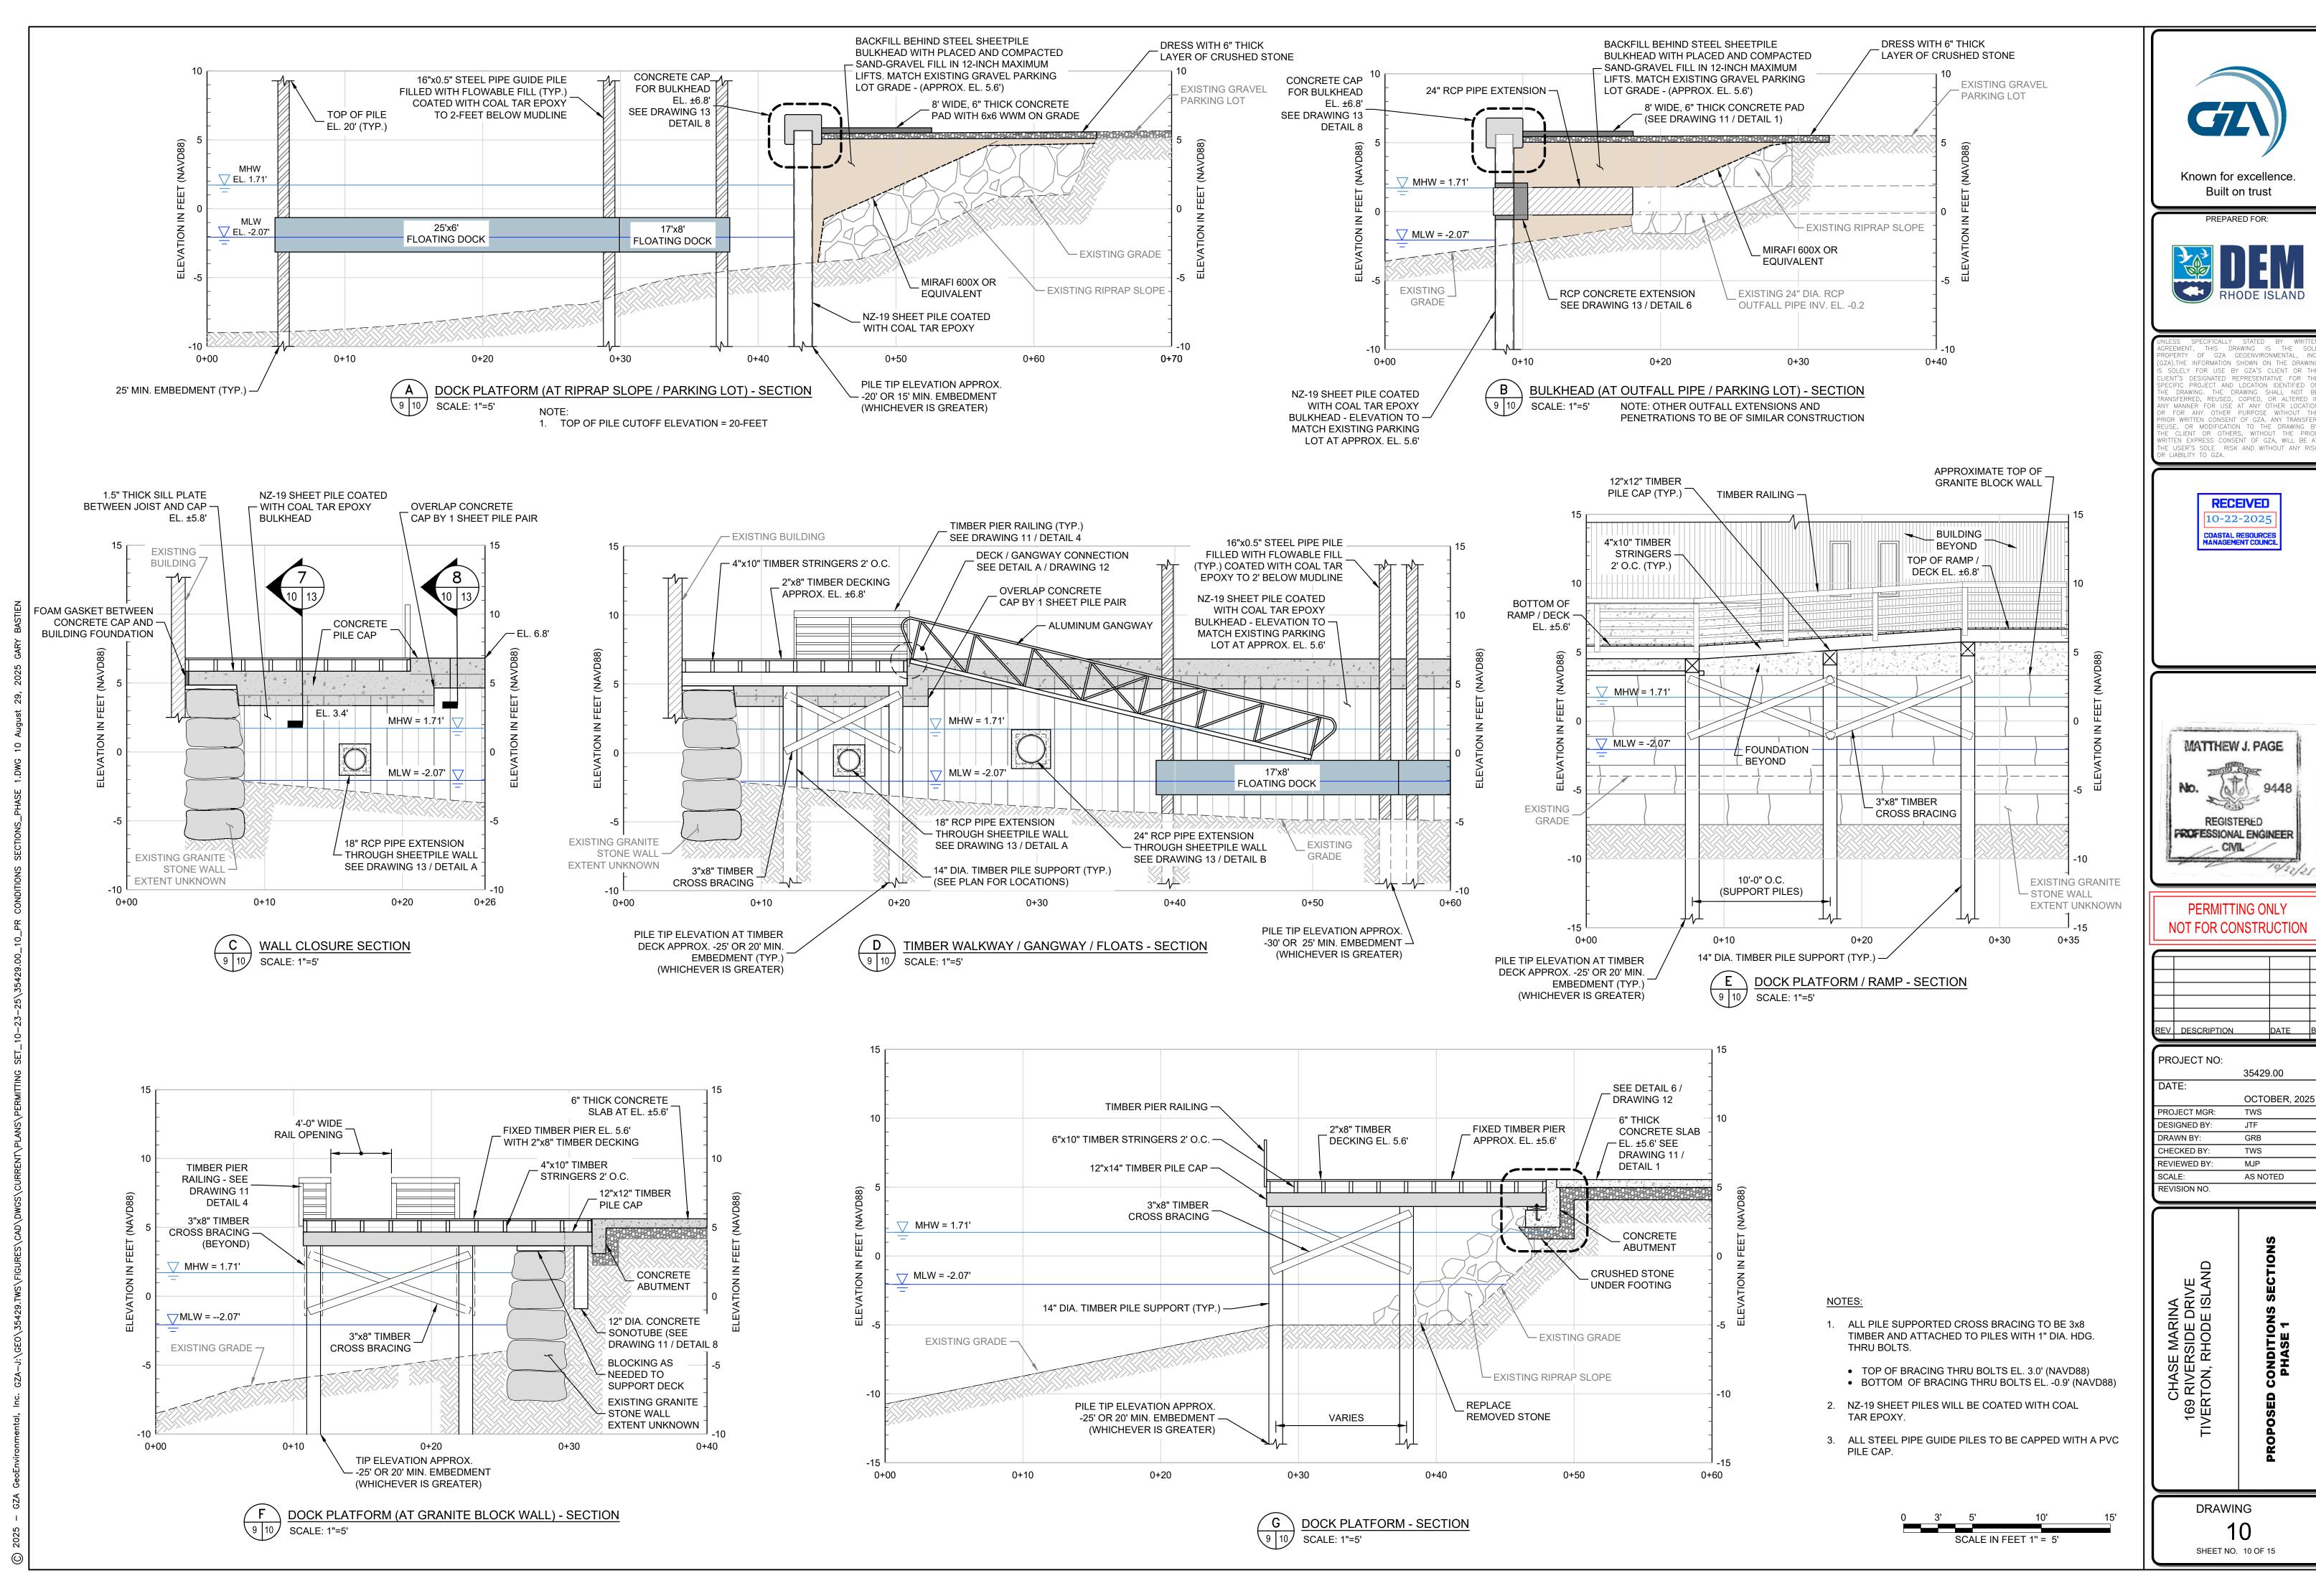
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169 RIVERSIDE DRIVE
TIVERTON, RHODE ISLAND
DEMOLITION SECTIONS

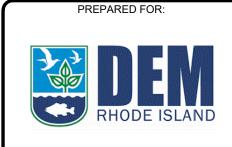
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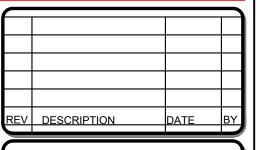
8
SHEET NO. 8 OF 15






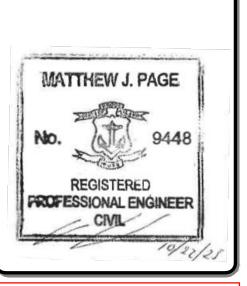



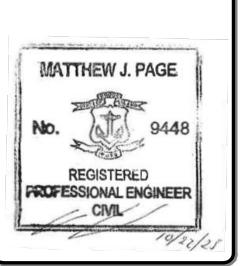

OCTOBER, 2025

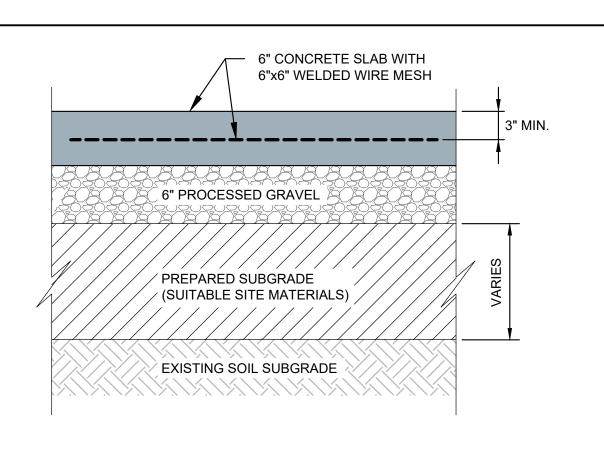

CONCRETE SLAB-ON-GRADE DETAIL SCALE: 1" = 4'

5 1/2"

6x6 POSTS BEYOND @ 6'± O.C.

2x12 ACQ TREATED CAP -

2x6 ACQ TREATED RAIL

2x3 ACQ TREATED RAILS-

4x10 OR 6x10 STRINGERS -

L4x4x1/2"x8"L. CONNECTOR -WITH (X2) 1/2" Ø HDG

THRU BOLTS PER LEG (TYP.)

4X10 STRINGER (TYP.) —

PILE (TYP., BELOW)

12X12 PILE CAP -

(TYP., BELOW)

14" DIA. SYP -

CUT TO FIT

2x8 DECKING —

3 1/2"

3 1/2"

12x12 PILE CAP


4 TIMBER RAIL - SECTION

NOTES: SEE NOTE 4


2X10 BLOCKING (TYP.) —

2'-0" (TYP.)

SCALE: 1" = 1'

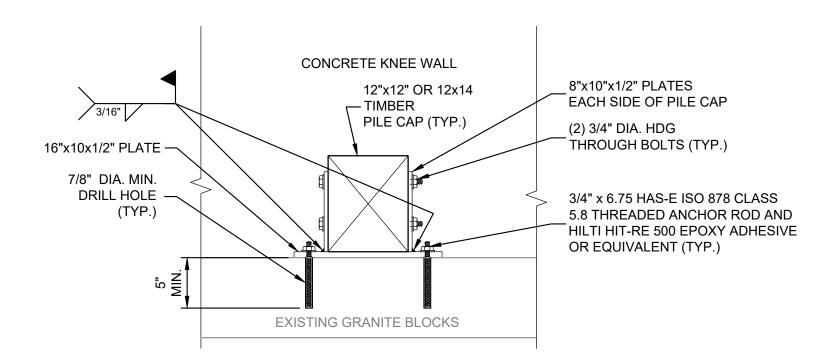


TIMBER PILE CAP TO GRANITE BLOCK CONNECTION DETAIL NOT TO SCALE

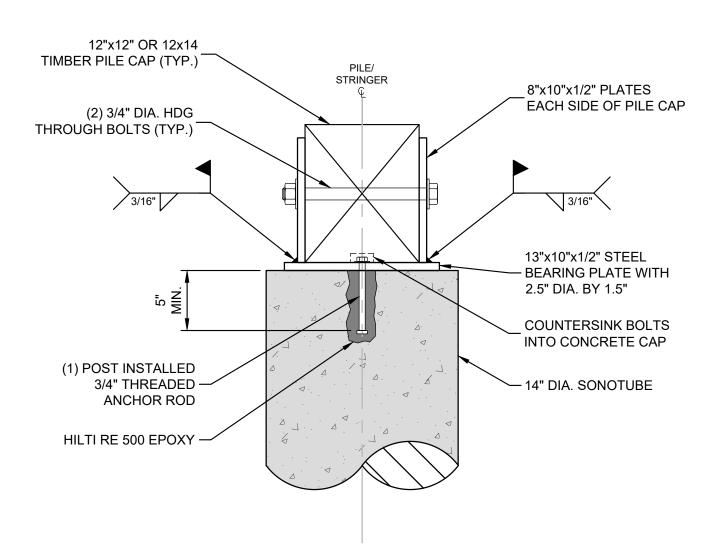

TIMBER PILE CAP TO SONOTUBE CONNECTION SCALE: 1-1/2"=1'


ELEVATION

- 1. TIMBER MEMBERS LOCATED BELOW THE DECKING SHALL BE SOUTHERN YELLOW PINE (SYP) GRADE NO. 2, TREATED WITH 2.5# CCA, UNLESS NOTED OTHERWISE.
- 2. TIMBER PILE CAPS IN THE ALIGNED IN THE EAST-WEST DIRECTION SHALL BE SYP GRADE NO. 1, TREATED WITH 2.5# CCA.
- 3. TIMBER MEMBERS LOCATED ON OR ABOVE THE PIER DECKING SHALL BE SYP GRADE NO. 2, TREATED WITH 0.6# ACQ, UNLESS OTHERWISE NOTED.
- 4. ALL BOLTS, PLATES, AND MISCELLANEOUS METALS IN CONTACT WITH TIMBER TREATED WITH ACQ SHALL BE TYPE 316 STAINLESS STEEL OR HAVE PVC SLEEVES & PVC FLAT STOCK TO PREVENT HDG STEEL CONTACT WITH ACQ-PRESERVED TIMBER.
- 5. TIMBER DECKING SHALL BE FASTENED TO THE STRINGERS WITH #8 - 2½" LONG, WOOD SCREWS. MINIMUM 2 SCREWS EACH LOCATION PER STRINGER PER PLANK.
- 6. ALL PILE SUPPORTED CROSS BRACING TO BE 3x8 AND ATTACHED TO PILES WITH 1" DIA. HDG. THRU BOLTS.
- 7. CONTRACTOR SHALL PLACE 15# ASPHALT ROOFING FELT (TAR PAPER) BETWEEN HORIZONTAL TIMBER TO TIMBER OR CONCRETE INTERFACES AND ALL TIMBER TO STEEL INTERFACES.
- 8. EPOXY ADHESIVE FOR ANCHORS DRILLED AND SET IN CONCRETE SHALL BE HILTI HIT-RE 500 V3, OR APPROVED EQUIVALENT.

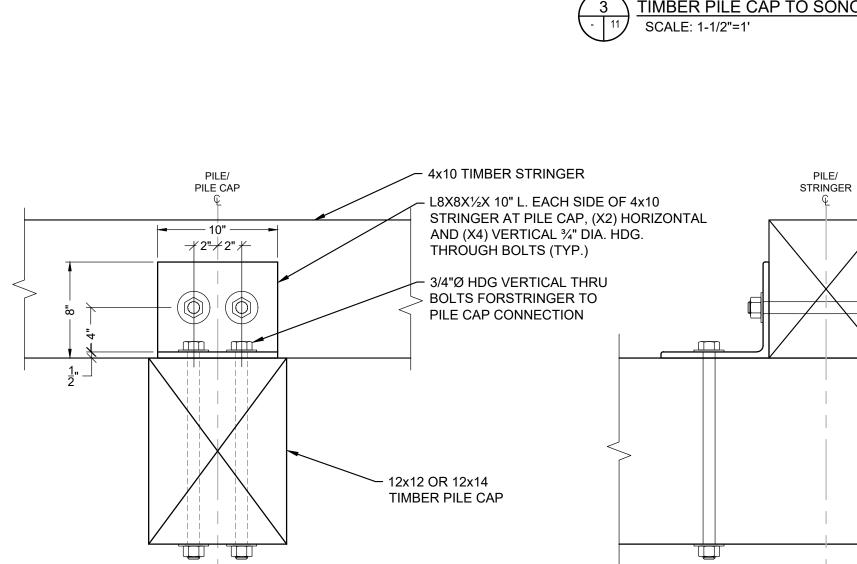


SECTION


INTERIOR STRINGER TO PILE CAP CONNECTION DETAILS SCALE: 1-1/2"=1'

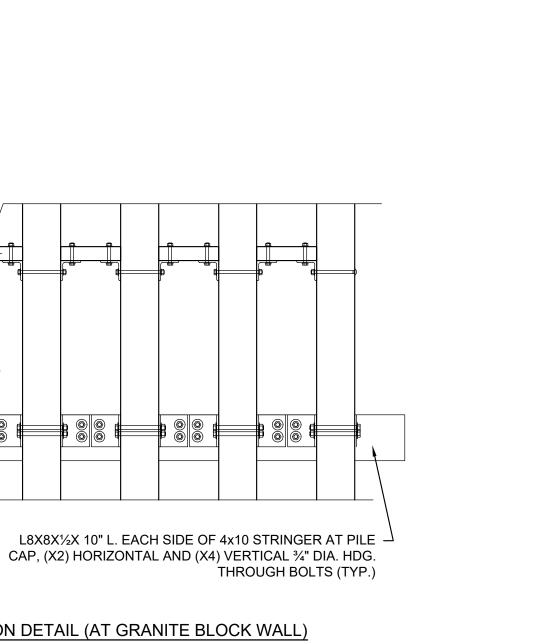




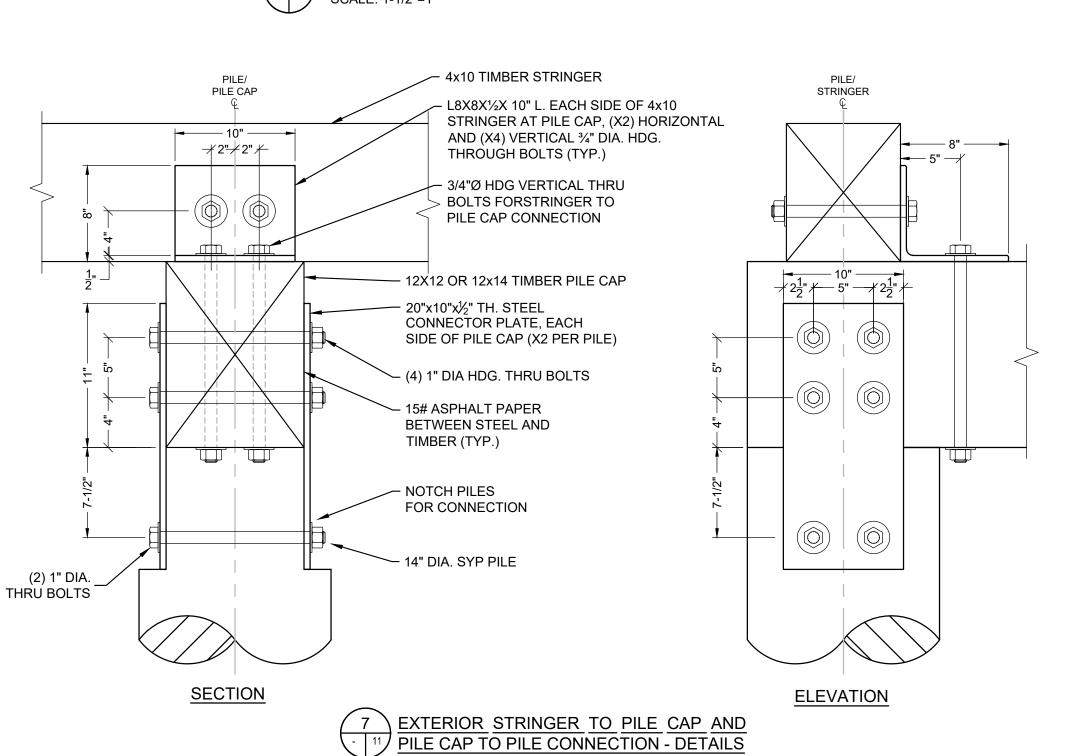

SCALE: 1-1/2"=1'

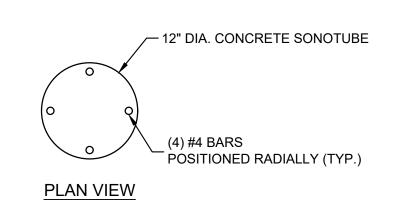

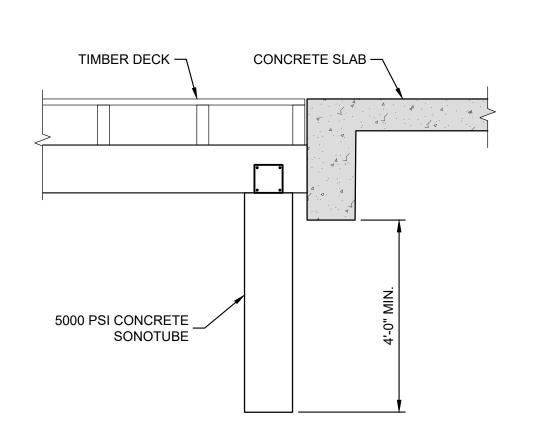


11 SCALE: 1" = 1'




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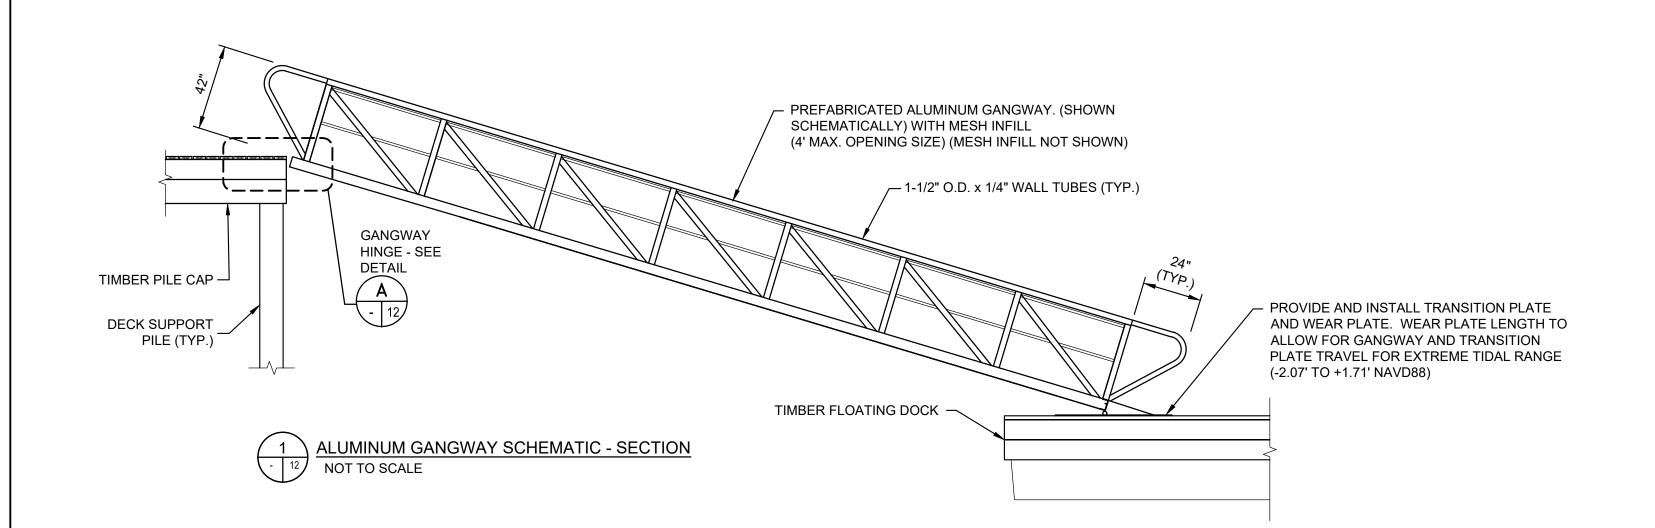



PROJECT NO: 35429.00 OCTOBER, 2025 PROJECT MGR: TWS DESIGNED BY: GRB DRAWN BY: CHECKED BY: REVIEWED BY:


REVISION NO.

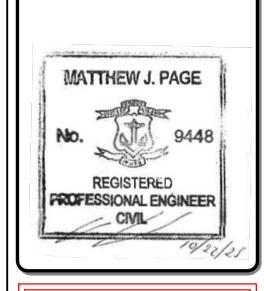
AS NOTED

DRAWING SHEET NO. 11 OF 15

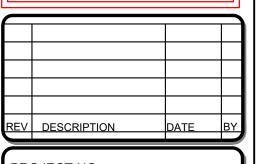

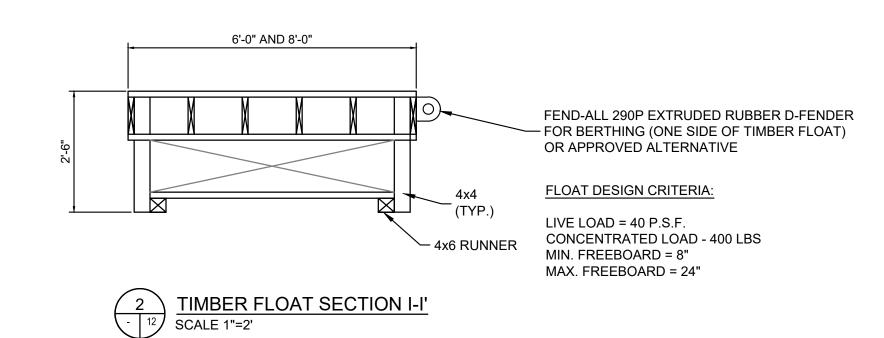

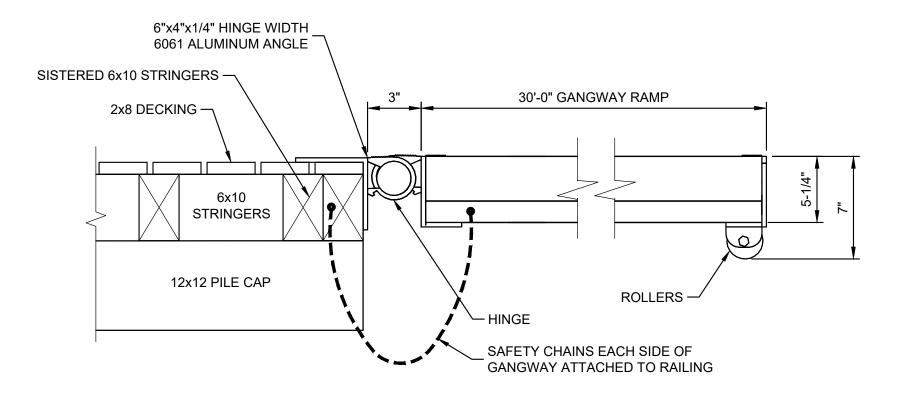


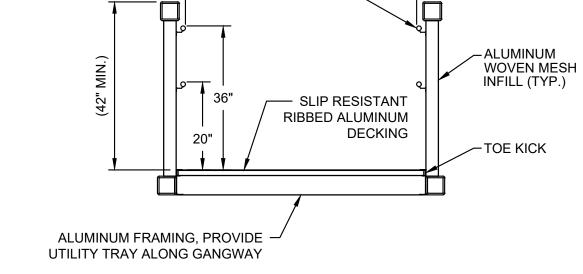

CLEAR WIDTH

(VARIES)

HANDRAIL (TYP.) -

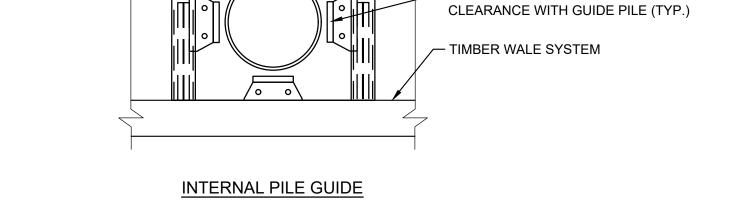

HDG PILE GUIDE ASSEMBLY


— GUIDE PILE (TYP.)

(DESIGNED BY FLOAT MANUFACTURER)

UHMW PAD WITH NEOPRENE CUSHION


- AND RETAINER BAR. PROVIDE 1"


TYPICAL GANGWAY - SECTION NOT TO SCALE

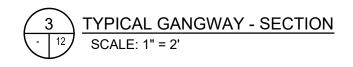


TYPICAL PILE GUIDE WITH UHMW PADS SCHEMATIC SCALE: 1" = 2'


FLOAT

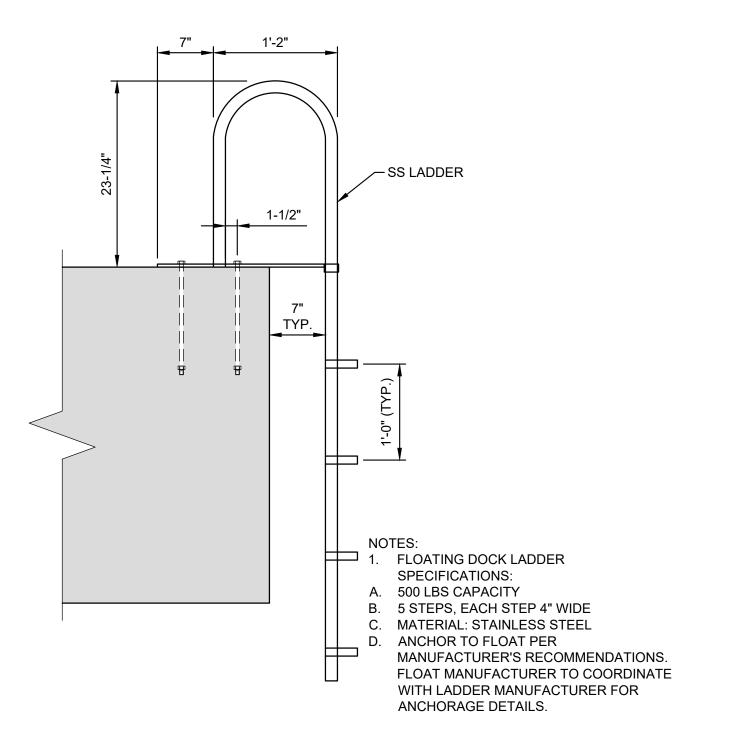

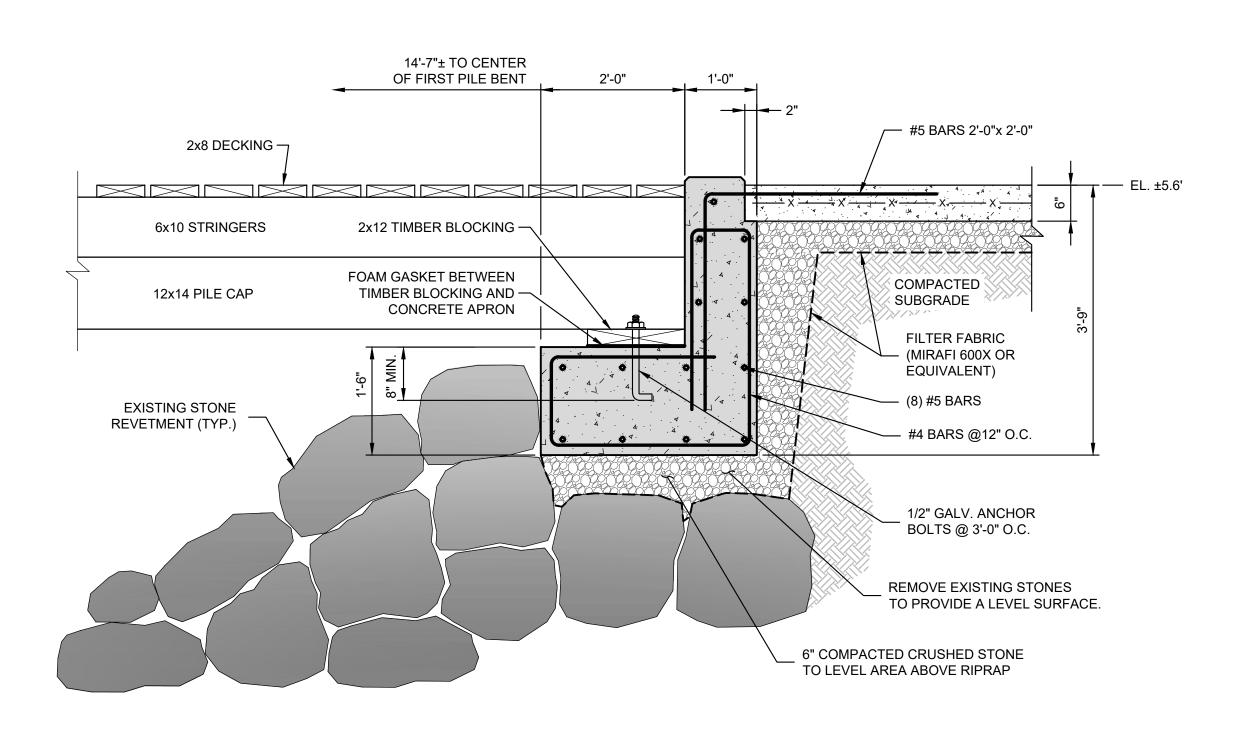

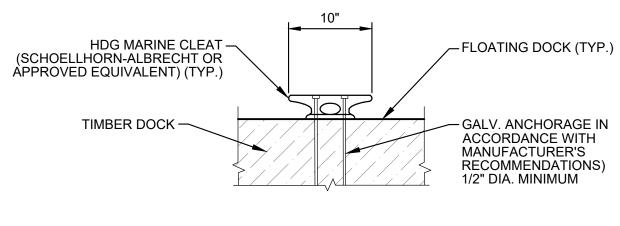

7 TYPICAL CLEAT DETAIL NOT TO SCALE

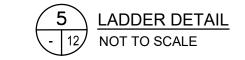









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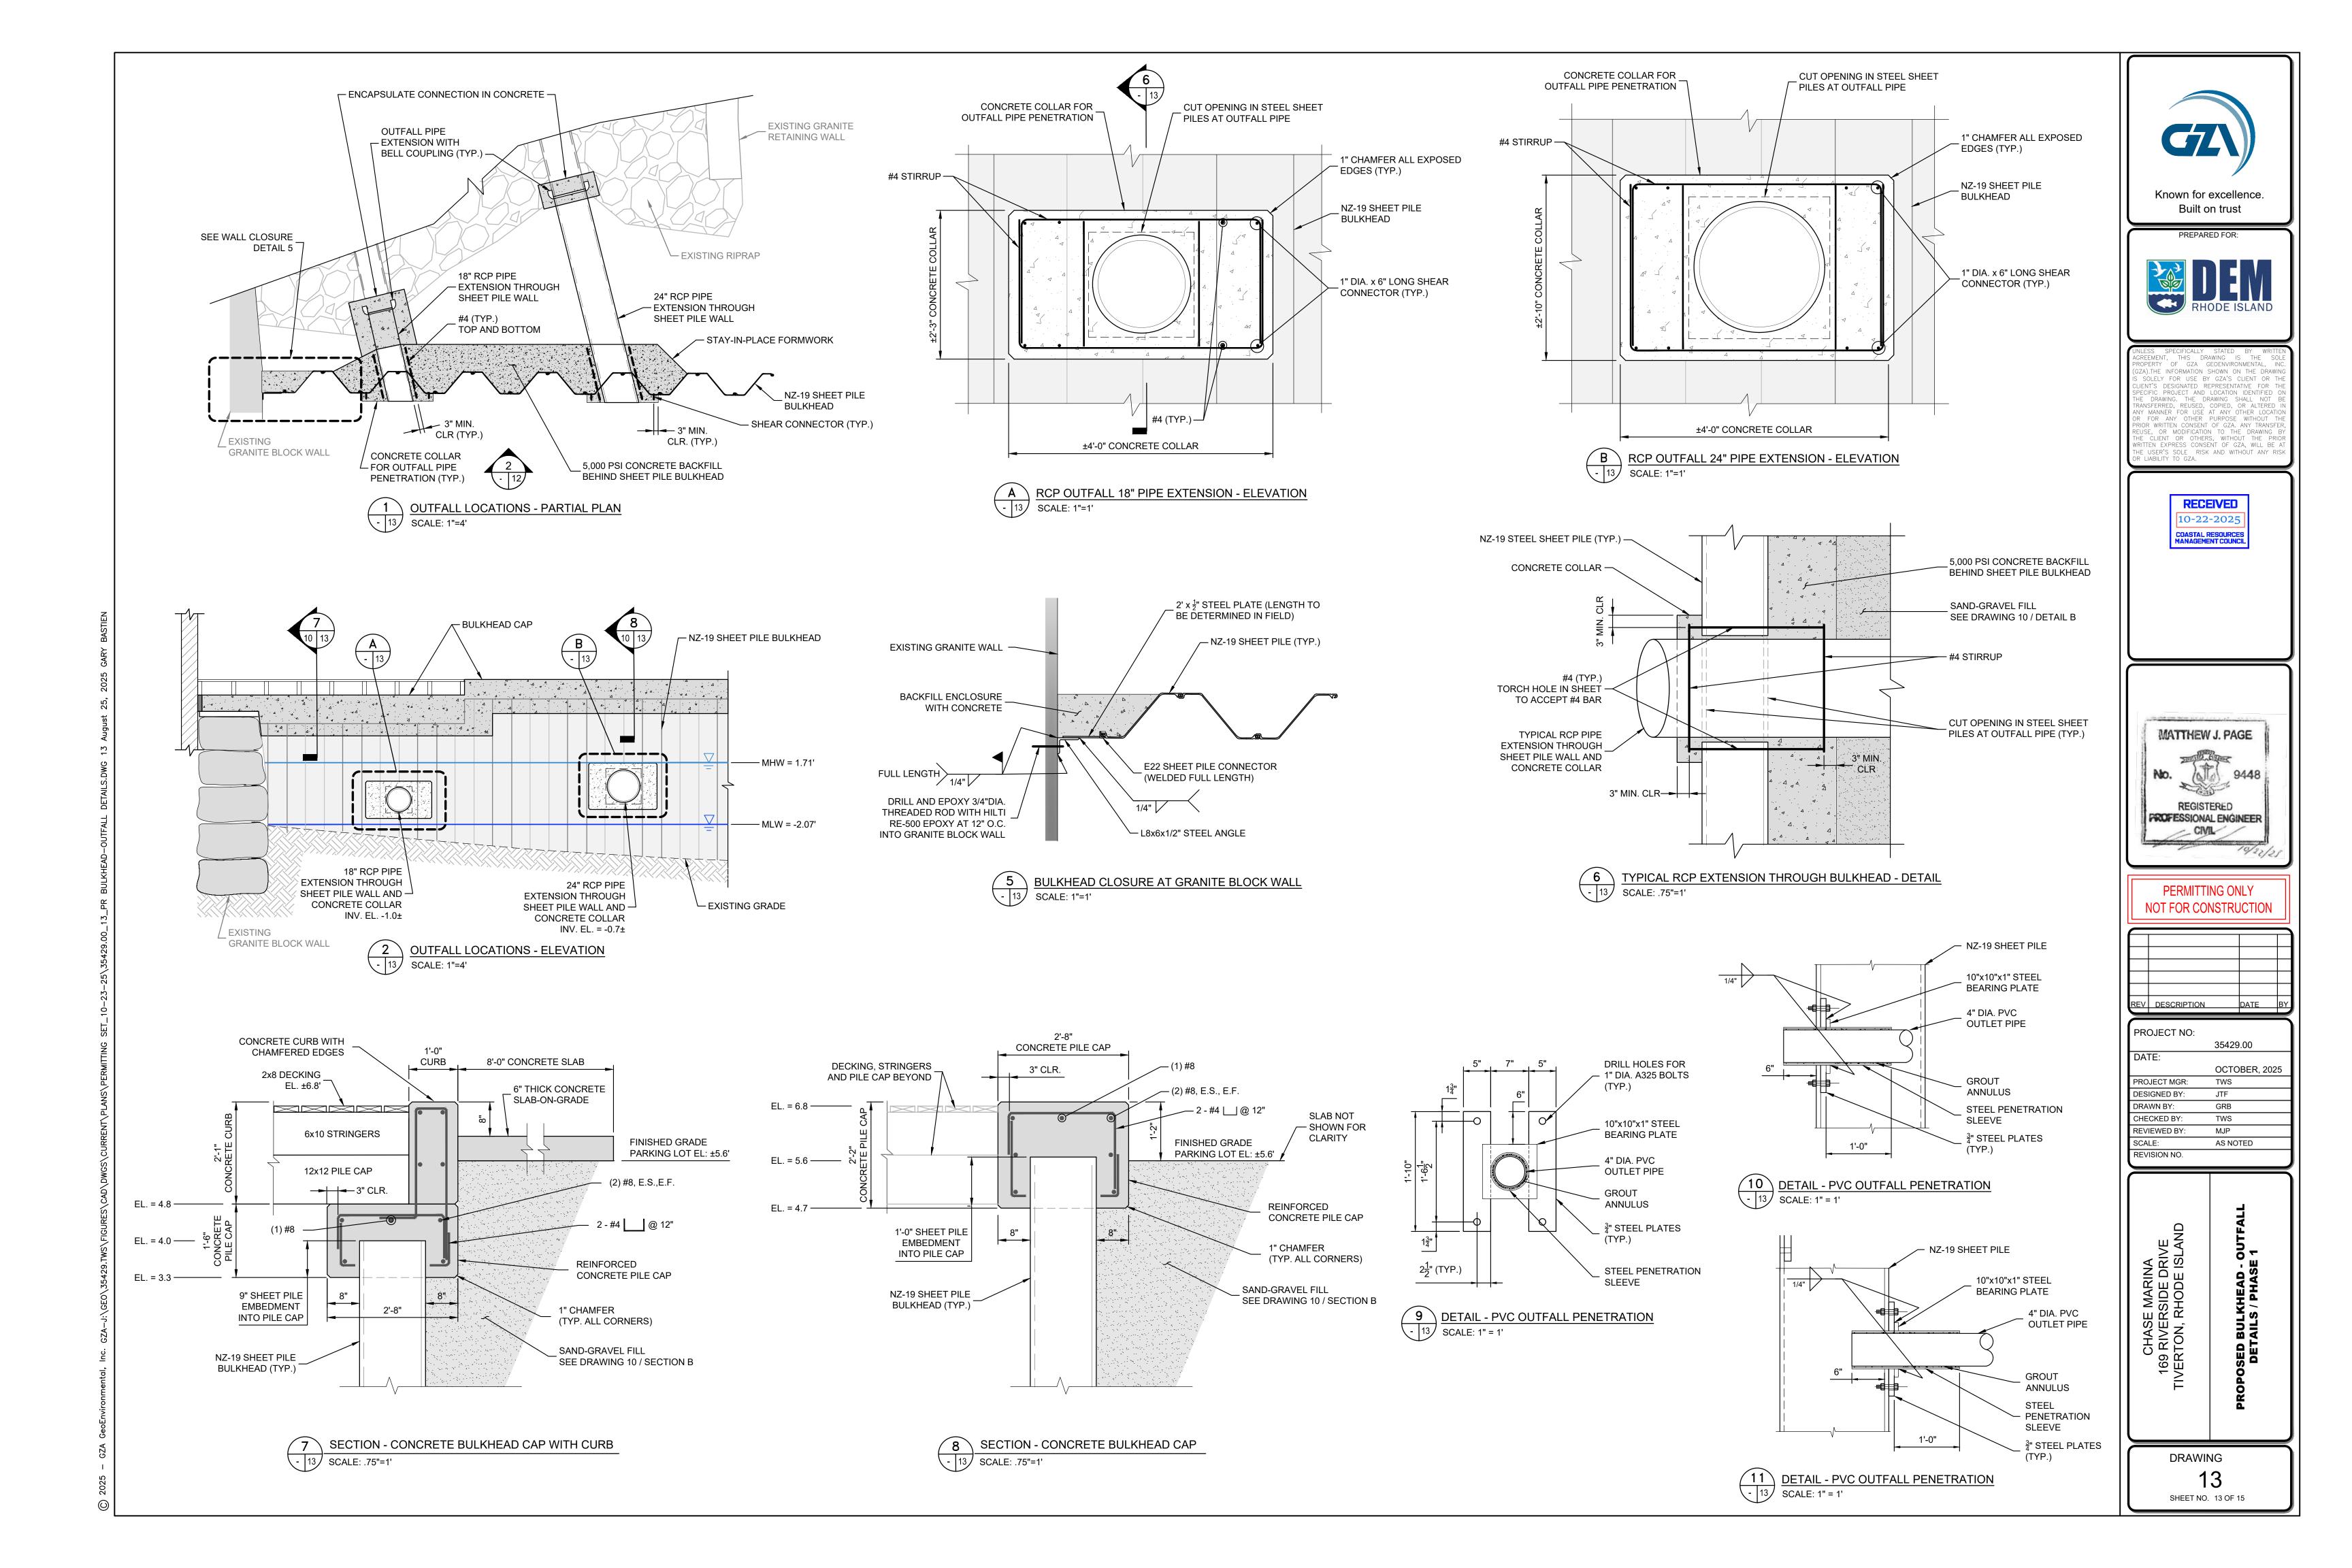



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DESIGNED BY:	JTF
DRAWN BY:	GRB
CHECKED BY:	TWS
REVIEWED BY:	MJP
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169 RIVERSIDE DRIVE IVERTON, RHODE ISLAND	OPOSED GANGWAY - DOCK
169 RIVER IVERTON, R	OPOSED GA

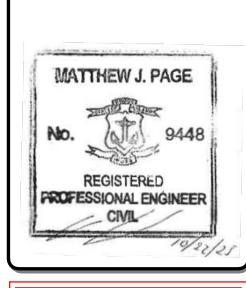
DRAWING

12
SHEET NO. 11 OF 15

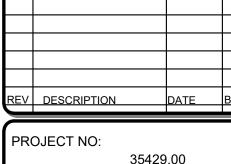




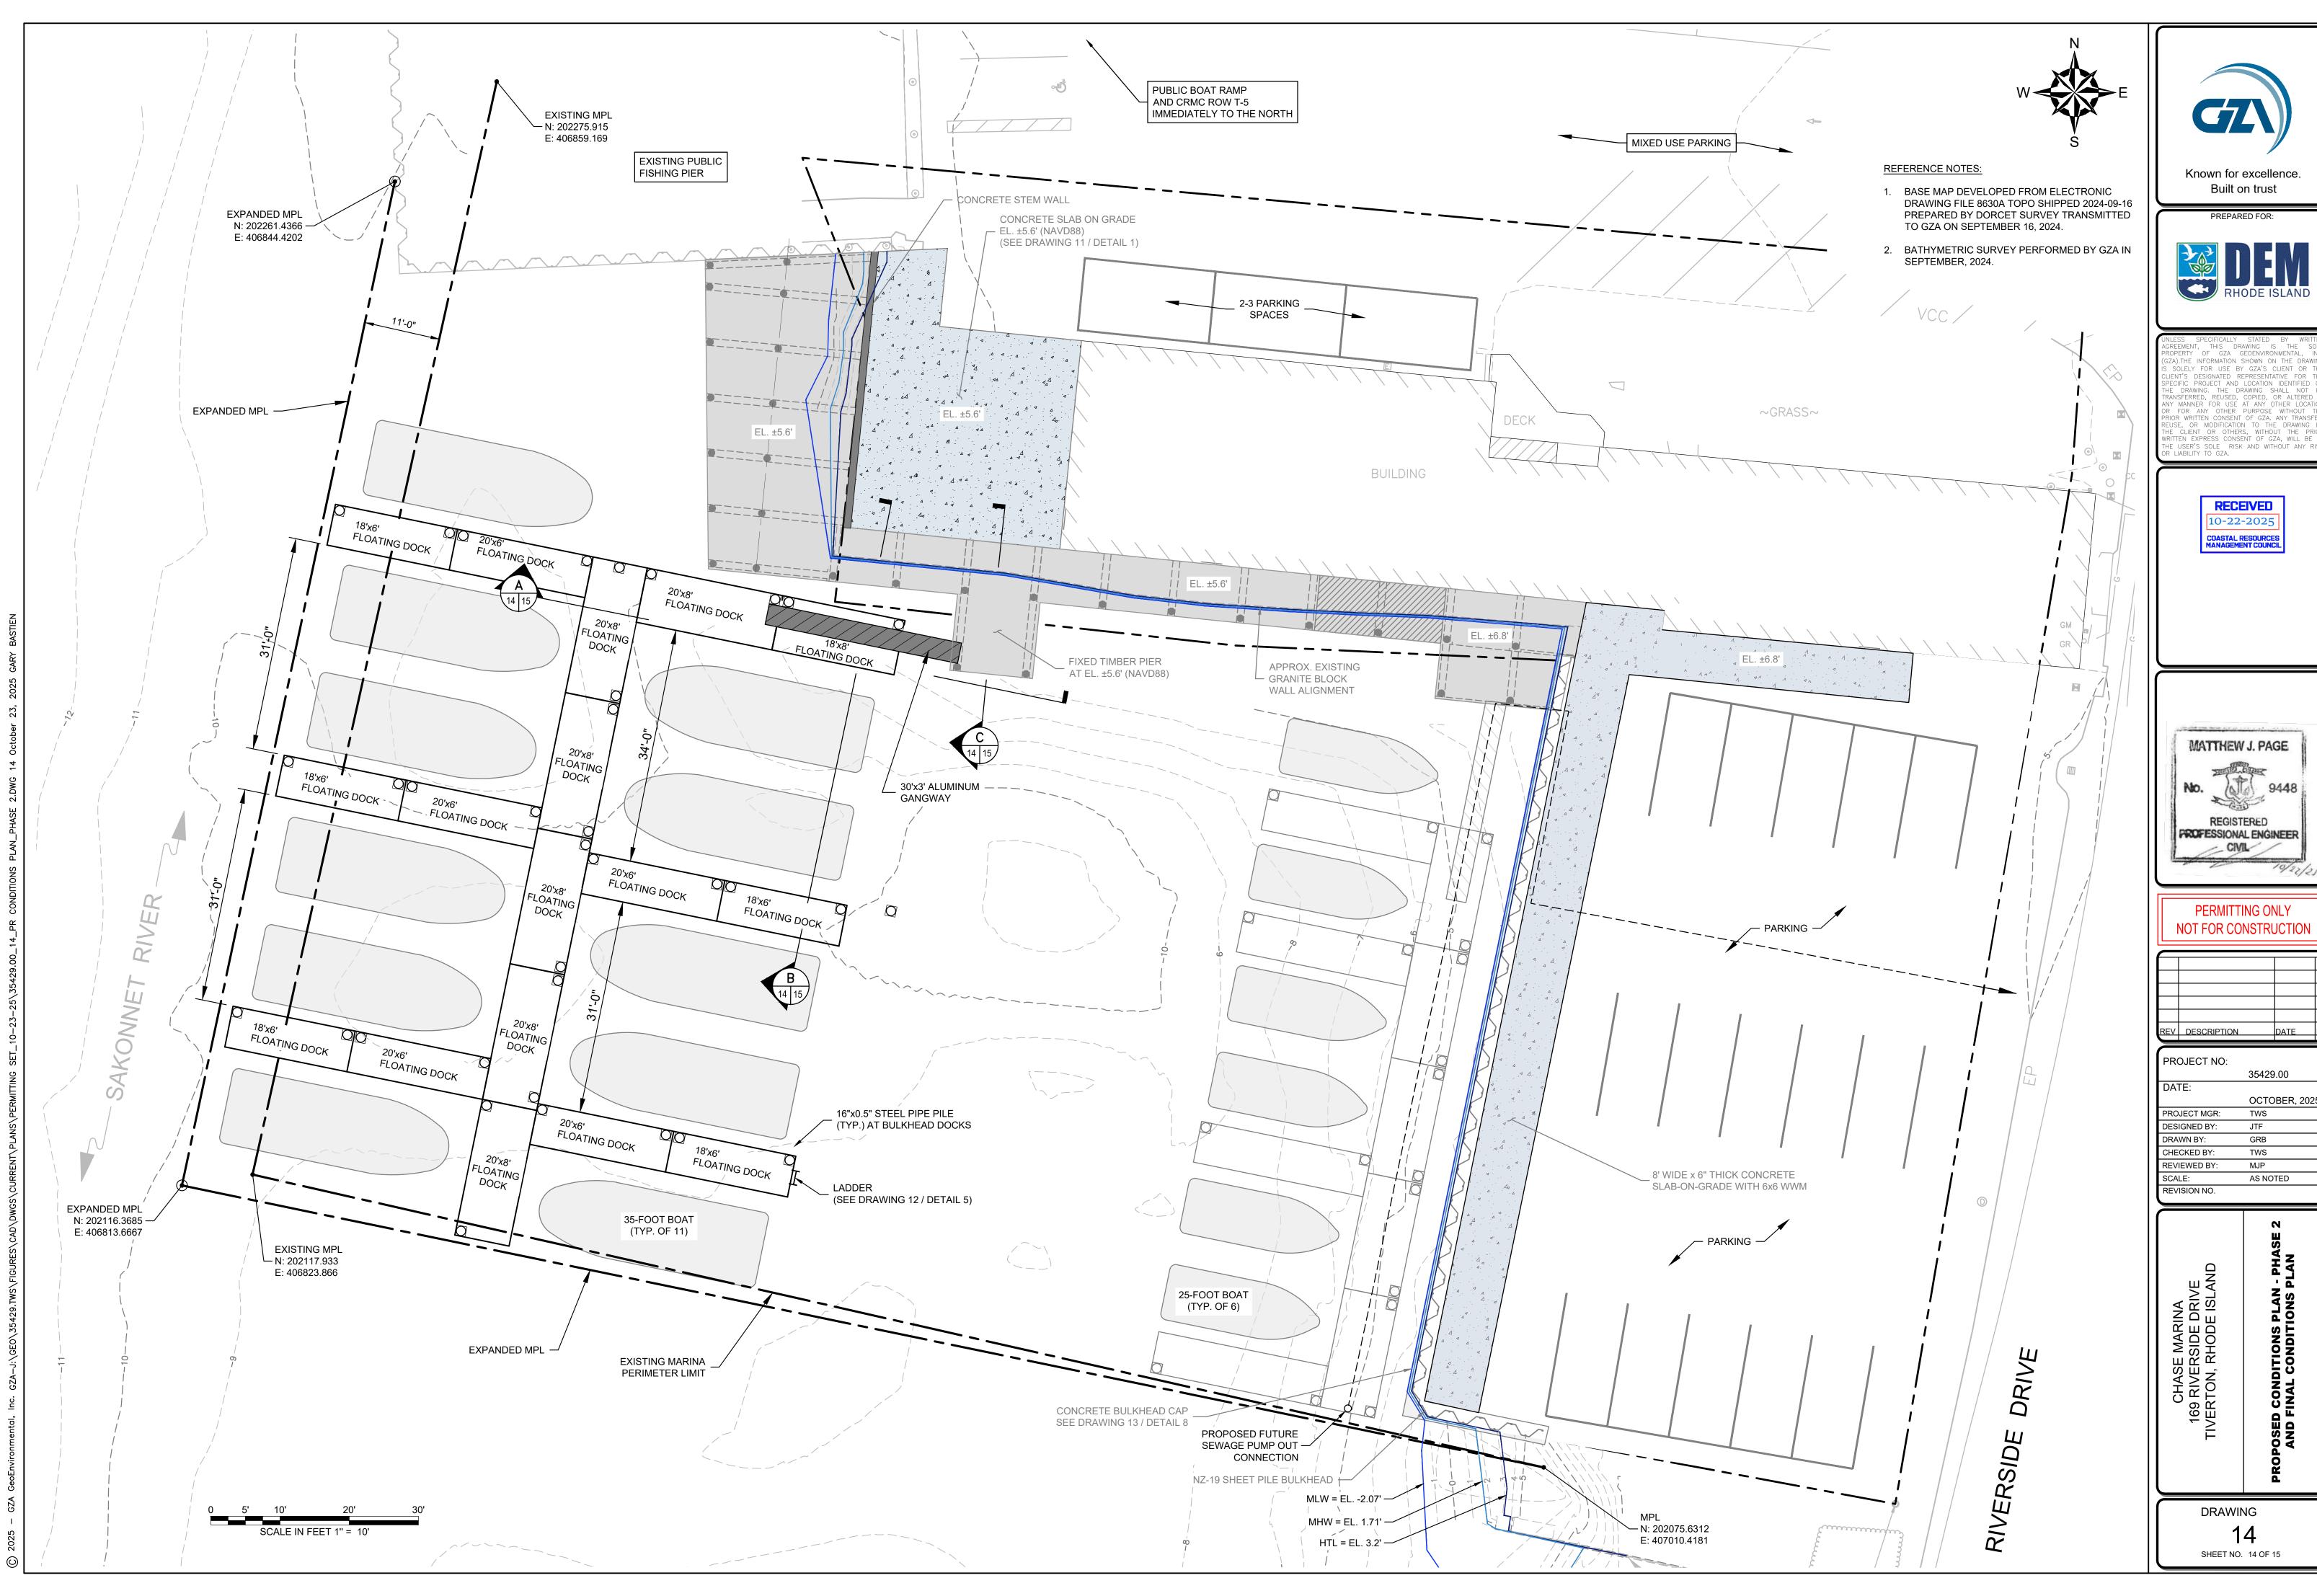

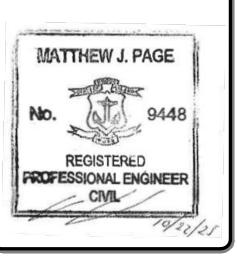


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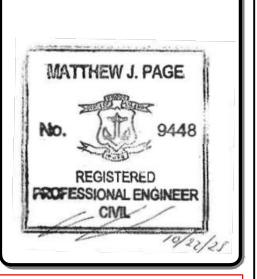


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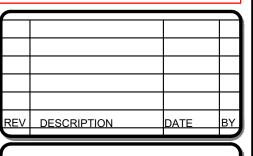
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DRAWN BY: GRB

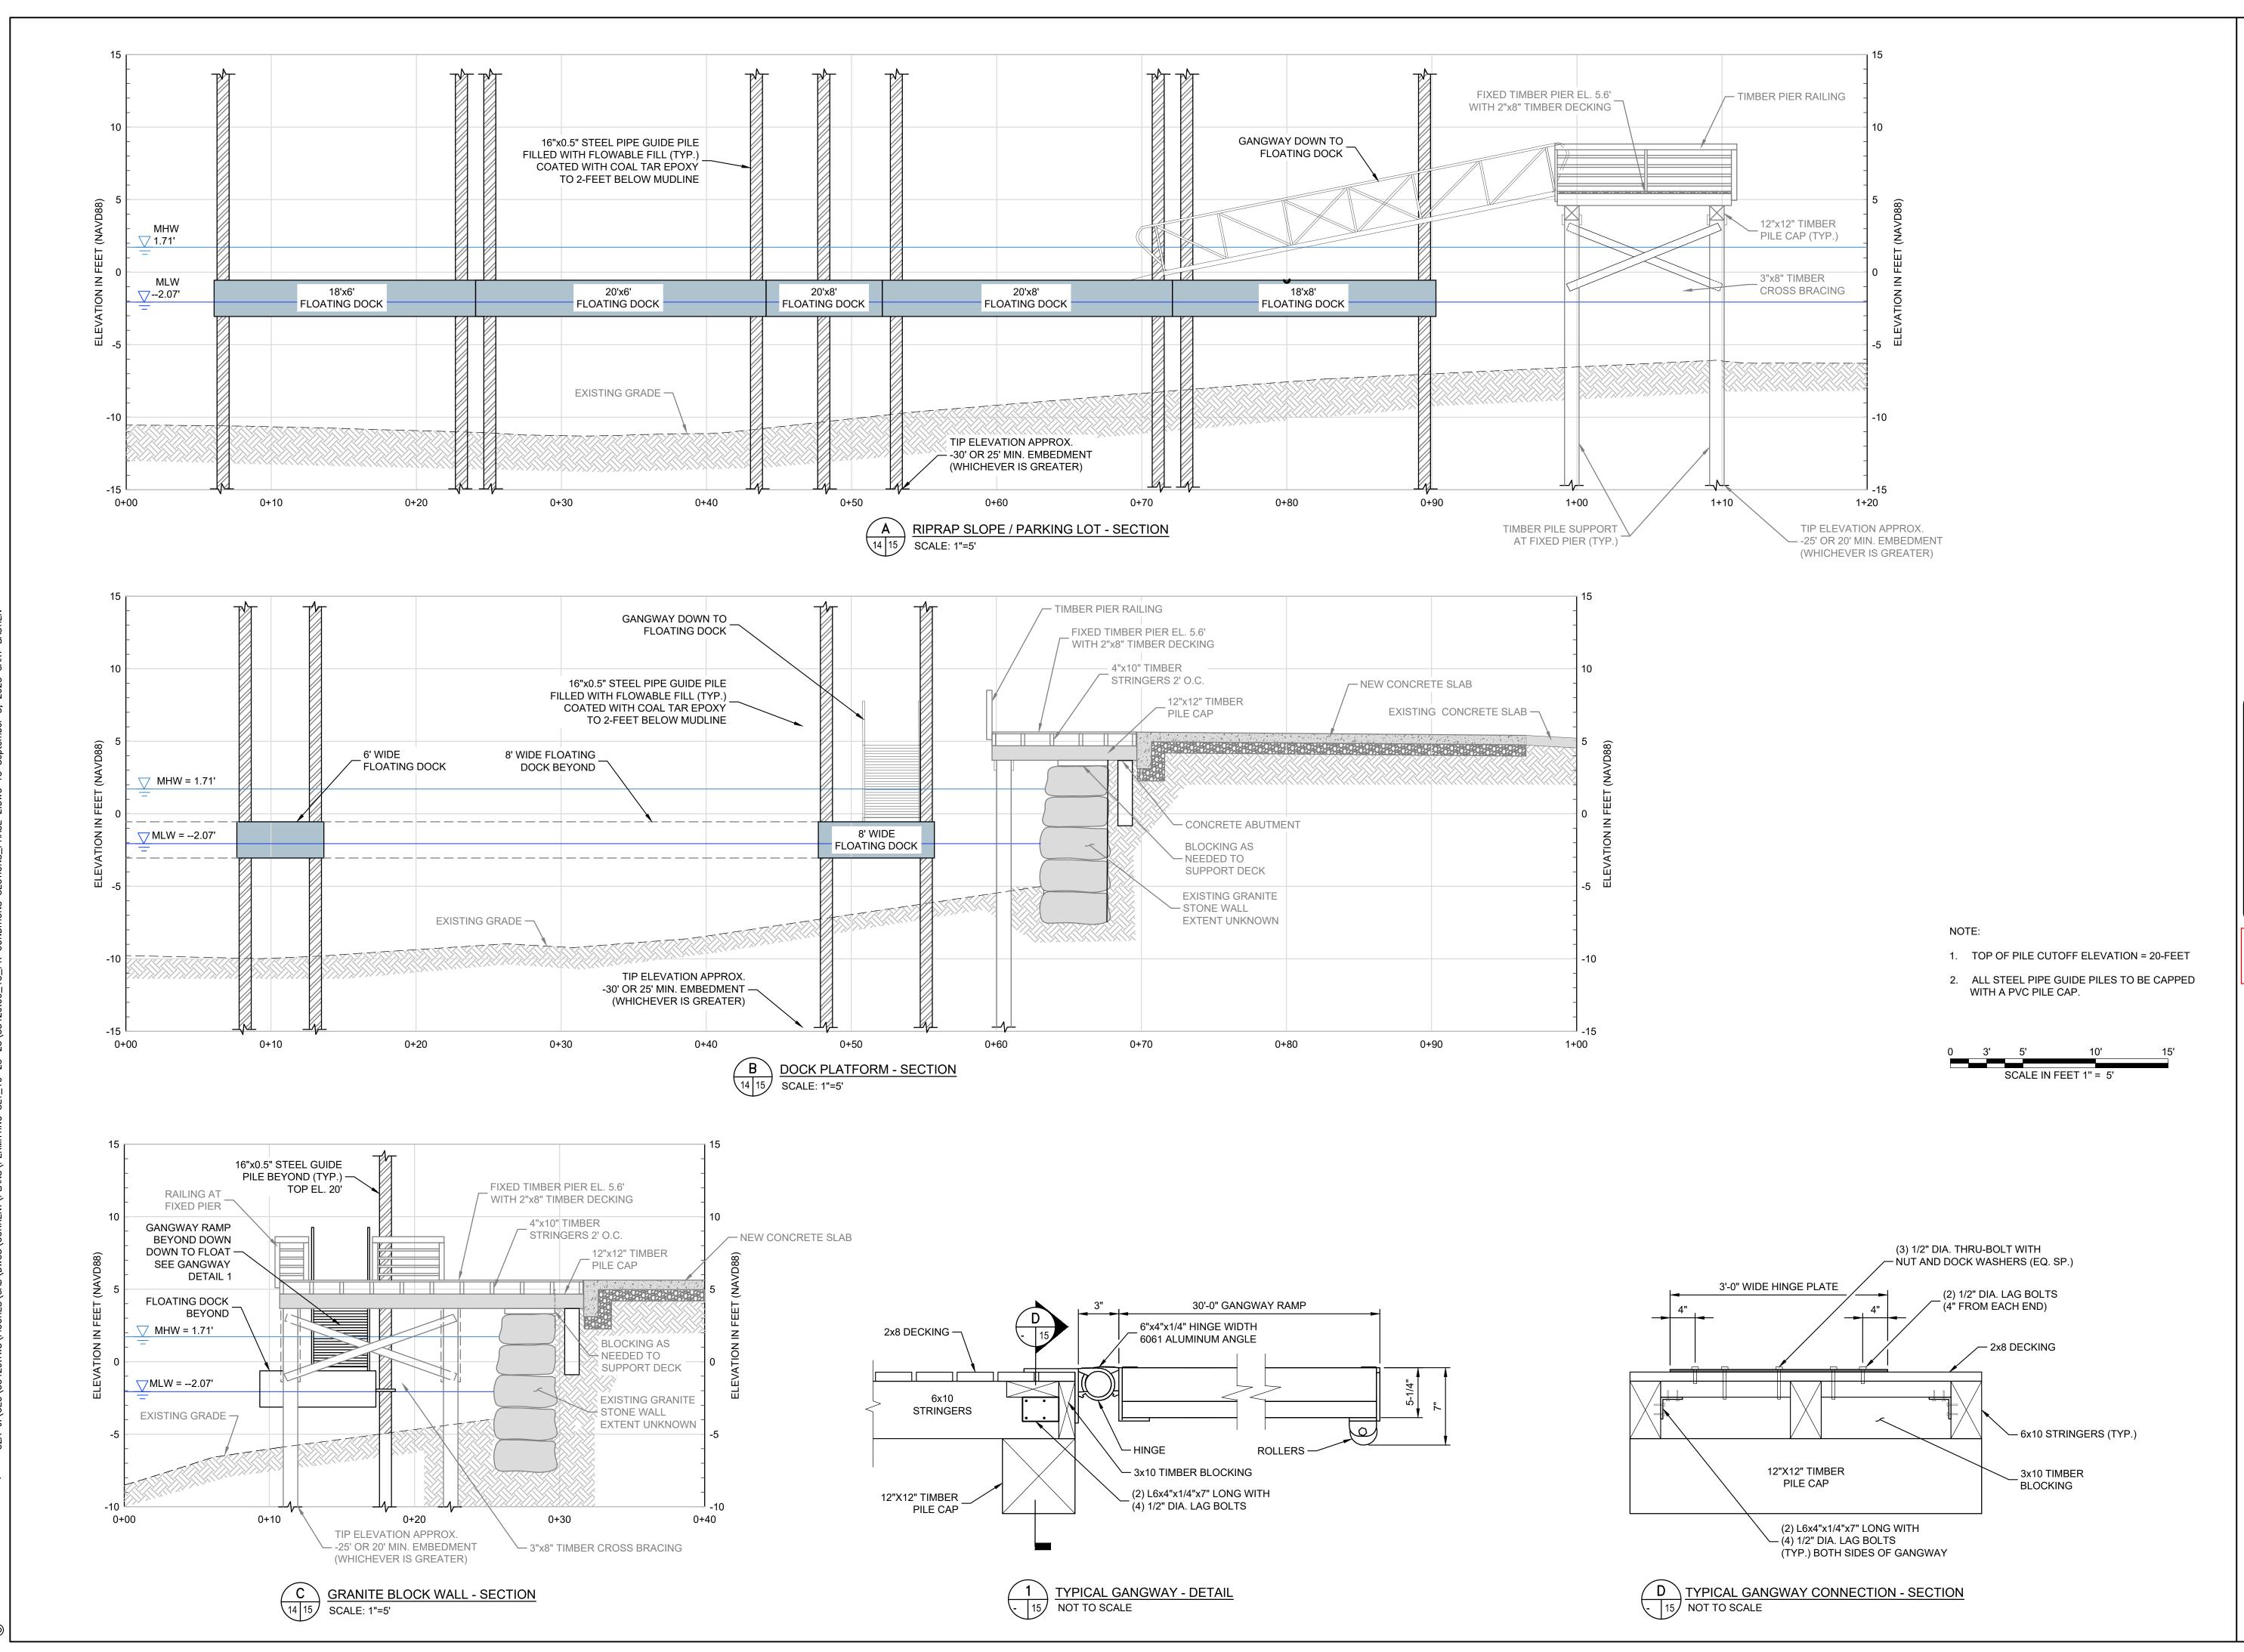CHECKED BY: TWS

REVIEWED BY: MJP

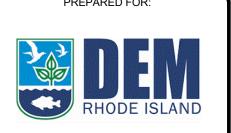SCALE: AS NOTED

REVISION NO.

TIVERTON, RHODE ISLAND

ROPOSED CONDITIONS SECTIONS
PHASE 2

DRAWING

15
SHEET NO. 15 OF 15